P:\Marietta\1866 Fayette County\1866.019 Veterans Pkwy at SR 92\Engineering\Design\1866.019\_Cover.dwg PROJECT NUMBER SHEET NO. TOTAL SHEETS 10/4/2019 11: 35: 21 AM COUNTY USER: Ravi Vachhani **FAYETTE** 1866.019 ### ### FAYETTE COUNTY LOCATION SKETCH BOARD OF COMMISSIONERS VETERANS PARKWAY AT SR 92 LAND LOT 256 OF THE 13TH DISTRICT, FAYETTE COUNTY, GEORGIA NOT TO SCALE PROJECT LOCATION NOTE: THE COORDINATES LISTED ARE WEST ZONE PROJECT PHASE: SIGNALIZATION HORIZONTAL DATUM: NAD 1983 MARN VERTICAL DATUM: NAVD 1988 FAYETTE COUNTY 2004 SPLOST PROJECT ID: R-5F PROJECT UNITS: ENGLISH PROJECT NO. 1866.019 PROJECT MAP SCALE: 1"=100' LIMITS OF CONSTRUCTION \_STA 152+66.14 BEGIN PROJECT STA 1+00.00 E: 2193535.5878 LIMITS OF CONSTRUCTION STA 1+27.30-(VETERANS PKWY) LIMITS OF CONSTRUCTION \_STA 16+05.00 (WESTBRIDGE RD) Know whats below. Call before youdig. INTERSECTION SR 92 = 154+38.22VETERANS PKWY = 8+00.00WESTBRIDGE  $RD = 10+00.00^{\circ}$ N: 1281866.0343 E: 2194002.1102 iii CROY COUNTY NO. LENGTH OF PROJECT 113 LIMITS OF CONSTRUCTION MILES STA 156+25.65-NET LENGTH OF ROADWAY 0.29 (SR 92) NET LENGTH OF BRIDGES 0.00 200 NORTH COBB PARKWAY, BLDG. 400, SUITE 413 MARIETTA, GA 30062 NET LENGTH OF PROJECT 0.29 PREPARED BY: PHONE: (770) 971-5407 FAX: (770) 971-0620 NET LENGTH OF EXCEPTIONS 0.00 0.29 GROSS LENGTH OF PROJECT DESIGN END PROJECT STA 16+05.00 N: 1282404.1760 E: 2194270.9587 UNDER THE ALL REFERENCES IN THIS DOCUMENT, WHICH INCLUDES ALL PAPERS, WRITINGS, DOCUMENTS DRAWINGS, SUPERVISION OF: CHRIS RIDEOUT, P.E. OF PHOTOGRAPHS USED, OR TO BE USED IN CONNECTION WITH THIS DOCUMENT, TO "STATE HIGHWAY THIS PROJECT IS LOCATED 100% IN FAYETTE COUNTY DEPARTMENT OF GEORGIA". "STATE HIGHWAY DEPARTMENT". "GEORGIA STATE HIGHWAY DEPARTMENT". DESIGN THIS PROJECT IS LOCATED 100% IN CONGRESSIONAL DISTRICT NO.13 "HIGHWAY DEPARTMENT". OR "DEPARTMENT" WHEN THE CONTEXT THEREOF MEANS THE STATE HIGHWAY DEPARTMENT OF GEORGIA MEAN, AND SHALL BE DEEMED TO MEAN THE DEPARTMENT OF PLANS COMPLETED: 10/04/2019 THIS PROJECT IS LOCATED 100% IN LAND DISTRICT 13 TRANSPORTATION. REVISIONS THE DATA, TOGETHER WITH ALL OTHER INFORMATION SHOWN ON THESE PLANS, OR IN ANY WAY SHEET NO. REQUESTED BY GSWCC NO. SIGNA TURE DATE PROJECT DESIGNATION: SIGNALIZATION INDICATED THEREBY, WHETHER BY DRAWINGS OR NOTES, OR IN ANY OTHER MANNER, ARE BASED UPON FIELD INVESTIGATIONS AND ARE BELIEVED TO BE INDICATIVE OF ACTUAL CONDITIONS. HOWEVER, THE PDP CLASSIFICATION: N/A SAME ARE SHOWN AS INFORMATION ONLY, ARE NOT GUARANTEED, AND DO NOT BIND THE FAYETTE PROJECT MIDPOINT FUNCTIONAL CLASSIFICATION: MINOR ARTERIAL COUNTY IN ANY WAY. THE ATTENTION OF THE BIDDER IS SPECIFICALLY DIRECTED TO ARTICLES 102.04, 102.05, AND 104.03 OF THE SPECIFICATIONS OF THE DEPARTMENT OF TRANSPORTATION, FAYETTE STA 7+63.31 COUNTY, FOR THE CONSTRUCTION OF ROADS AND BRIDGES, CURRENT EDITION, AND ANY MODIFICATIONS N 1281825.7698 FEDERAL ROUTE NO. N/A THEREOF, WHICH WILL BE A PART OF THIS CONTRACT. E 2193996.5795 STATE ROUTE NO. ALL WORK TO BE DONE IN ACCORDANCE WITH THE SPECIFICATIONS OF THE DEPARTMENT OF TRANSPORTATION OF GEORGIA, CURRENT EDITION. AS APPROVED BY THE FEDERAL HIGHWAY

ADMINISTRATION. - AND, AS MODIFIED BY CONTRACT DOCUMENTS.

DWG NO.	DESCRIPTION
(4.04)	001/50
(1-01)	COVER
(2-01)	INDEX
(3–01)	REVISION SUMMARY
(4-01)	GENERAL NOTES
(5-01)	TYPICAL SECTION
(6-01 TO 6-02)	SUMMARY OF QUANTITIES
(13-01 TO 13-03)	MAINLINE PLANS
(15-01 TO 15-02)	MAINLINE PROFILES
(18-01 TO 18-03)	SPECIAL GRADING PLANS
(23-01 TO 23-04)	CROSS SECTIONS
(24-01 TO 24-03)	UTILITY PLANS
•	
(26-01 TO 26-03)	SIGNING AND MARKING PLANS
(27–00)	TRAFFIC SIGNAL GENERAL NOTES
(27-01 TO 27-03)	SIGNAL PLAN
(52-01 TO 52-07)	EROSION CONTROL PLAN - LEGEND AND UNIFORM CODE
(54-01 TO 54-09)	EROSION CONTROL PLAN — BMP LOCATION DETAILS
(56-01 TO 56-02)	EROSION CONTROL PLAN — CONSTRUCTION STANDARDS & DETAILS
(60-00 TO 60-01)	RIGHT OF WAY PLANS
	CONSTR DETAILS — (A-3) CONC SIDEWALK DETAILS, CURB CUT RAMPS (09-16)
	CONSTR DETAILS - (P-7) PAVEMENT EDGE TREATMENT ASPHALT AND CONCRETE PAVEMENT (11-11)
	CONSTR DETAILS - (T-1) DETAILS OF SIGN PLATES (01-00)
	CONSTR DETAILS - (T-2) DETAILS FOR TYPICAL FRAMING (03-00)
	CONSTR DETAILS - (T-3A) TYPE 7, 8 & 9 SQUARE TUBE POST INSTALLATION DETAIL (07-02)
	CONSTR DETAILS - (T-5A) DETAILS OF REGULATORY SIGNS (01-03)
	CONSTR DETAILS - (T-5B) DETAILS OF REGULATORY SIGNS (01-00)
	CONSTR DETAILS - (T-5C) DETAILS OF WARNING SIGNS (01-00)
	CONSTR DETAILS - (T-30) DETAILS OF WARNING SIGNS (OT-00)  CONSTR DETAILS - (T-11A) DETAILS OF PVM'T MARKING PLACEMENT ON NON-LIMITED ACCESS ROADWAY (09-16)
	CONSTR DETAILS - (T-12A) DETAILS OF PVM'T MARKING - ARROW LOCATION (01-00)
	CONSTR DETAILS - (T-12B) DETAILS OF PVM'T MARKING - ARROWS (04-00)
	CONSTR DETAILS - (T-14) DET OF PAVEMENT MARKING HATCHING (11-08)
	CONSTR DETAILS - (T-15A) DET OF RAISED PVM'T MARKER LOC NON-LIMITED ACCESS ROADWAY (09-16)
	CONSTR DETAILS - (T-15B) DETAILS OF RAISED PAVEMENT MARKER LOCATION LIMITED ACCESS ROADWAY (09-16)
	CONSTR DETAILS - (T-15C) DETAILS OF RAISED PVM'T MARKERS (09-11)

CROY REFERENCE NUMBER	COUNTY	PROJECT NUMBER	SHEET NO.	TOTAL SHEETS
1866.019	FAYETTE	1866.019	###	###

	DESCRIPTION
	GEORGIA STANDARD 1011A - STANDARD BRICK MANHOLES (10-81)
	GEORGIA STANDARD 1011AP - PRECAST REINFORCED CONCRETE MANHOLE (06-75)
	GEORGIA STANDARD 1120 - FLARED END SECTIONS FOR PIPES (06-06)
	GEORGIA STANDARD 1401 - PAVEMENT PATCHING DETAILS (STORM OR UTILITY INSTALLATIONS BY OPEN CUT) (08-99)
	GEORGIA STANDARD 4000W -GUARDRAIL WARRANT GUIDES (01-16)
	GEORGIA STANDARD 4380 - "W" BEAM GUARDRAIL 31 INCH GUARDRAIL HEIGHT (01-16)
	GEORGIA STANDARD 4381 - POSTS AND OFFSET BLOCKS FOR "W" (01-16)
	GEORGIA STANDARD 4383 — GUARDRAIL ANCHORAGE TYPE 1 31 IN GUARDRAIL HEIGHT (08-11)
	GEORGIA STANDARD 4384 — GUARDRAIL TERMINALS, TYPE 12A, 12B, AND 12C 31 INCH GUARDRAIL HEIGHT (01-16)
	GEORGIA STANDARD 4390 - "W" BEAM GUARDRAIL TRANSITION 27 INCH GUARDRAIL TO 31 INCH GUARDRAIL (01-16
	GEORGIA STANDARD 9003 - DETAILS OF MARKERS - FEDERAL AID & STATE RIGHT OF WAY MARKERS (04-06)
	GEORGIA STANDARD 9031H - DETAIL OF TURNOUTS - RURAL (10-87)
	GEORGIA STANDARD 9031U - JUNCTION BOXES (PRECAST OR BUILT-IN-PLACE) PIPE COLLARS (07-85)
	GEORGIA STANDARD 9100 - TRAFFIC CONTROL GEN. NOTES. STD. LEGEND, MISC. DETAILS (03-06)
	GEORGIA STANDARD 9102 - TRAFFIC CONTROL DETAIL FOR LANE CLOSURE ON TWO-LANE HIGHWAY (03-06)
	EROSION CONTROL CONSTRUCTION DETAILS
	CONSTR DETAILS - (D-20) SILT CONTROL GATES FOR STRUCTURES TYPE-1,2, AND 3 (04-16)
	CONSTR DETAILS - (D-24A) TEMPORARY SILT FENCE (SHEET 1 OF 4) (01-11)
	CONSTR DETAILS - (D-24C) TEMPORARY SILT FENCE J-HOOKS, INLET SEDIMENT TRAPS (SHEET 3 OF 4) (01-11)
	CONSTR DETAILS - (D-41) CONSTRUCTION EXIT (04-18)
	CONSTR DETAILS - (D-41) CONSTRUCTION EXIT (04-18)  CONSTR DETAILS - (D-42) INLET SEDIMENT TRAPS (05-08)
	CONSTR DETAILS - (D-42) INCET SEDIMENT TRAPS (05-08)  CONSTR DETAILS - (D-46) STONE FILTER RING (07-18)
	CONSTR DETAILS — $(D-55A)$ RIPRAP OUTLET PROTECTION (SHEET 1 OF 2) $(04-16)$ CONSTR DETAILS — $(D-55B)$ RIPRAP OUTLET PROTECTION (SHEET 2 OF 2) $(04-16)$
	TANDARDS AND CONSTRUCTION DETAILS REQUIRED FOR THIS PROJECT ARE LISTED IN THE INDEX WITH
	·
	T REVISION DATES BUT ARE NOT INCLUDED AS PART OF THE PLANS. THE CONTRACTOR SHALL BE
	LE FOR OBTAINING THE STANDARDS AND CONSTRUCTION DETAILS SHOWN IN THE INDEX AND G ON THE PROJECT SITE. FULL SIZE PRINTS MAY BE PURCHASED BY THE CONTRACTOR FROM THE
<u>AUTIAINII</u> Y	S ON THE INCOLOR SHE. FULL SIZE ININIS MAI DE FUNCHASED DI THE CUNTRACTUR FRUM THE

200 NORTH COBB PARKWAY, BLDG. 400, SUITE 413

MARIETTA, GA 30062

PHONE: (770) 971–5407 FAX: (770) 971–0620

THESE PLANS AND DRAWINGS ARE NOT TO BE REPRODUCED, CHANGED OR COPIED IN ANY FORM OR MANNER WHATSOEVER WITHOUT FIRST OBTAINING THE EXPRESS WRITTEN PERMISSION AND CONSENT OF CROY ENGINEERING, LLC, NOR ARE THEY TO BE ASSIGNED TO ANY PARTY WITHOUT WRITTEN PERMISSION AND CONSENT.

GEORGIA DEPARTMENT OF TRANSPORTATION.

FAYETTE COUNTY	
VETERANS PARKWAY AT SR 92	SR 92
	DRAWING N
- $NDEX$ 02	02-03

				CROY REFERENCE NU 1866.019	JMBER COUNTY FAYETTE	PROJECT NUMBER 1866.019	SHEET NO.
DATE	SHEET	DESCRIPTION	DATE	SHEET	DESCRIPTION		
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			THESE PLANS WHATSOEV	ND DRAWINGS ARE NOT TO BE REPRODUCED, CHANGED OR COPIED IN ANY R WITHOUT FIRST OBTAINING THE EXPRESS WRITTEN PERMISSION AND COI , NOR ARE THEY TO BE ASSIGNED TO ANY PARTY WITHOUT WRITTEN PERMI	FURM OR MANNER SENT OF CROY		RY (

TOTAL SITE AREA = 2.30 AC TOTAL AREA TO BE DISTURBED = 0.95 AC

- 1. ALL WORK SHALL BE DONE IN ACCORDANCE WITH FAYETTE COUNTY STANDARDS AND THE GEORGIA DEPARTMENT OF TRANSPORTATION STANDARD AND SUPPLEMENTAL SPECIFICATIONS, CURRENT EDITION.
- 2. ALL KNOWN UTILITY FACILITIES ARE SHOWN SCHEMATICALLY ON PLANS, AND ARE NOT NECESSARILY ACCURATE IN LOCATION AS TO PLAN OR ELEVATION. UTILITY FACILITIES SUCH AS SERVICE LINES OR UNKNOWN FACILITIES NOT SHOWN ON PLANS WILL NOT RELIEVE THE CONTRACTOR OF THEIR RESPONSIBILITY UNDER THIS REQUIREMENT. "EXISTING UTILITY FACILITIES" MEANS ANY UTILITY THAT EXISTS ON THE PROJECT IN ITS ORIGINAL, RELOCATED OR NEWLY INSTALLED POSITION.
- 3. THE FOLLOWING UTILITIES HAVE FACILITIES IN THE PROJECT AREA:

ANDRE WALTON (404) 218-4468

2. COMCAST CABLE ARNEY REGINALD

(678) 878-5541

3. COWETA EMC

(770) 252-7486

4. ZAYO COMMUNICATIONS RUSTY PERDIEU

(678) 275-8288

5. FAYETTE WATER JAMES MUNSTER

GUY BLANCHARD

(770) 320-6082

- 4. INGRESS AND EGRESS SHALL BE MAINTAINED AT ALL TIMES TO ADJACENT PROPERTIES. REFER TO SUB-SECTION 107.07 OF THE GEORGIA STANDARD SPECIFICATIONS.
- 5. RIGHT-OF-WAY MARKERS IN RESIDENTIAL LAWN AND DEVELOPED COMMERCIAL AREAS SHALL BE PLACED FLUSH WITH THE FINISHED SURFACE.
- 6. IT SHALL BE THE CONTRACTORS RESPONSIBILITY TO FURNISH SUITABLE BORROW MATERIAL FOR THE PROJECT AND TO DISPOSE OF ANY UNSUITABLE OR WASTE MATERIAL IN COMPLIANCE WITH ALL LOCAL STATE AND FEDERAL REGULATIONS. CONCRETE AND ASPHALT MATERIALS REMOVED FROM THE PROJECT SITE MAY NOT BE PLACED IN FILL LOCATIONS THAT FALL WITHIN THE EASEMENT AREAS. WITH THE PRIOR APPROVAL OF THE ENGINEER, THESE MATERIALS MAY BE PLACED WITHIN THE R/W PROVIDED THERE IS THREE (3') FEET OF MINIMUM COVER AND THERE ARE NO PLANS FOR THE FUTURE WIDENING OF THE ROADWAY.
- 7. PERFORATED UNDERDRAIN SHALL BE PLACED IN AREAS WHERE WET CONDITIONS EXIST IN THE SUBGRADE AS DIRECTED BY THE ENGINEER.
- 8. STRUCTURES, TREES, SHRUBS AND OTHER PLANT MATERIAL THAT FALL WITHIN THE RIGHT-OF-WAY AND EASEMENT LIMITS, BUT OUTSIDE THE LIMITS OF CONSTRUCTION, SHALL NOT BE DISTURBED UNLESS DIRECTED BY THE ENGINEER.
- THE CONTRACTOR SHALL OBSERVE ALL APPLICABLE LOCAL, STATE AND FEDERAL SAFETY REGULATIONS REGARDING PIPE INSTALLATION IN TRENCHES. NO SEPARATE PAYMENT WILL BE MADE FOR ANY COST INCURRED TO COMPLY WITH THIS REQUIREMENT.
- 10. ALL EXISTING PIPE NO LONGER IN USE SHALL BE REMOVED UNLESS OTHERWISE NOTED ON PLANS OR AS DIRECTED BY THE ENGINEER. REMOVAL OF PIPE SHALL BE INCLUDED IN PRICE BID FOR "GRADING COMPLETE".
- 11. IN AREAS WHERE NEW PAVEMENT OR PAVEMENT WIDENING IS REQUIRED. SAW CUT OF EXISTING PAVEMENT WILL BE REQUIRED IN ACCORDANCE WITH SECTION 411 OF THE GEORGIA STANDARD SPECIFICATIONS AND WILL BE INCLUDED IN PRICE BID FOR "GRADING COMPLETE"
- 12. ALL RETAINING WALLS SHALL HAVE ASHLAR STONE FORM LINER OR OTHER FORM LINER AS DIRECTED. THIS APPLIES TO ALL RETAINING WALL FACES EXPOSED TO PUBLIC VIEW. ALL RETAINING WALL EXPOSED FACES SHALL HAVE ANTI-GRAFFITI COATING. THE ASHLAR FINISH AND ANTI-GRAFFITI COATING SHALL BE INCLUDED IN THE PRICE OF THE WALL.
- 13. ALL DRIVEWAYS SHALL BE MAINTAINED DURING CONSTRUCTION. ALL DRIVEWAYS TO BE CONSTRUCTED SHALL BE REPLACED IN KIND I.E. ASPHALT FOR ASPHALT, CONCRETE FOR CONCRETE ETC. ANY OTHER DRIVEWAY MATERIAL OR SPECIALIZED DRIVEWAY WILL NOT BE REPLACED IN KIND (I.E. PAVERS) AND WILL BE REPLACED WITH ASPHALT OR CONCRETE. ALL EARTH OR GRAVEL DRIVES SHALL BE PAVED WITH ASPHALT TO THE RIGHT-OF-WAY LIMIT OR TIE-IN POINT. DRIVEWAYS SHALL BE PAVED AS FOLLOWS:

**ASPHALTIC DRIVES:** 

RESIDENTIAL -1-1/2" ASPH. CONC. 12.5 MM SUPERPAVE, 165 LB/SY

- 6" GRADED AGGREGATE BASE

COMMERCIAL -1-1/2" ASPH. CONC. 12.5 SUPERPAVE, 165 LB/SY

- 2" ASPH. CONC. 19MM SUPERPAVE, 220 LB/SY

- 6" GRADED AGGREGATE BASE

**CONCRETE DRIVES:** 

RESIDENTIAL - 4" CONCRETE DRIVEWAY PAVING

- 4" CRUSHER RUN, GAB, OR OTHER MATERIAL AS APPROVED BY ENGINEERING

COMMERCIAL - 6" CONCRETE DRIVEWAY PAVING

- 4" CRUSHER RUN, GAB, OR OTHER MATERIAL AS APPROVED BY ENGINEERING

<u>PROJECT GENERAL NOTES CONT'D:</u>

- 14. ALL CONCRETE SIDEWALKS AND WHEEL CHAIR RAMPS LOCATED IN THE RADIUS RETURN SHALL BE 8"
- 15. LUMP-SUM TRAFFIC CONTROL: THE PRICE BID FOR LUMP-SUM TRAFFIC CONTROL SHALL INCLUDE THE COST OF STAGED CONSTRUCTION, MAINTENANCE OF TRAFFIC (INCLUDING AGGREGATE SURFACE COURSE) INSTALLATION AND REMOVAL OF ALL TEMPORARY SIGNAGE, INTERIM PAVEMENT MARKINGS, BARRICADES, AND OTHER INTERIM TRAFFIC CONTROL DEVICES NECESSARY FOR THE CONSTRUCTION AND MAINTENANCE OF THE PROJECT. DEVICES UTILIZED ON THE PROJECT SHALL BE IN COMPLIANCE WITH THE MANUAL ON UNIFORM TRAFFIC CONTROL DEVICES (MUTCD), CURRENT EDITION AND SECTION 150. ALL DEVICES, SIGNS, POSTS, BARRICADES. ETC SHALL BE FROM THE GDOT QUALIFIED PRODUCTS LIST (QPL). ALL DEVICES SHALL BE CRASHWORTHY UNDER AASHTO AND NCHRP 350 REQUIREMENTS. THE ENGINEER MAY DIRECT THAT ADDITIONAL DEVICES AND MARKINGS BE ADDED TO THE TRAFFIC CONTROL PLAN. THE COST OF NOMINAL ITEMS ADDED BY THE ENGINEER SHALL BE INCLUDED IN LUMP-SUM TRAFFIC CONTROL EXCEPT FOR THE ADDITION OF A CHANGEABLE MESSAGE SIGN(S). THE CONTRACT UNIT PRICE WILL BE PAID FOR A CHANGEABLE MESSAGE SIGN(S) OR A UNIT PRICE WILL BE DETERMINED WHEN A CHANGEABLE MESSAGE SIGN(S) IS NOT INCLUDED IN THE CONTRACT.
- 16. DETOURS IN THE PLANS: SUGGESTED DETOURS SHOWN IN THE PLANS ARE FOR INFORMATION ONLY. CONTRACTOR SHALL SUBMIT ON SITE AND OFF SITE DETOURS, AS PER SPECIAL PROVISION 150 TRAFFIC CONTROL, FOR REVIEW AND APPROVAL. THE COST OF MAINTENANCE, GRADING, TEMPORARY DRAINAGE, TEMPORARY SIGNAGE, TEMPORARY MARKINGS AND TEMPORARY DEVICES SHALL BE INCLUDED IN LUMP-SUM TRAFFIC CONTROL. THE COST OF STONE BASE (GAB) AND THE PLACEMENT OF THE TYPICAL PAVEMENT SECTION, TEMPORARY BARRIERS, ATTENUATORS, TEMPORARY GUARDRAIL, AND ANCHORS, IF NEEEDED, WILL BE PAID AT CONTRACT UNIT PRICES. IF NO PAY ITEM IS SET UP FOR THE AFOREMENTIONED ITEMS FOR DETOURS THEN, IF REQUIRED, WILL BE INCLUDED IN LUMP SUM TRAFFIC CONTROL, AND IT WILL NOT BE MEASURED SEPARATELY FOR PAYMENT. ANY UNIT PRICES SET UP WILL INCLUDE INSTALLATION AND REMOVAL PERMANENT DEVICES, TO BE INCORPORATED INTO THE FINAL WORK, MAY BE USED FOR INTERIM/TEMPORARY DUTIES PROVIDED THE PERMANENT DEVICES ARE NOT DAMAGED DURING THE INTERIM USAGE. THE COST FOR 6. REPLACEMENT OF DAMAGED COMPONENTS SHALL BE AT THE CONTRACTOR'S EXPENSE.
- 17. DETOURS NOT SHOWN IN THE PLANS (DETOURS PROPOSED BY THE CONTRACTOR): THE COST TO INSTALL, MAINTAIN AND REMOVE ANY DETOUR SHALL BE INCLUDED IN THE PRICE BID FOR LUMP-SUM TRAFFIC CONTROL. THE COST OF GRADING, PAVEMENT, SIGNING, MARKINGS, TEMPORARY DEVICES, TEMPORARY CONCRETE BARRIERS, ATTENUATORS, TEMPORARY GUARDRAIL AND ANCHORS, ETC SHALL BE INCLUDED IN THE PRICE BID FOR LUMP-SUM TRAFFIC CONTROL. DETOURS NOT SHOWN IN THE PLANS WILL NOT BE ELIGIBLE TO BE PAID AT CONTRACT UNIT PRICES.
- 18. ALL CUT AND FILL SLOPES SHALL BE STABILIZED TO COMPLY WITH SECTION 161.3.05.B OF THE SPECIFICATIONS IN ORDER TO REDUCE THE POTENTIAL FOR EROSION. IF THE SEASON DOES NOT PERMIT PERMANENT GRASSING, TEMPORARY STRAW MULCH AND/OR TEMPORARY VEGETATION SHALL BE USED AS PER THE EROSION AND SEDIMENTATION POLLUTION CONTROL PLAN (ESPCP) OR AS DIRECTED BY THE ENGINEER.
- 19. EROSION CONTROL MEASURES SHALL BE INSTALLED TO BE IN COMPLIANCE WITH THE APPROVED EROSION AND SEDIMENTATION POLLUTION CONTROL PLAN (ESPCP). EROSION CONTROL MEASURES SHALL BE INSTALLED PRIOR TO ANY LAND DISTURBING ACTIVITIES THAT INVOLVE ENVIRONMENTAL SENSITIVE AREAS (ESA'S) AS DEFINED UNDER SECTION 107.23.F OF THE SPECIFICATIONS AND THE ESPCP. IN GENERAL EROSION CONTROL ITEMS SHOULD BE INSTALLED PRIOR TO THE START OF ANY LAND DISTURBING ACTIVITIES. THE INSTALLATION OF THE EROSION CONTROL ITEMS MAY BE INSTALLED CONCURRENT WITH THE START OF THE LAND DISTURBING ACTIVITIES. IF ALLOWED BY THE ESPCP.
- 20. SPRINKLER SYSTEMS TO BE HANDLED AS FOLLOWS:

CASE 1 - SYSTEMS WITHIN THE CONSTRUCTION LIMITS OWNED BY INDIVIDUALS OR PRIVATE COMPANIES ARE TO BE REMOVED TO THE BACK OF THE CONSTRUCTION LIMITS AND PLUGGED.

CASE 2 - SYSTEMS SHOWN BY THE PLANS TO BE REMOVED AND RELOCATED SHALL BE RELOCATED TO THE BACK OF THE SIDEWALK. COST SHALL BE INCLUDED IN PRICE BID FOR "GRADING COMPLETE"

- 21. THE CONTRACTOR SHALL BE RESPONSIBLE FOR REMOVING, RELOCATING, AND MAINTAINING THE PROPERTY OWNER'S MAILBOX TO AN AREA OUTSIDE CONSTRUCTION LIMITS DURING THE LIFE OF THE CONTRACT. THE LOCATION OF THE BOX SHOULD BE CONVENIENT TO BOTH THE MAIL CARRIER AND THE PATRON. YET NOT INTERFERE WITH PROPOSED WORK. IT MAY BE NECESSARY FOR THE CONTRACTOR TO CONFER WITH THE POST OFFICE SERVING THE AREA. ALL COSTS INCURRED FOR COMPLIANCE WITH THESE REQUIREMENTS SHALL BE INCLUDED IN THE PRICE BID FOR OTHER ITEMS.
- 22. AN N.O.I. (NOTICE OF INTENT) IS NOT REQUIRED FOR THIS PROJECT. THE DISTURBED AREA IS 0.95 ACRES.
- 23. ATTENTION IS CALLED TO SECTION 149.3, CONSTRUCTION REQUIREMENTS, CONTRACTOR IS REQUIRED TO TAKE THREE-POINT LEVELS ON WIDENING AND RECONSTRUCTION PROJECTS AND OBTAIN THE ENGINEER'S APPROVAL OF THE "BEST FIT" PROFILE AND CROSS SLOPE, TO MINIMIZE LEVELING REQUIREMENTS OF THE EXISTING ROADWAY. THE CONTRACTOR MUST GET THE ENGINEER'S APPROVAL OF THE PROPOSED BEST FIT BEFORE BEGINNING WIDENING AND RECONSTRUCTION. COST FOR SURVEY WORK TO BE INCLUDED IN GRADING COMPLETE OR OTHER ITEMS, NO SEPARATE PAYMENT SHALL BE MADE.
- 24. ALL ROADWAY DRAINAGE PIPES SHALL BE REINFORCED CONCRETE. THE GDOT PIPE SELECTION CHART MAY ONLY BE USED FOR DRIVEWAY PIPES.
- 25. CONTRACTOR TO PROVIDE PRE-CONSTRUCTION PHOTOS OF ALL DRIVEWAYS TO PROJECT ENGINEER PRIOR TO CONSTRUCTION. PHOTOS MAY BE DIGITAL.
- 26. ALL EXISTING STORM DRAIN PIPES INCLUDING BOX CULVERTS WITHIN THE CONSTRUCTION LIMITS SHALL BE CLEANED PRIOR TO COMPLETION OF PROJECT. COST TO BE INCLUDED IN GRADING COMPLETE

PROJECT GENERAL NOTES CONT'D:

CROY REFERENCE NUMBER

27. ALL EXISTING PEDESTRIAN FACILITIES, INCLUDING ACCESS TO TRANSIT STOPS, SHALL BE MAINTAINED. WHERE PEDESTRIAN ROUTES ARE CLOSED, ALTERNATE ROUTES SHALL BE PROVIDED. WHEN EXISTING PEDESTRIAN FACILITIES ARE DISRUPTED, CLOSED, OR RELOCATED WITHIN THE LIMITS OF THE PROJECT, THE TEMPORARY PEDESTRIAN FACILITIES SHALL BE DETECTABLE AND SHALL INCLUDE ACCESSIBILITY FEATURES CONSISTENT WITH THE FEATURES PRESENT IN THE EXISTING PEDESTRIAN FACILITIES (PER LATEST MUTCD). COST FOR CONSTRUCTING AND MAINTAINING TEMPORARY PEDESTRIAN FACILITIES SHALL BE INCLUDED IN THE PRICE BID FOR GRADING COMPLETE.

PROJECT NUMBER

SHEET NO.

TOTAL SHEETS ###

28. THE ROADWAY FINAL SURFACE COURSE JOINTS MUST MATCH THE PROPOSED LANE EDGES AS SHOWN IN THE PAVEMENT MARKING PLANS.

MAINTENANCE OF TRAFFIC GENERAL NOTES:

COUNTY

- 1. ALL ITEMS NECESSARY FOR COMPLIANCE WITH THESE REQUIREMENTS SHALL BE INCLUDED IN THE PRICE BID FOR "TRAFFIC CONTROL".
- 2. ALL SIGNS AND PAVEMENT MARKINGS SHALL CONFORM TO THE MANUAL ON UNIFORM TRAFFIC CONTROL DEVICES (MUTCD), LATEST EDITION, AND ANY APPLICABLE FAYETTE COUNTY STANDARDS.
- ALL SIGNS SHALL HAVE TYPE III RETROREFLECTIVE SHEETING UNLESS OTHERWISE NOTED.
- IN RESIDENTIAL AREAS, TEMPORARY AND PERMANENT SIGNS SHALL BE LOCATED ON OR AS CLOSE AS POSSIBLE TO PROPERTY LINES.
- EXISTING TRAFFIC SIGNS SHALL BE MAINTAINED BY THE CONTRACTOR THROUGHOUT CONSTRUCTION. MAINTENANCE INCLUDES REPLACING DAMAGED AND STOLEN SIGNS, AND PERIODIC CLEANING OF EXISTING SIGNS AND CONSTRUCTION RELATED TRAFFIC CONTROL DEVICES.
- THE WORKSITE TRAFFIC CONTROL SUPERVISOR (WTCS) SHALL BE RESPONSIBLE FOR THE ELIMINATION OF ANY CONFLICTING PAVEMENT MARKINGS. THE WTCS SHALL NOT USE "BLACK OUT PAINT" TO ERADICATE CONFLICTING MARKINGS. THE ENGINEER SHALL MAKE THE FINAL DETERMINATION WHETHER THE CONFLICTING MARKINGS HAVE BEEN ADEQUATELY ELIMINATED.
- TEMPORARY TRAFFIC BARRIERS SHALL HAVE A TWO (2') FEET MINIMUM OFFSET FROM THE EDGE OF ANY TRAVEL LANE. ONLY TRAFFIC DRUMS, MEETING THE MINIMUM REQUIREMENTS OF THE MUTCD AND SECTION 150, AND TEMPORARY BARRIERS THAT ARE CRASHWORTHY SHALL BE USED ADJACENT TO TRAVEL LANES, UNLESS PRIOR APPROVAL IS GRANTED BY FAYETTE COUNTY PUBLIC WORKS DEPARTMENT. THE TEMPORARY BARRIERS CANNOT BE PLACED LESS THAN TWO (2') FEET FROM THE EDGE OF THE TRAVEL LANE. THE USE OF TYPE I AND II BARRICADES AND TRAFFIC CONES IS PROHIBITED.
- TRAFFIC DRUMS MEETING THE MINIMUM REQUIREMENTS OF THE MUTCD AND SECTION 150 SHALL BE USED FOR CHANNELIZATION OF TRAFFIC IN ALL TRAFFIC SHIFTS. FOR ANY WORK ZONE, THE MAXIMUM DRUM SPACING, IN FEET, SHALL BE THE DESIGN OR POSTED SPEED LIMIT, WHICHEVER IS LESS. BASED ON FIELD CONDITIONS, THE MAXIMUM SPACING OF THE TRAFFIC DRUMS MAY NEED TO BE FURTHER REDUCED.
- 9. ALL TRAFFIC CONTROL DEVICES SHALL BE MAINTAINED BY THE CONTRACTOR SO AS NOT TO INTERFERE WITH SIGHT DISTANCES ALONG ANY ADJACENT SIDE ROAD OR DRIVEWAY.
- 10. FAYETTE COUNTY PUBLIC WORKS DEPARTMENT RESERVES THE RIGHT TO MODIFY THIS MAINTENANCE OF TRAFFIC PLAN AS FIELD CONDITIONS WARRANT. IF ADDITIONAL TRAFFIC CONTROL DEVICES ARE REQUIRED. THESE SHALL BE PROVIDED BY THE CONTRACTOR AT NO ADDITIONAL EXPENSE TO THE COUNTY OR GDOT.
- 11. THE CONTRACTOR MUST OBTAIN A ROAD CLOSURE PERMIT FROM FAYETTE COUNTY PUBLIC WORKS DEPARTMENT A MINIMUM OF 3 WEEKS PRIOR TO ROAD CLOSURE. FOR INFORMATION CALL (770-320-6010).
- 12. REFLECTORIZED TYPE 3 BARRICADES SHALL BE USED AT THE ACTUAL LOCATION OF TOTAL STREET CLOSURE. EACH BARRICADE SHALL HAVE TWO TYPE 'A' LIGHTS AND ONE R11-2 (ROAD CLOSED) SIGN ATTACHED.
- 13. ALL M4-9 SIGNS SHALL HAVE ADVISORY BLADES (INSTALLED ABOVE THE "DETOUR" SIGN) IDENTIFYING THE CLOSED STREET THAT THE DETOUR ROUTE SERVES.
- 14. INFORMATION SIGNS, INFORMING MOTORISTS OF THE ROAD CLOSURE SHALL BE INSTALLED A MINIMUM OF 2 WEEKS PRIOR TO THE ROAD CLOSURE. THESE SIGNS SHALL BE INSTALLED AT OR AS NEAR AS POSSIBLE TO THE ROAD CLOSURE (SEE SPECIFICATIONS BELOW):

(ROAD NAME) WILL BE CLOSED TO THRU TRAFFIC FROM (SIDE ROAD) TO (SIDE ROAD)

(DATE) THRU (DATE)

(REASON FOR CLOSURE) FOR INFO CALL (770-320-6010)


THESE SIGNS SHALL BE RETROREFLECTIVE SHEETING ON METAL. 4 INCH BLACK UPPER AND LOWER CASE LETTERING (SERIES 'B' OR WIDER) ON WHITE BACKGROUND.

- 15. IT SHALL BE THE CONTRACTORS RESPONSIBILITY TO PREPARE A MAINTENANCE OF TRAFFIC PLAN FOR APPROVAL BY FAYETTE COUNTY PUBLIC WORKS DEPARTMENT BEFORE STARTING CONSTRUCTION. PAYMENT SHALL BE INCLUDED IN THE PRICE FOR "TRAFFIC CONTROL". THE CONTRACTOR WILL NOT BE ALLOWED TO CLOSE THE ROAD DURING THE CONSTRUCTION OF THE PROJECT WITHOUT APPROVAL BY THE ENGINEER.
- 16. NO LANE CLOSURES ARE ALLOWED BETWEEN 6-9AM AND 4-7PM WITHOUT PRIOR APPROVAL BY THE ENGINEER.
- 17. THE CONTRACTOR SHALL MAINTAIN INGRESS AND EGRESS TO ALL DRIVEWAYS AT ALL TIMES.

200 NORTH COBB PARKWAY, BLDG. 400, SUITE 413 MARIETTA, GA 30062 PHONE: (770) 971-5407 FAX: (770) 971-0620

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REVISION DATES FAYETTE COUNTY VETERANS PARKWAY AT SR 92 DRAWING NO. GENERAL NOTES 04 - 01

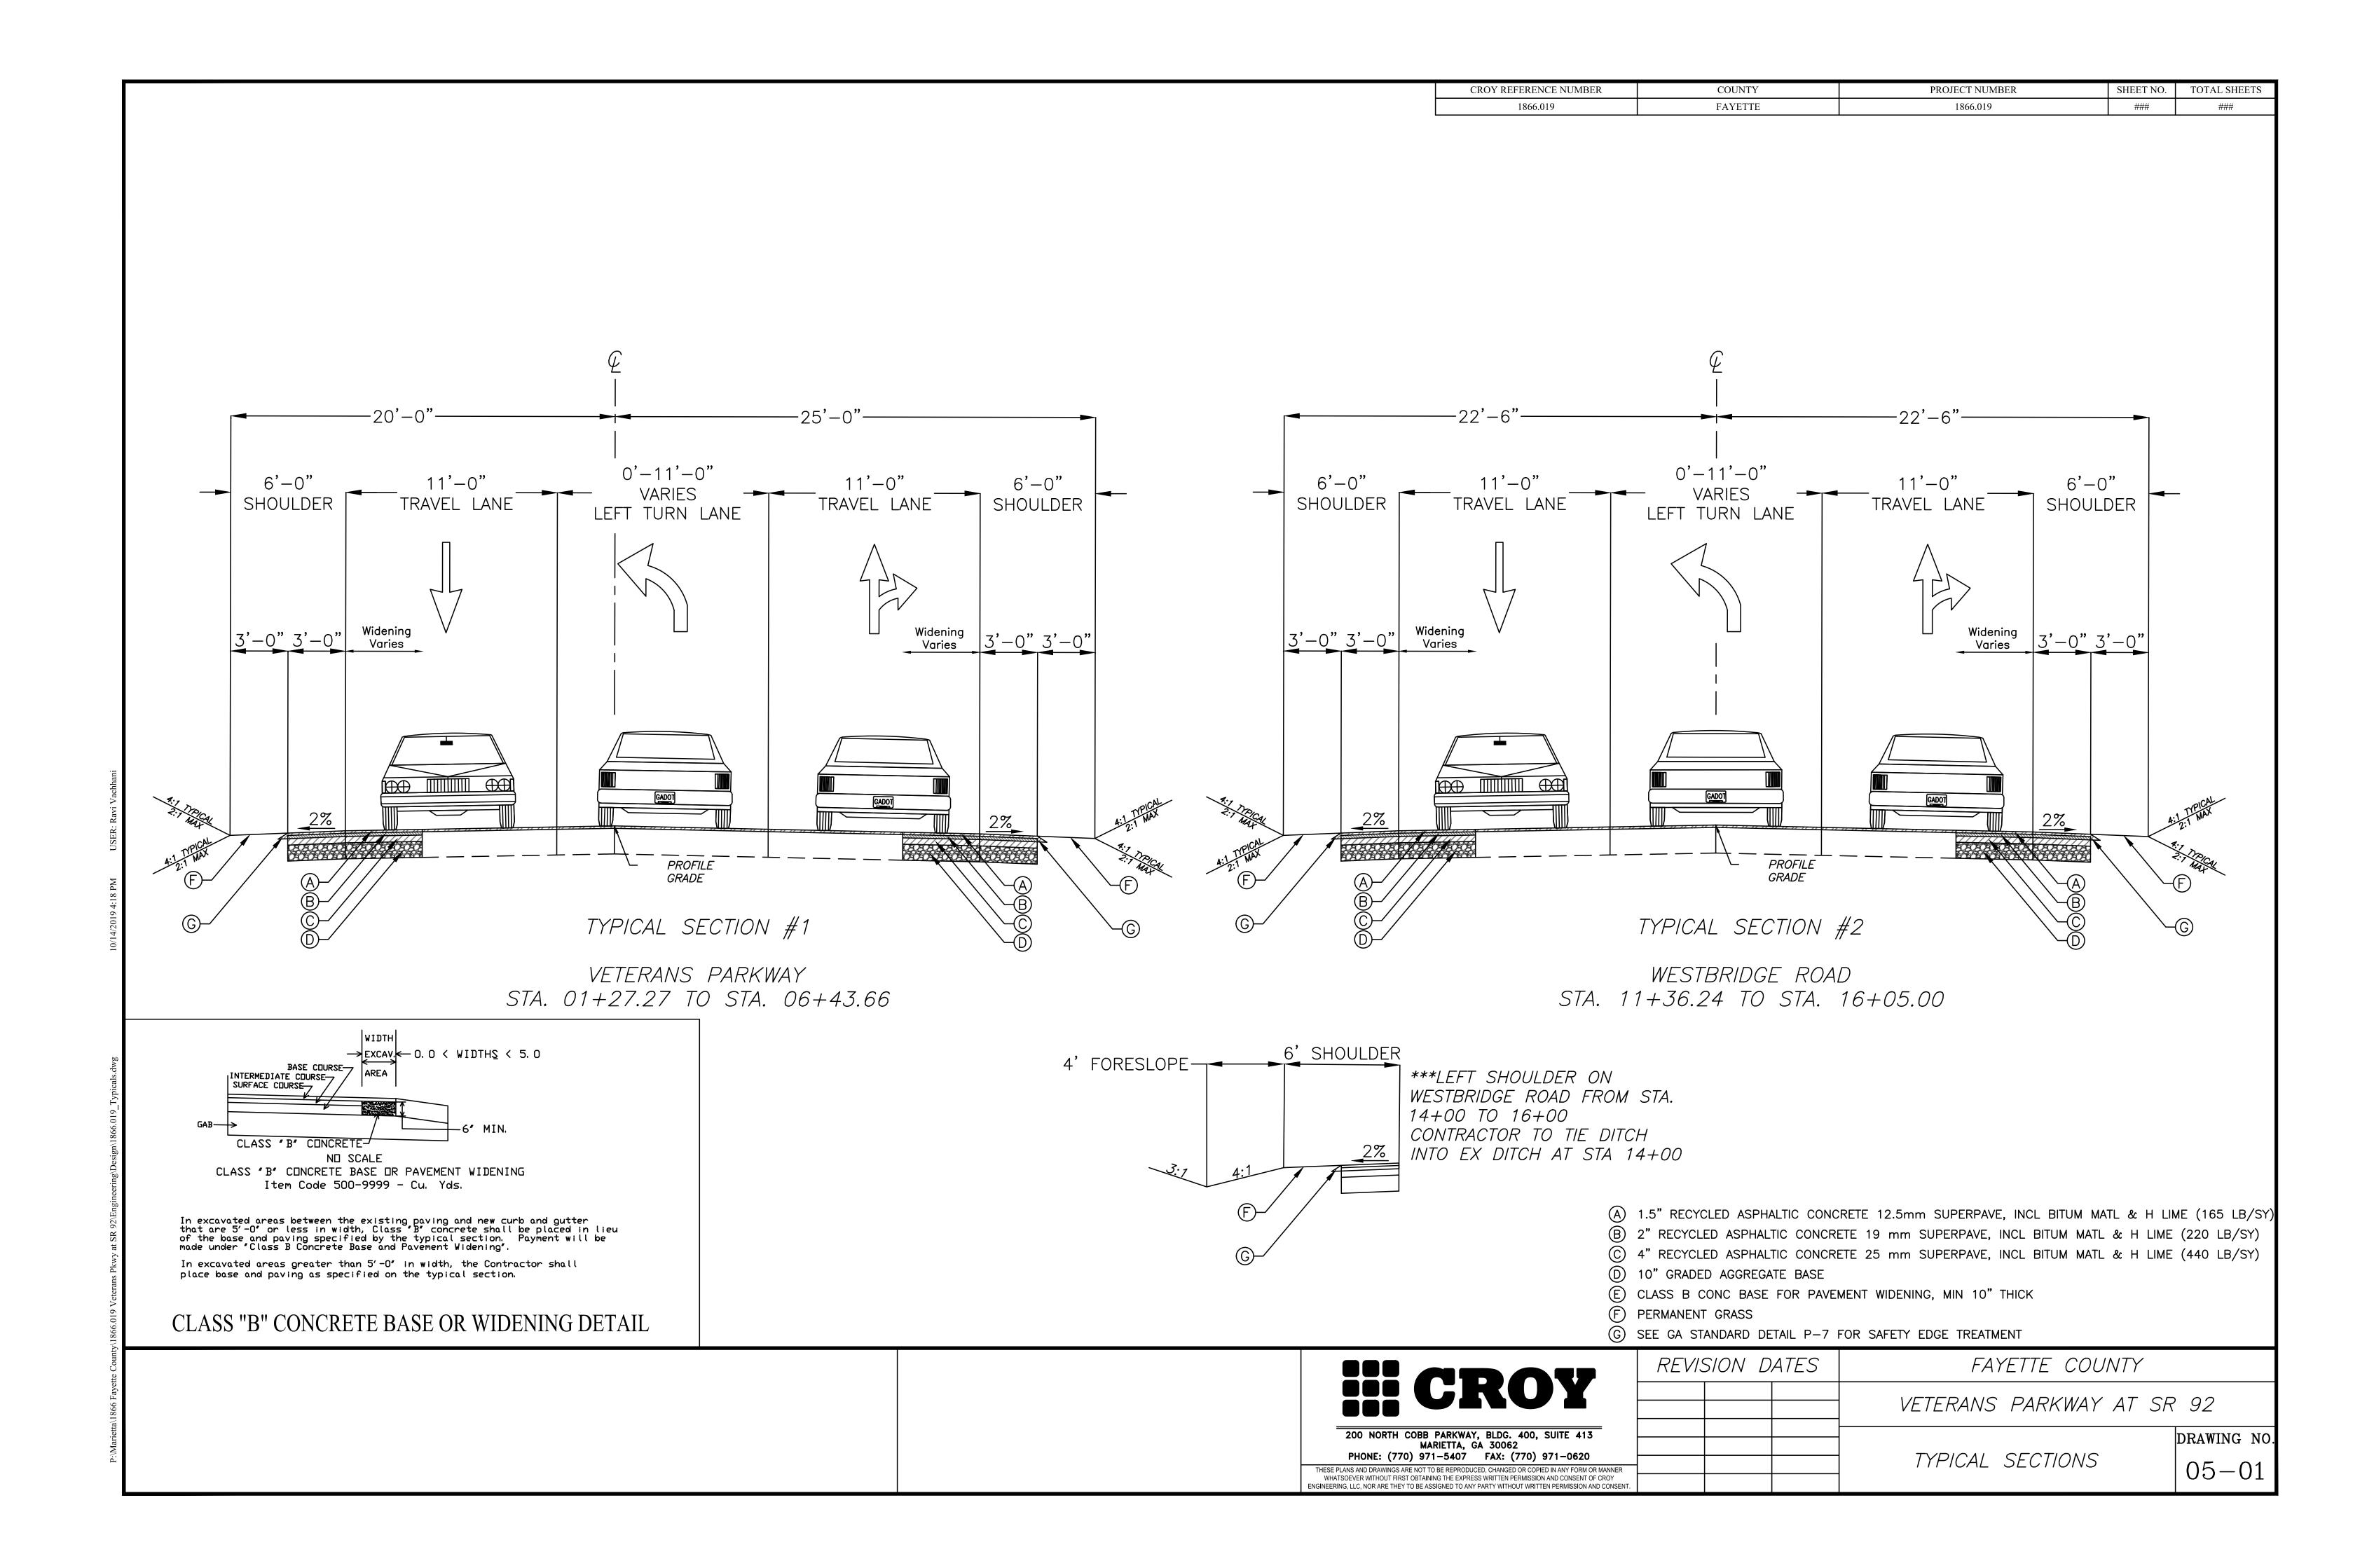

CROY REFERENCE NUMBER	COUNTY	PROJECT NUMBER	SHEET NO.	TOTAL SHEETS
1866.019	FAYETTE	1866.019	###	###

ROADWAY ITEMS														
LOCATION	GR AGGR BASE CRS, 6 INCH, INCL	GR AGGR BASE CRS, 10 INCH, INCL MATL	AGGR SURFACE CRS*	RECYCLED ASPH S CONC PATCHING	RECYCLED ASPH CONC 25 MM SUPERPAVE, GP 1 OR 2, INCL BITUM	RECYCLED ASPH CONC 19 MM SUPERPAVE, GP 1 OR 2, INCL BITUM	RECYCLED ASPH CONC 12.5 MM SUPERPAVE, GP 2 ONLY, INCL BITUM	S TACK COAT	MILL ASPHALT  CONC. PVMT,  VARIABLE DEPTH	S CONCRETE MEDIAN, 7.5 IN.	CURB CUT WHEELCHAIR RAMP, TP A	CURB CUT WHEELCHAIR RAMP, TP B	PVMT REINF 디 FABRIC STRIPS, TP 2, 18 IN WIDE	CLASS B CONC, RASE OR PVMT WIDENING
VETERANS PKWY	22	1180	10	10	201	100	274		2121	31	1	1	1473	45
WESTBRIDGE RD	24	1345			276	139	278		1867	67		2	1357	16
TOTAL	46	2525	10	10	477	239	552		3988	98	1	3	2830	61

TEMPORARY EROSION CONTROL									
LOCATION	MULCH— DISTURBED AREA	TEMPORARY SILT FENCE TP S	MAINTENANCE OF TEMPORARY SILT FENCE TP S	CONSTRUCT & REMOVE INLET SEDIMENT TRAP	MAINTENANCE OF INLET SEDIMENT TRAP	STONE CHECK DAMS	MAINTENANCE OF STONE CHECK DAMS		
	TON	LIN. FT.	LIN. FT.	EACH	EACH	EACH	EACH		
SUB-TOTAL	2	1839	1839	1	1	5	5		
TOTAL	2	1839	1839	1	1	5	5		

PERMANENT EROSION CONTROL								
LOCATION	STD DUMPED RIP RAP TP 3, 18 IN.	PERMANENT GRASSING	TEMPORARY GRASSING	AGRICULTURAL LIME	FERTILIZER MIXED GRADE			
	SY	ACRE	ACRE	TON	TON			
SUB-TOTAL	26	1	1	1	1			
TOTAL	26	1	1	1	1			

DRAINAGE ITEMS									
STRUCTURE NUMBER	LOCATION	18" STORM DRAIN PIPE, H 1-10	SAFETY END SECTION, 18 IN., STORM DRAIN, SLOPE 4:1	ADJUST MANHOLE TO GRADE	GDOT 9031U 18" PIPE COLLAR				
		LIN. FT.	EACH	EACH	EACH				
VETER	RANS PKWY			1					
WEST	BRIDGE RD			2					
EX A4.1	10+77.71 RT				1				
A4.2	10+83.20 RT	10	1						
	PROJECT TOTALS		1	3	1				

GRADING	COMPLETE
LUMI	SUM

TRAFFIC CONTROL

GUARDRAIL QUANTITIES								
LOCATION & SIDE	GUARDRAIL "W" BEAM	GUARDRAIL TERMINAL, TP 12A – 31", TANGENT, ENERGY –ABSORBING	GUARDRAIL ANCHORAGE TP 1					
	LF	EA	EA					
STA 12+55 - 15+17 RT	198	1	1					
TOTAL	198	1	1					

::: CROY	- 1
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MARIETTA, GA 30062 PHONE: (770) 971-5407 FAX: (770) 971-0620	
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REVISION DATES	FAYETTE COUNTY
	VETERANS PARKWAY AT SR 92
	SUMMARY OF QUANTITIES DRAWING NO 06-01

					STAND	ARD SIGNS	5							
	HIGHWAY SIGNS			HIGHWAY SIG	NS				PO	STS				
LOCATION	CION CODE	TP 1 MATL. REFL. SHEETING TP 3			TP 1 MATL. REFL. SHEETING TP 9		TYPE 7		,	TYPE 9				
	SIGN CODE	SIZE	QTY	SQ. FT	- SIGN CODE	SIZE	QTY	SQ. FT	LENGTH (FT)	QTY	TOTAL LENGTH	LENGTH (FT)	QTY	TOTAL LENGTH
VETERANS PKWY														
01+59 RT					W3-3	30" X 30"	1	6.25	14	1	14			
					W16-9P	24" X 12"	1	2.00						
05+89 LT	R2-1	24" X 30"	1	5.00					14	1	14			
07+27 RT	R560-5	24" X 30"	1	5.00					13	1	13			
07+32 LT					R1-2	36"X36"X36"	1	3.9	13	1	13			
07+52 RT					R1-2	36"X36"X36"	1	3.9	13	1	13			
07+55 RT	R2-1	24" X 30"	1	5.00					14	1	14			
07+58 LT	R560-5	24" X 30"	1	5.00					13	1	13			
WESTBRIDGE RD														
10+40 LT	R2-1	24" X 30"	1	5.00					14	1	14			
10+41 RT	R560-5	24" X 30"	1	5.00					13	1	13			
10+46 LT					R1-2	36"X36"X36"	1	3.9	13	1	13			
10+71 RT					R1-2	36"X36"X36"	1	3.9	13	1	13			
10+75 LT	R560-5	24" X 30"	1	5.00					13	1	13			
11+58 RT	R2-1	24" X 30"	1	5.00					14	1	14			
15+89 LT					W3-3	30" X 30"	1	6.25	14	1	14			
					W16-9P	24" X 12"	1	2.00						
TOTALS				40				32.1			272			45

***SEE	SHEET	27 - 02	FOR	SIGNAL	QUANTITIES

CROY REFERENCE NUMBER	COUNTY	PROJECT NUMBER	SHEET NO.	TOTAL SHEETS
1866.019	FAYETTE	1866.019	###	###

TRAFFIC STRIPE				
DESCRIPTION	UNIT	QUANTITY		
DESCRIPTION	ONLI	THERMOPLASTIC		
5" SOLID WHITE	LIN. FT.	2977		
5" SOLID YELLOW	LIN. FT.	1447		
24" SOLID WHITE	LIN. FT.	92		
8" SOLID WHITE	LIN. FT.	1239		
5" SKIP WHITE(2'SEG, 6"GAP)	GR. LIN. FT.	111		
HATCH WHITE	SQ. YD.	567		
HATCH YELLOW	SQ. YD.	374		

ARROWS (	(EACH)
DESCRIPTION	QUANTITY
DESCRIPTION	THERMOPLASTIC
TYPE 2	14
TYPE 3	6
REMOVE EXISTING	17


NOTE:
ALL ARROWS
SHALL BE
WHITE UNLESS
OTHERWISE
SPECIFIED. SEE
PLANS FOR
LOCATION.


RAISED PAVEMENT MARKERS (EACH)						
	RE	REFLECTIVE-RAISED				
DESCRIPTION	YELLOW	CLEAR	CLEAR/RED			
	TYPE 1	TYPE 2	TYPE 3			
VETERANS PKWY	12		14			
WESTBRIDGE RD	12		14			
SR 92	14		26			
TOTAL	38	0	54			


OVERHEAD SPAN WIRE SIGNS					
	HIGH	IWAY S	SIGNS		
SIGN CODE	TP 2 M/ SHEETI		OVERHEAD SIGN SHEET MATERIAL		
SIGN CODE	SIGN CODE SIZE			UNIT	QTY.
D3-1	18" X 42"	EA	2	SQ. FT.	10.5
D3-2	18" X 104"	EΑ	1	SQ. FT.	13
D3-3	18" X 100"	EA	1	SQ. FT.	12.5
D3-4	18" X 100"	EA	1	SQ. FT.	12.5
D3-5	18" X 104"	EA	1	SQ. FT.	13
TOTAL			6		61.5


iii CROY
200 NORTH COBB PARKWAY, BLDG. 400, SUITE 413  MARIETTA, GA 30062  PHONE: (770) 971-5407 FAX: (770) 971-0620
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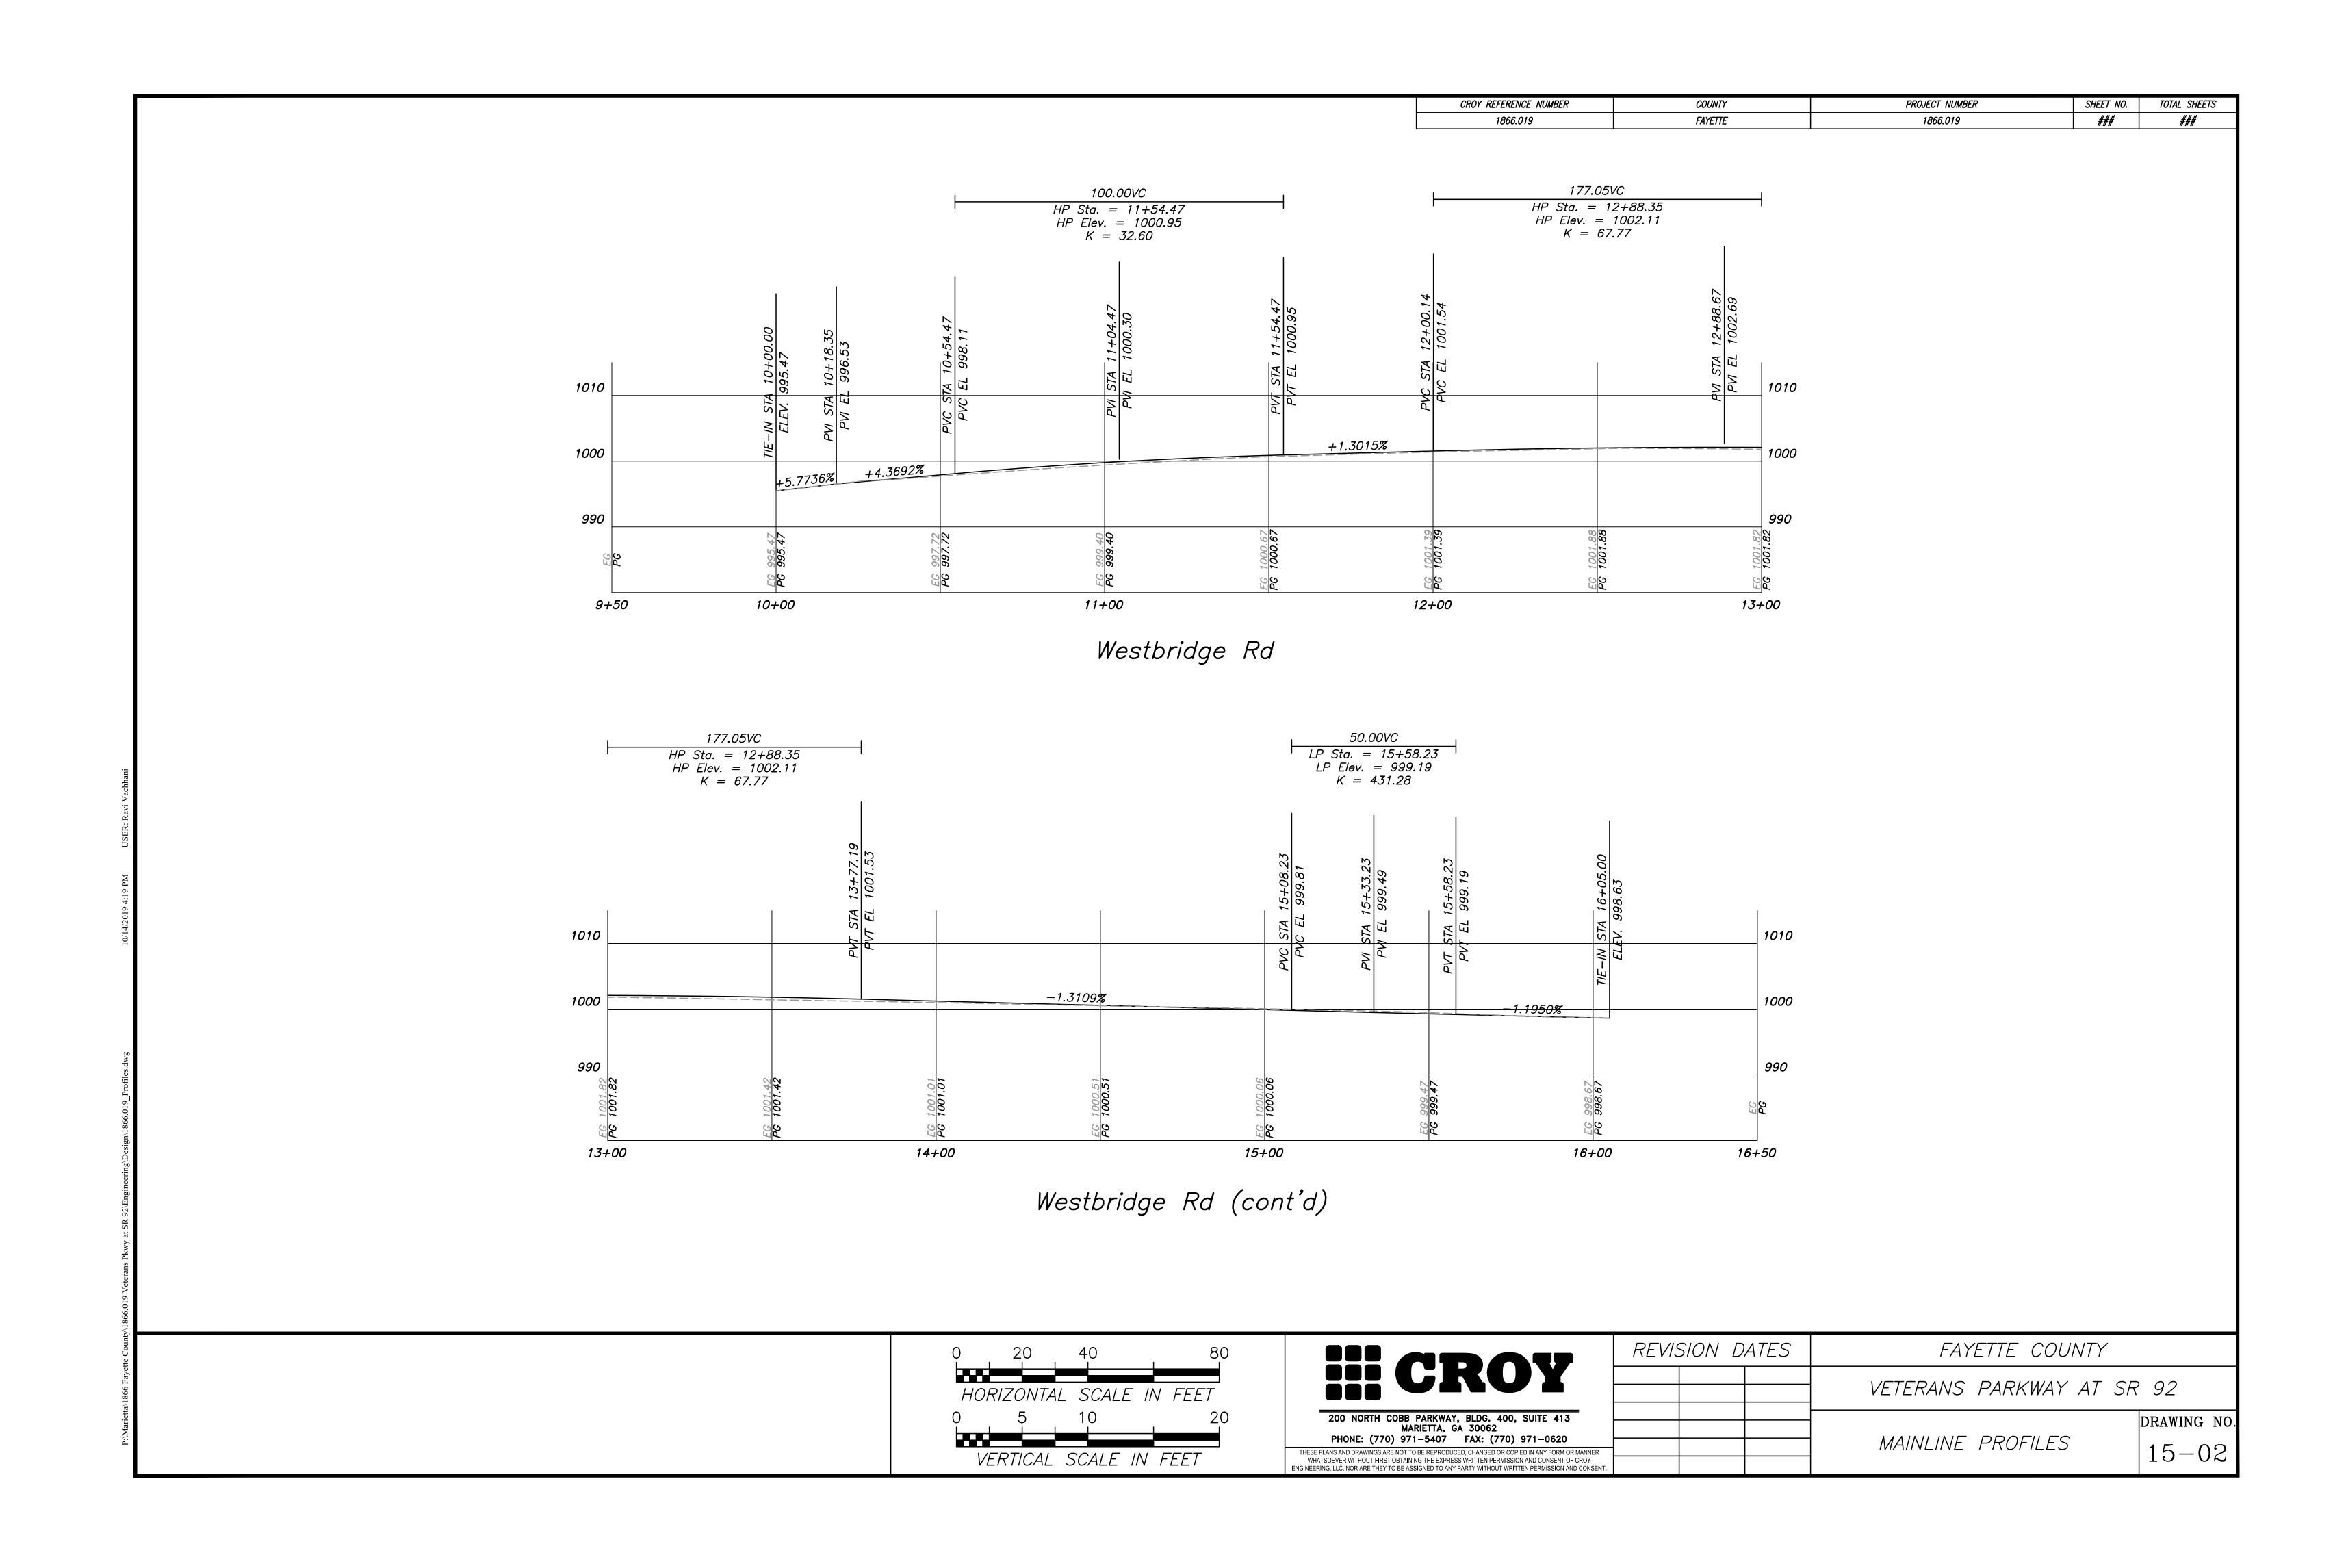
	REVISION DATES	FAYETTE COUNTY	
		VETERANS PARKWAY AT SR 92	
		DRAWING	G NO
IER ,		SUMMARY OF QUANTITIES 06-	02




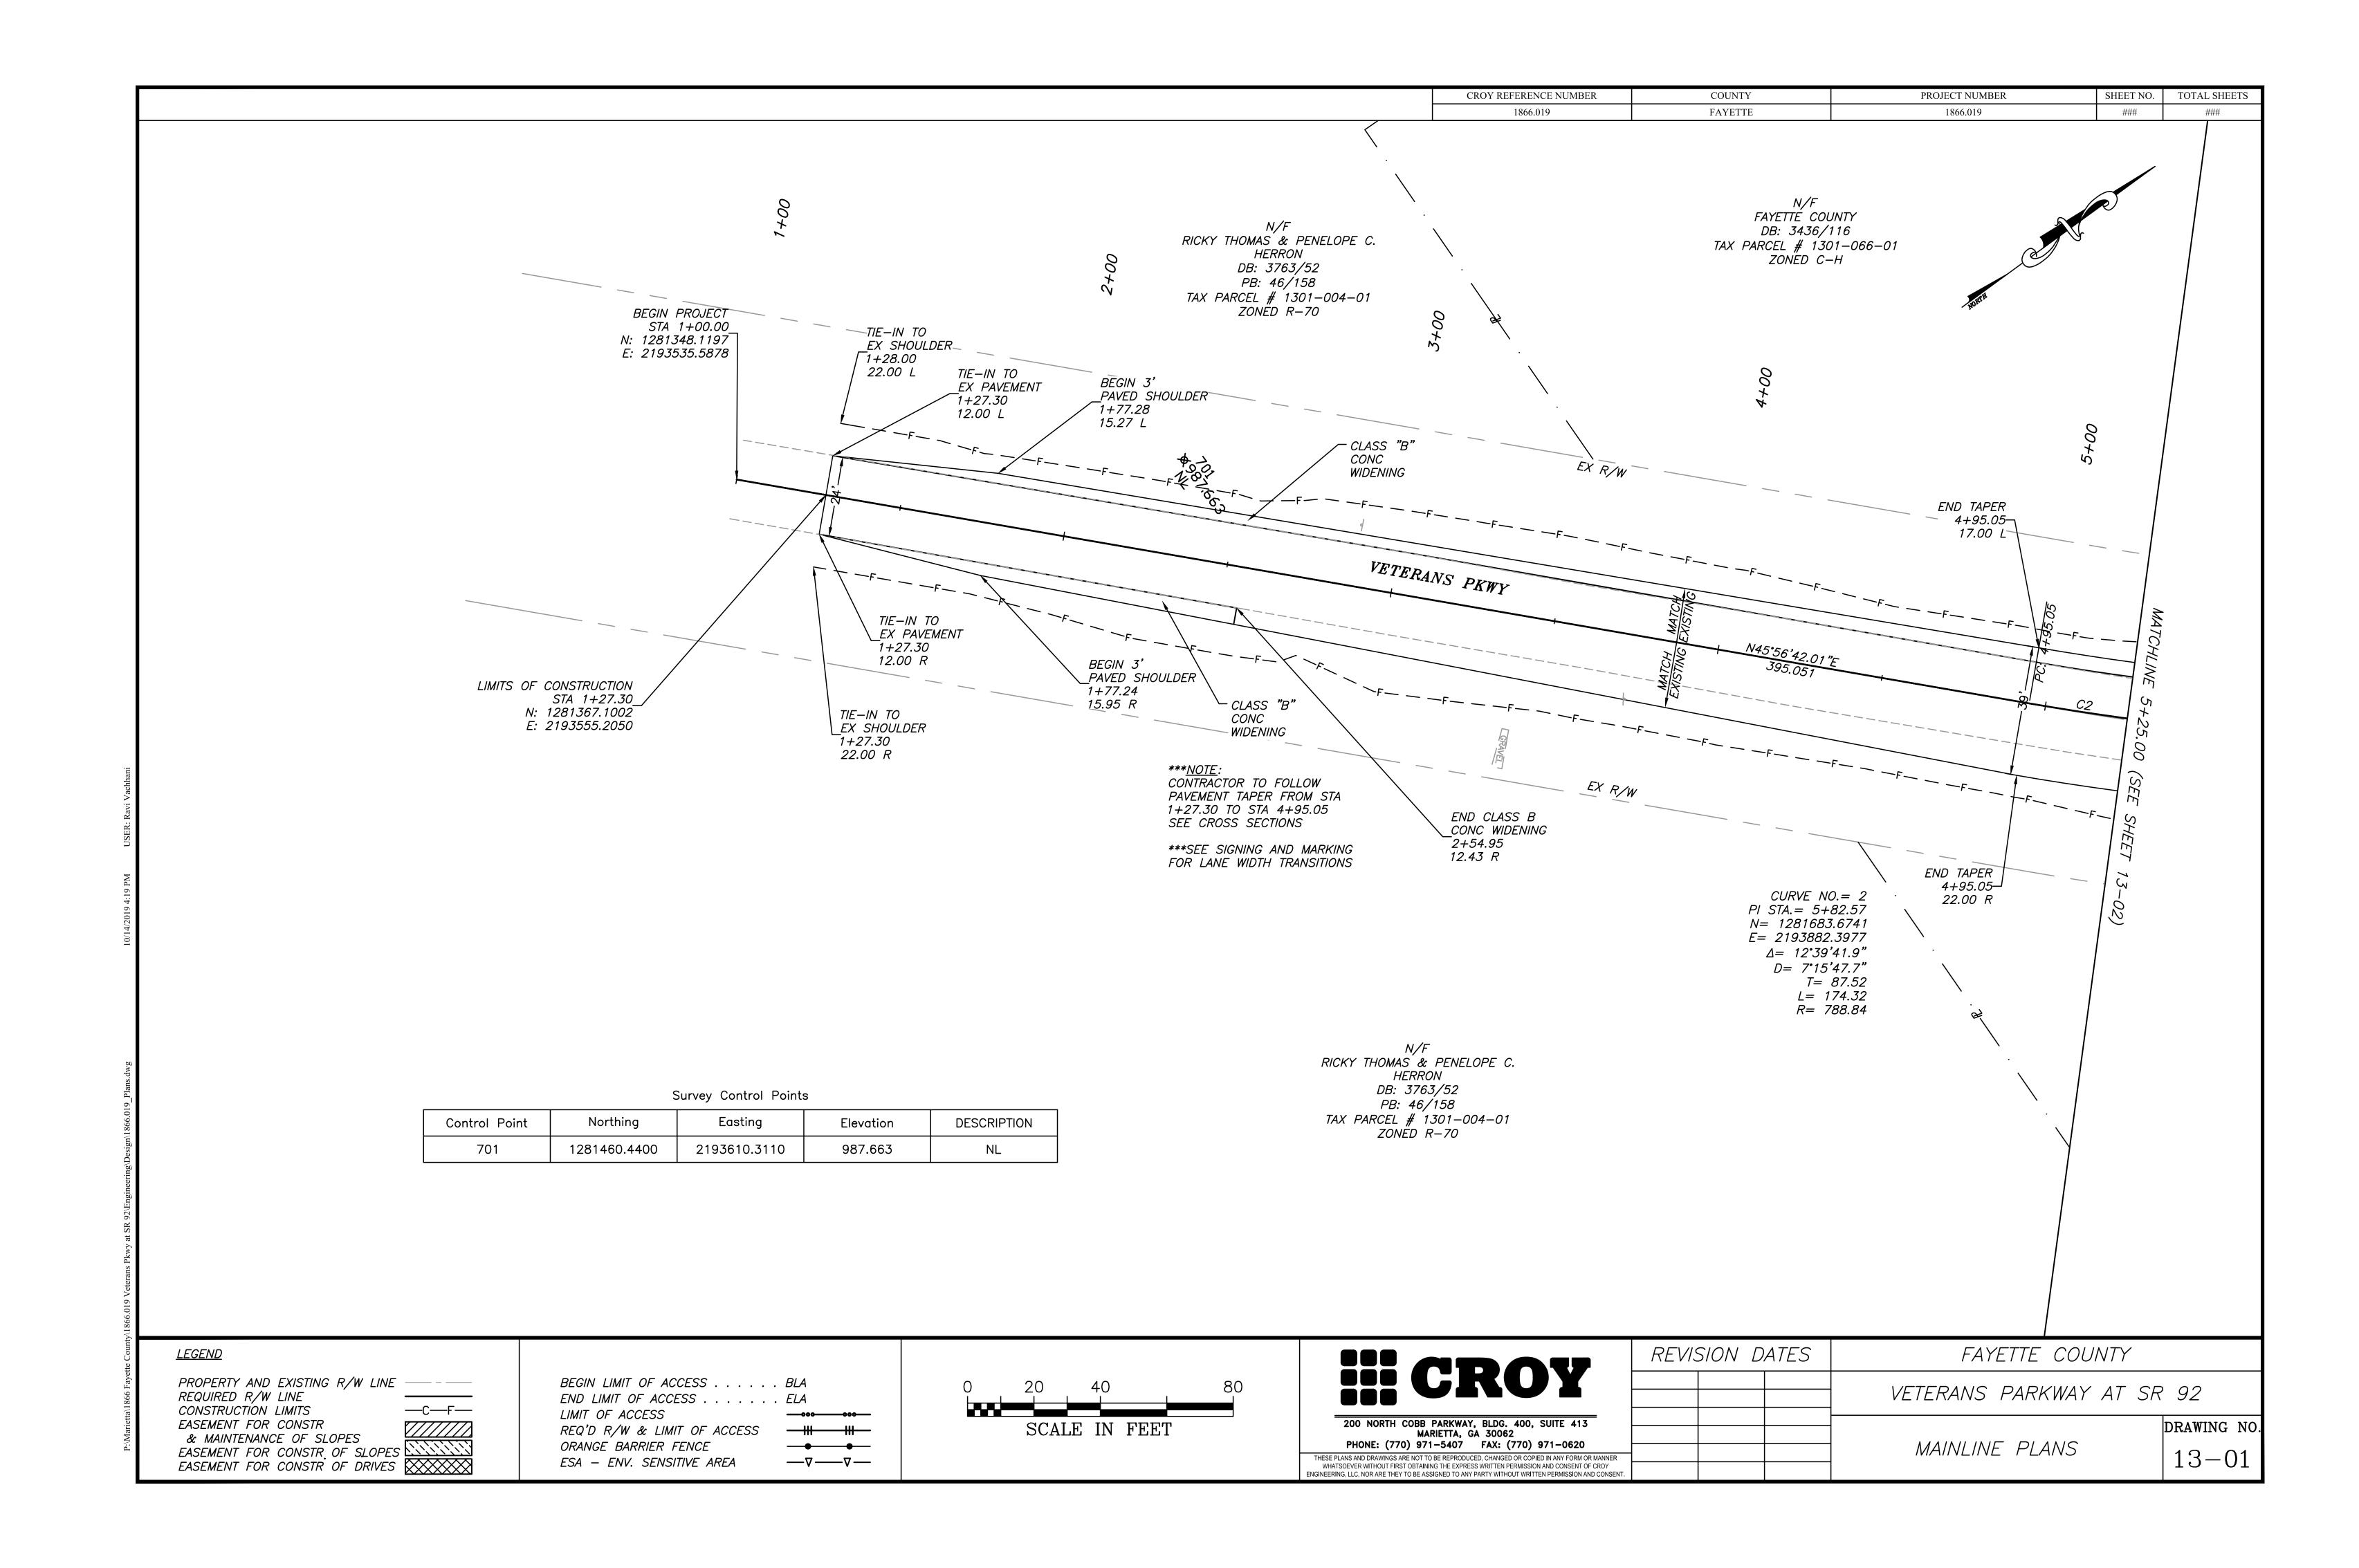


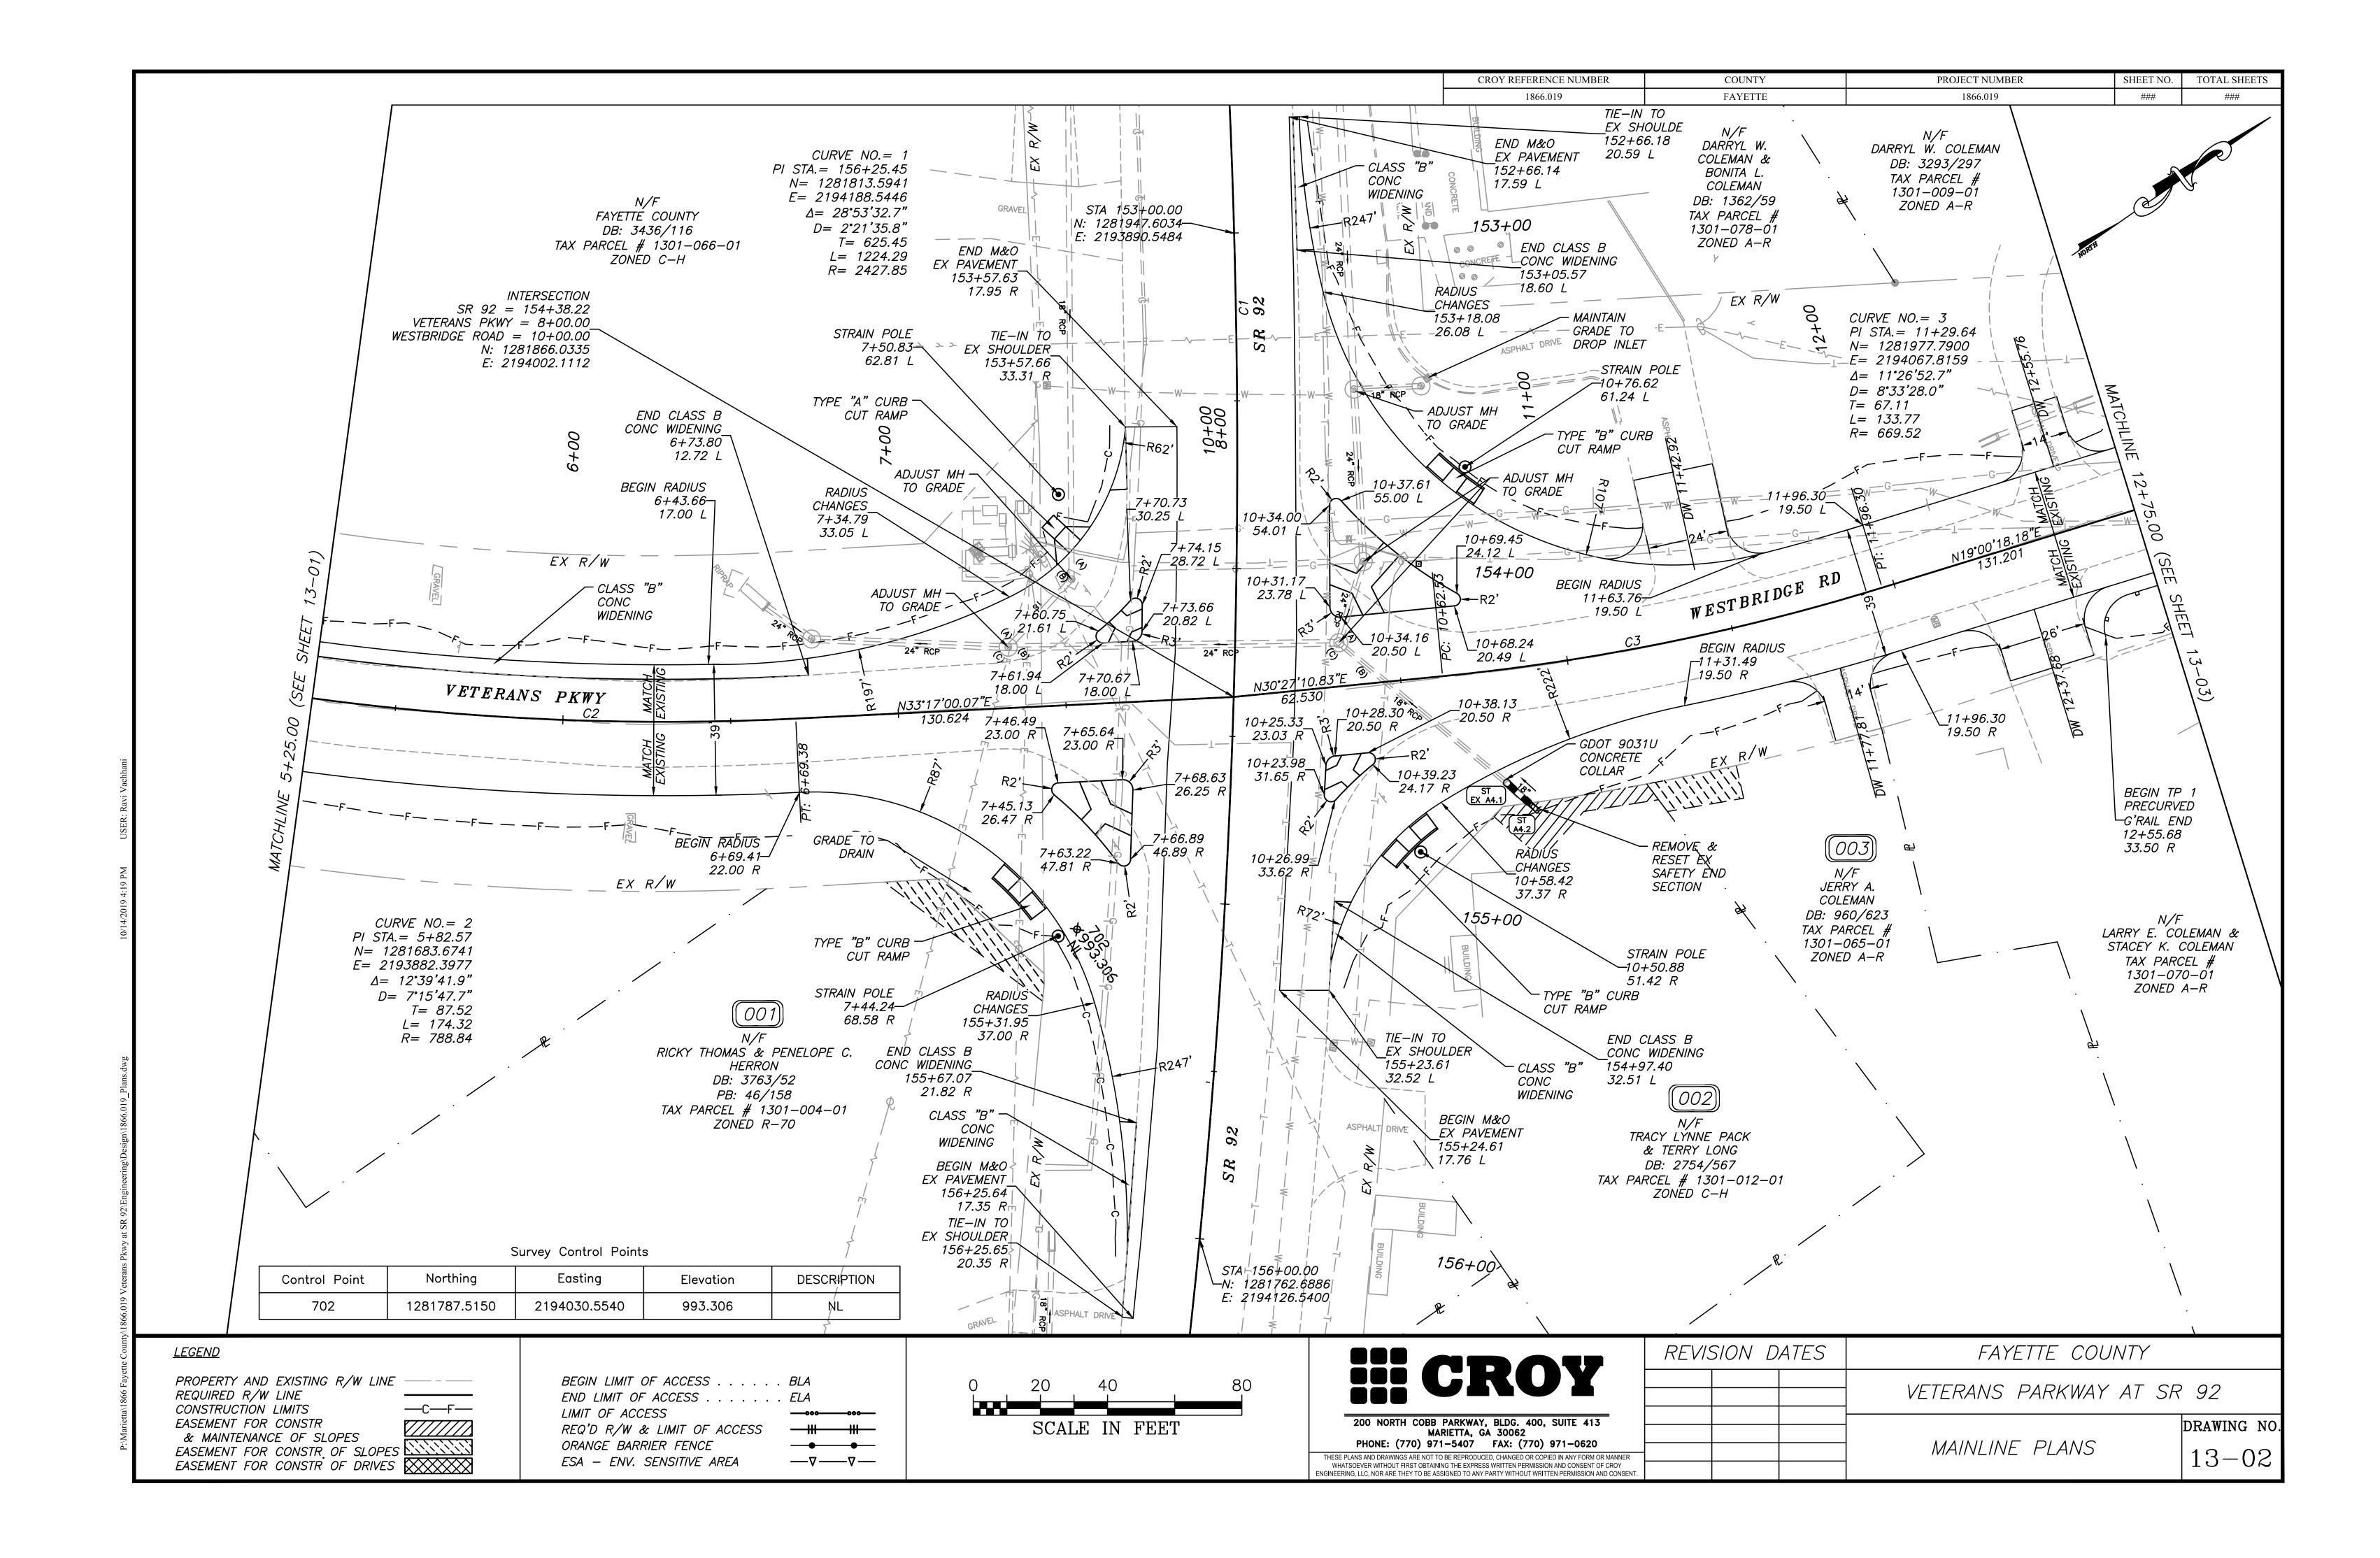


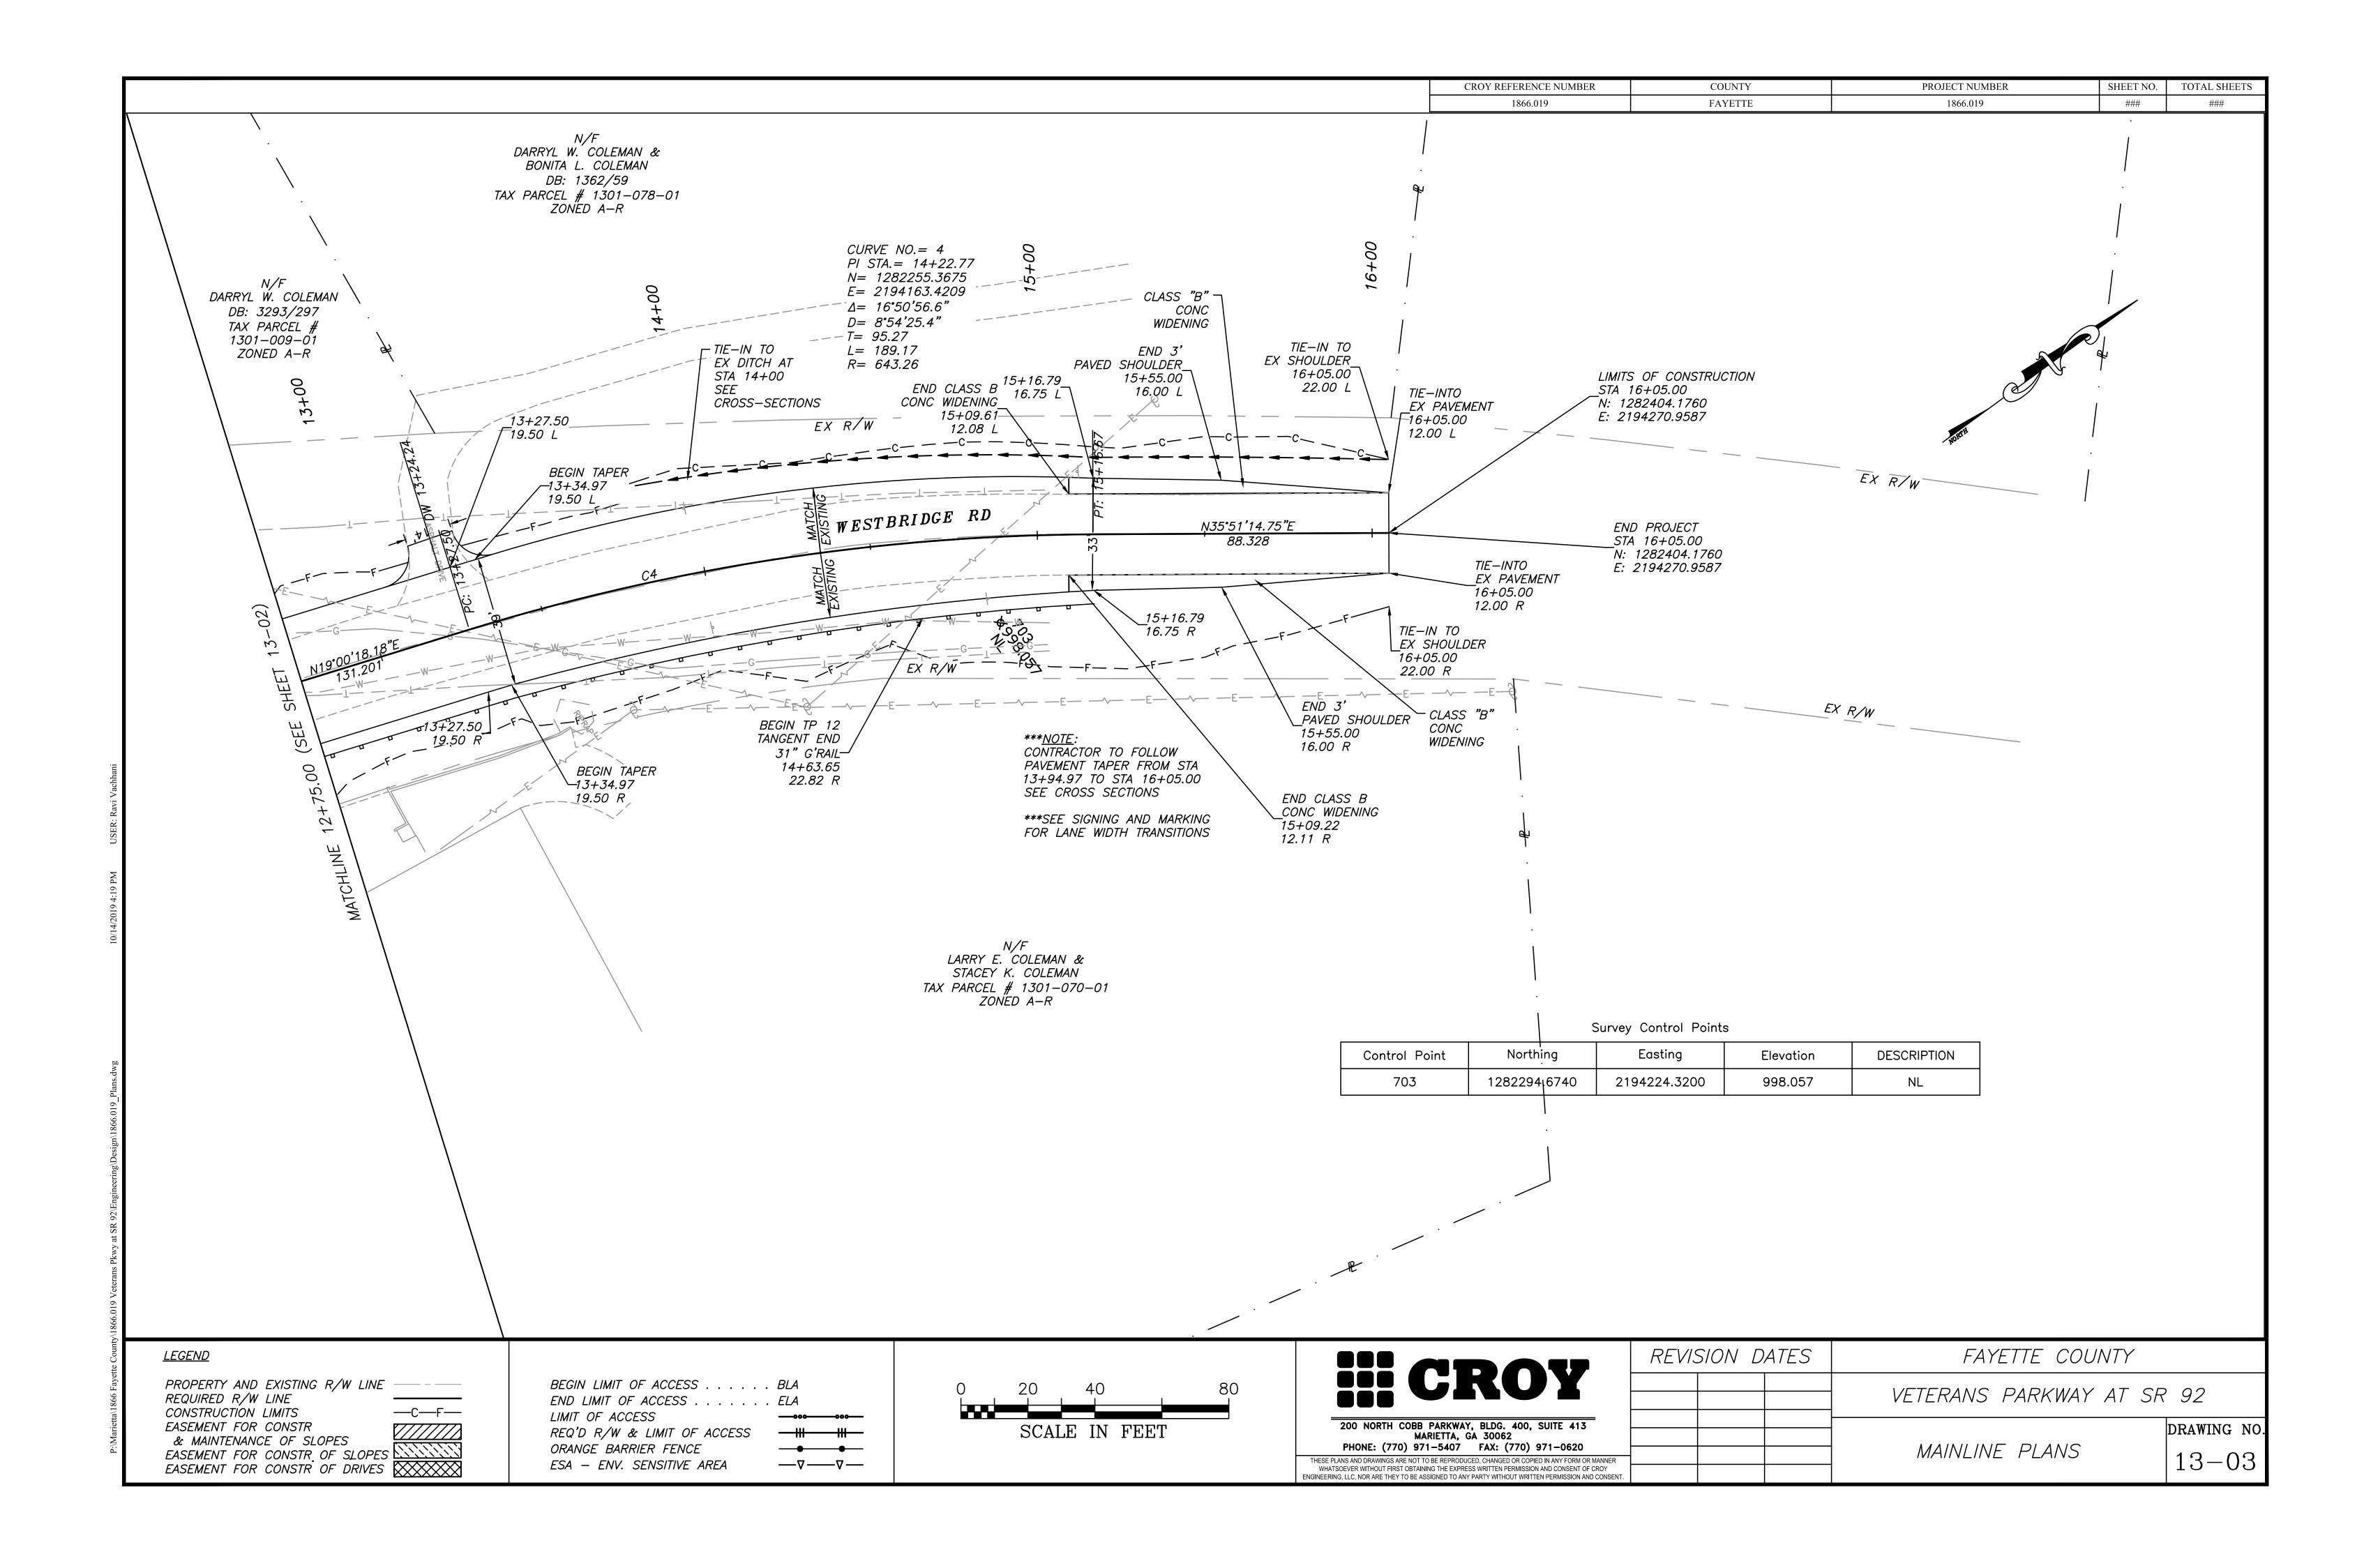


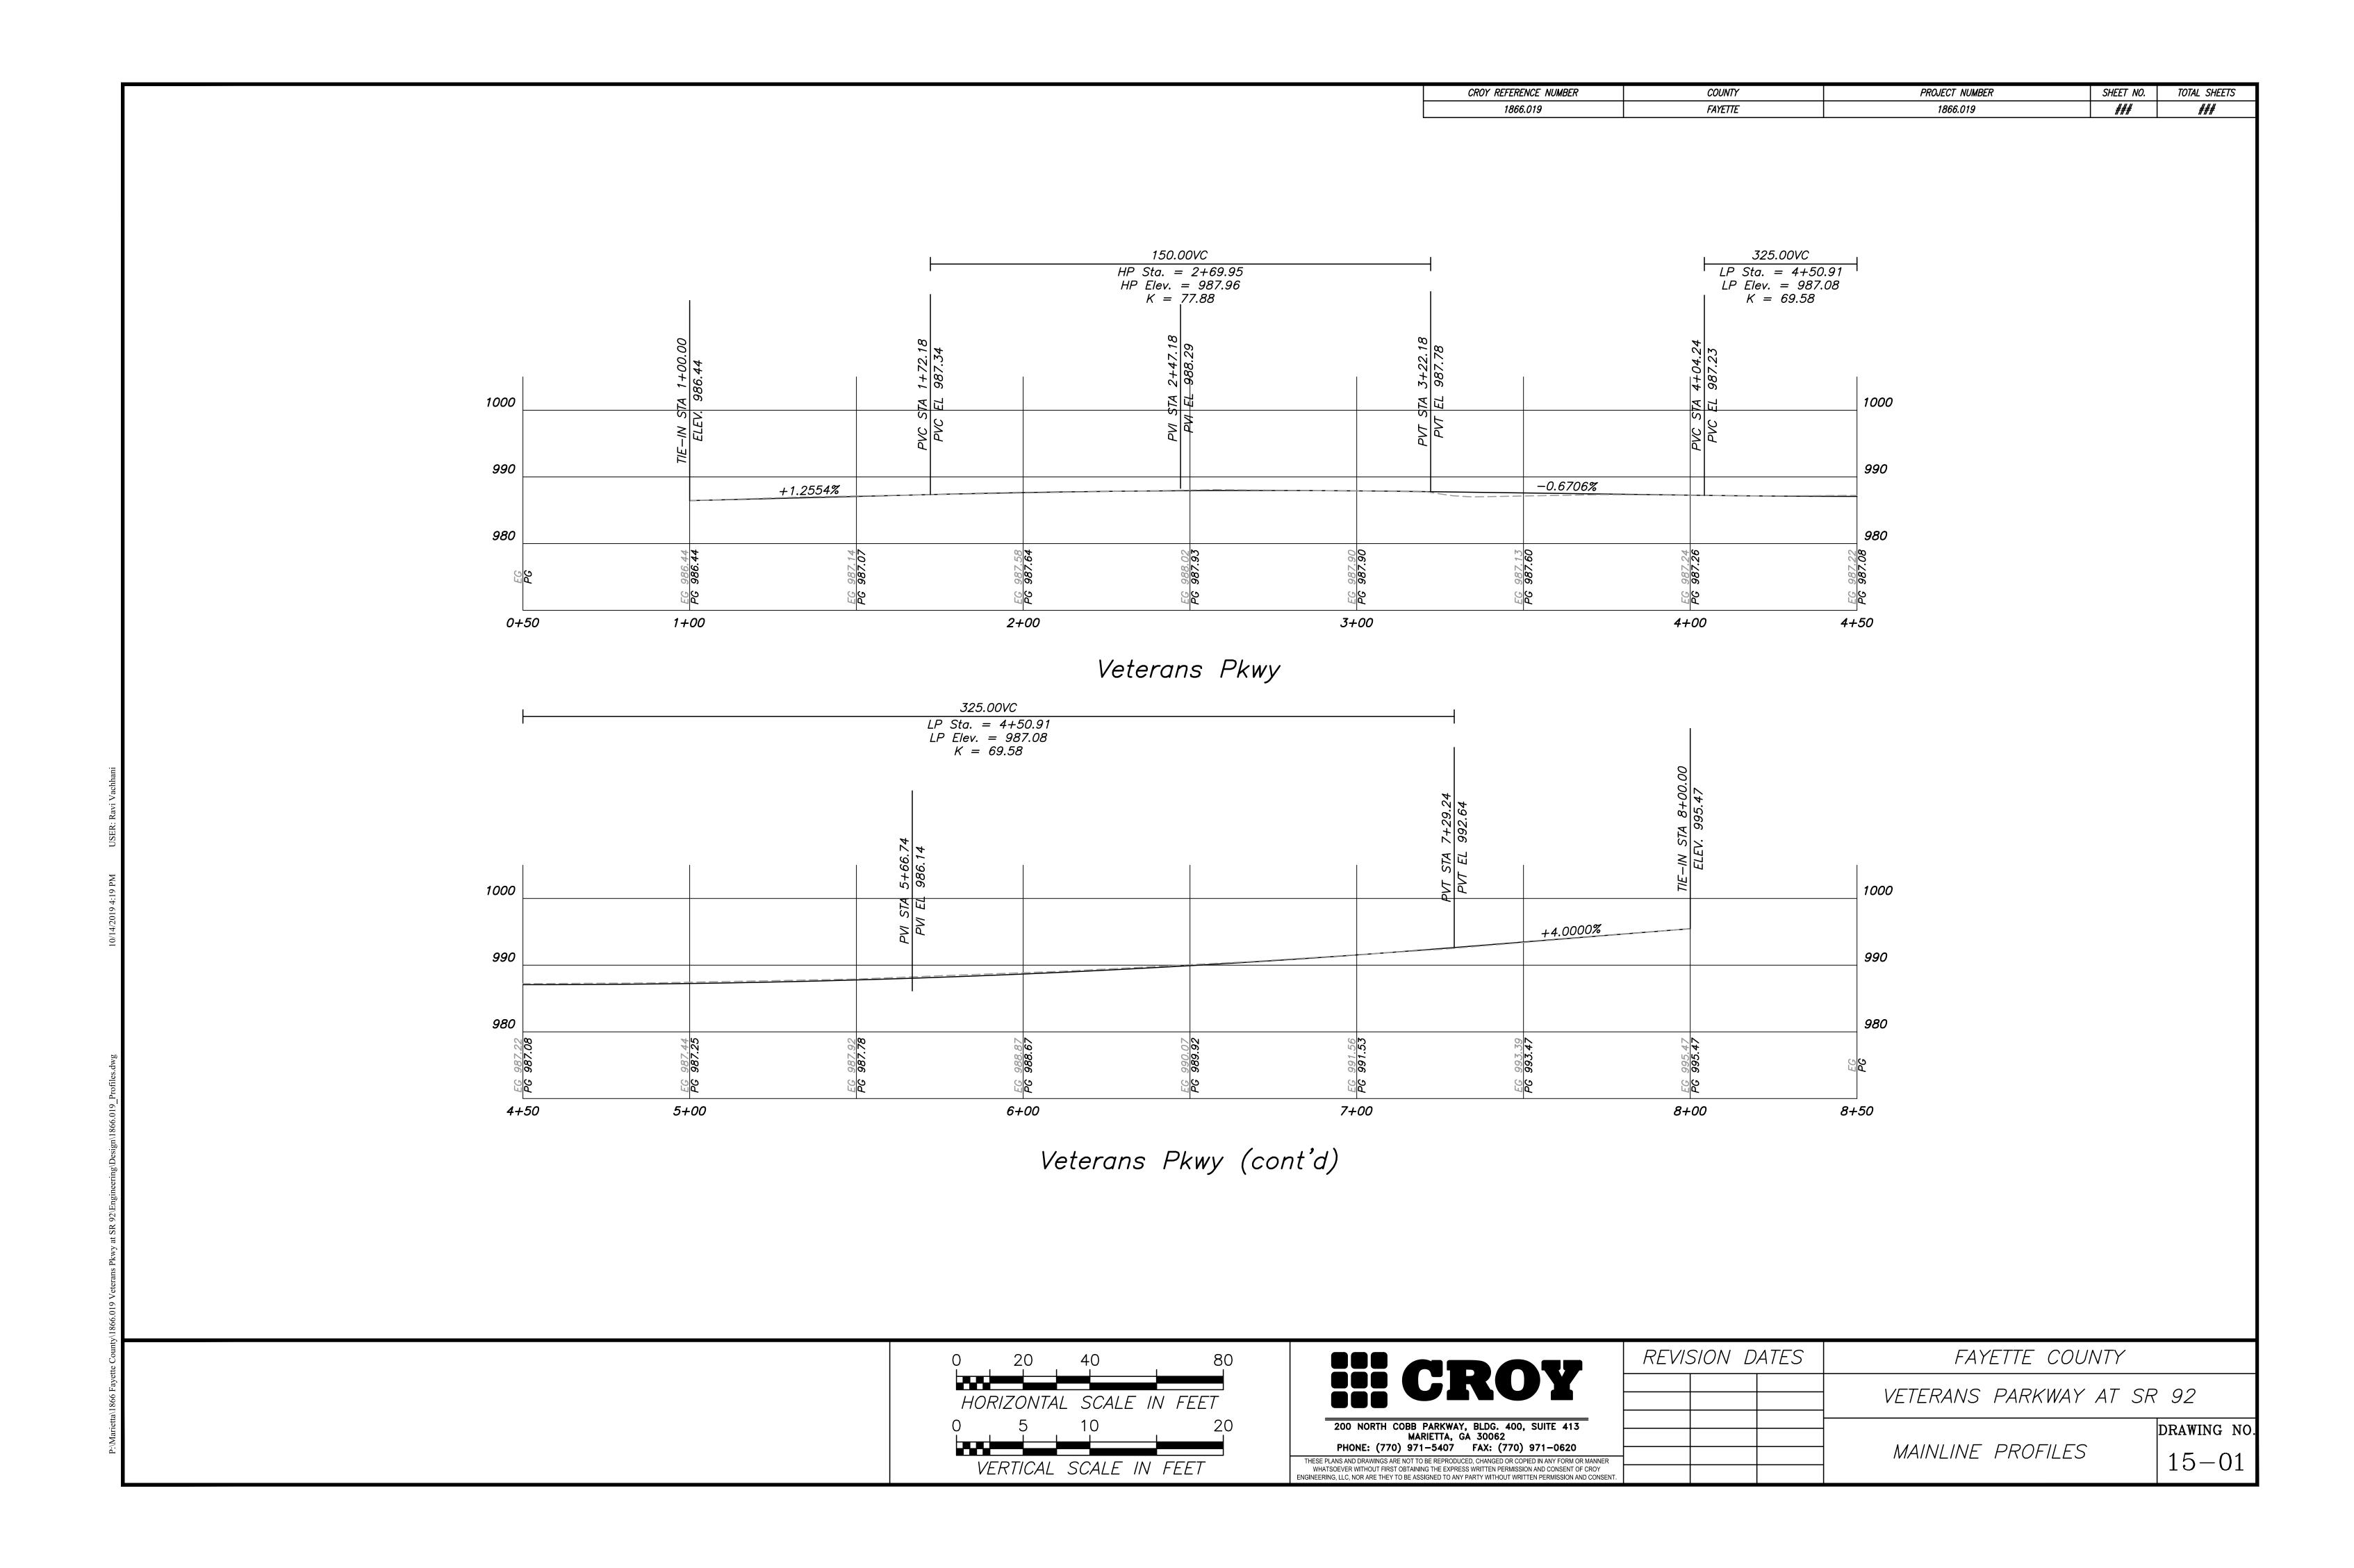

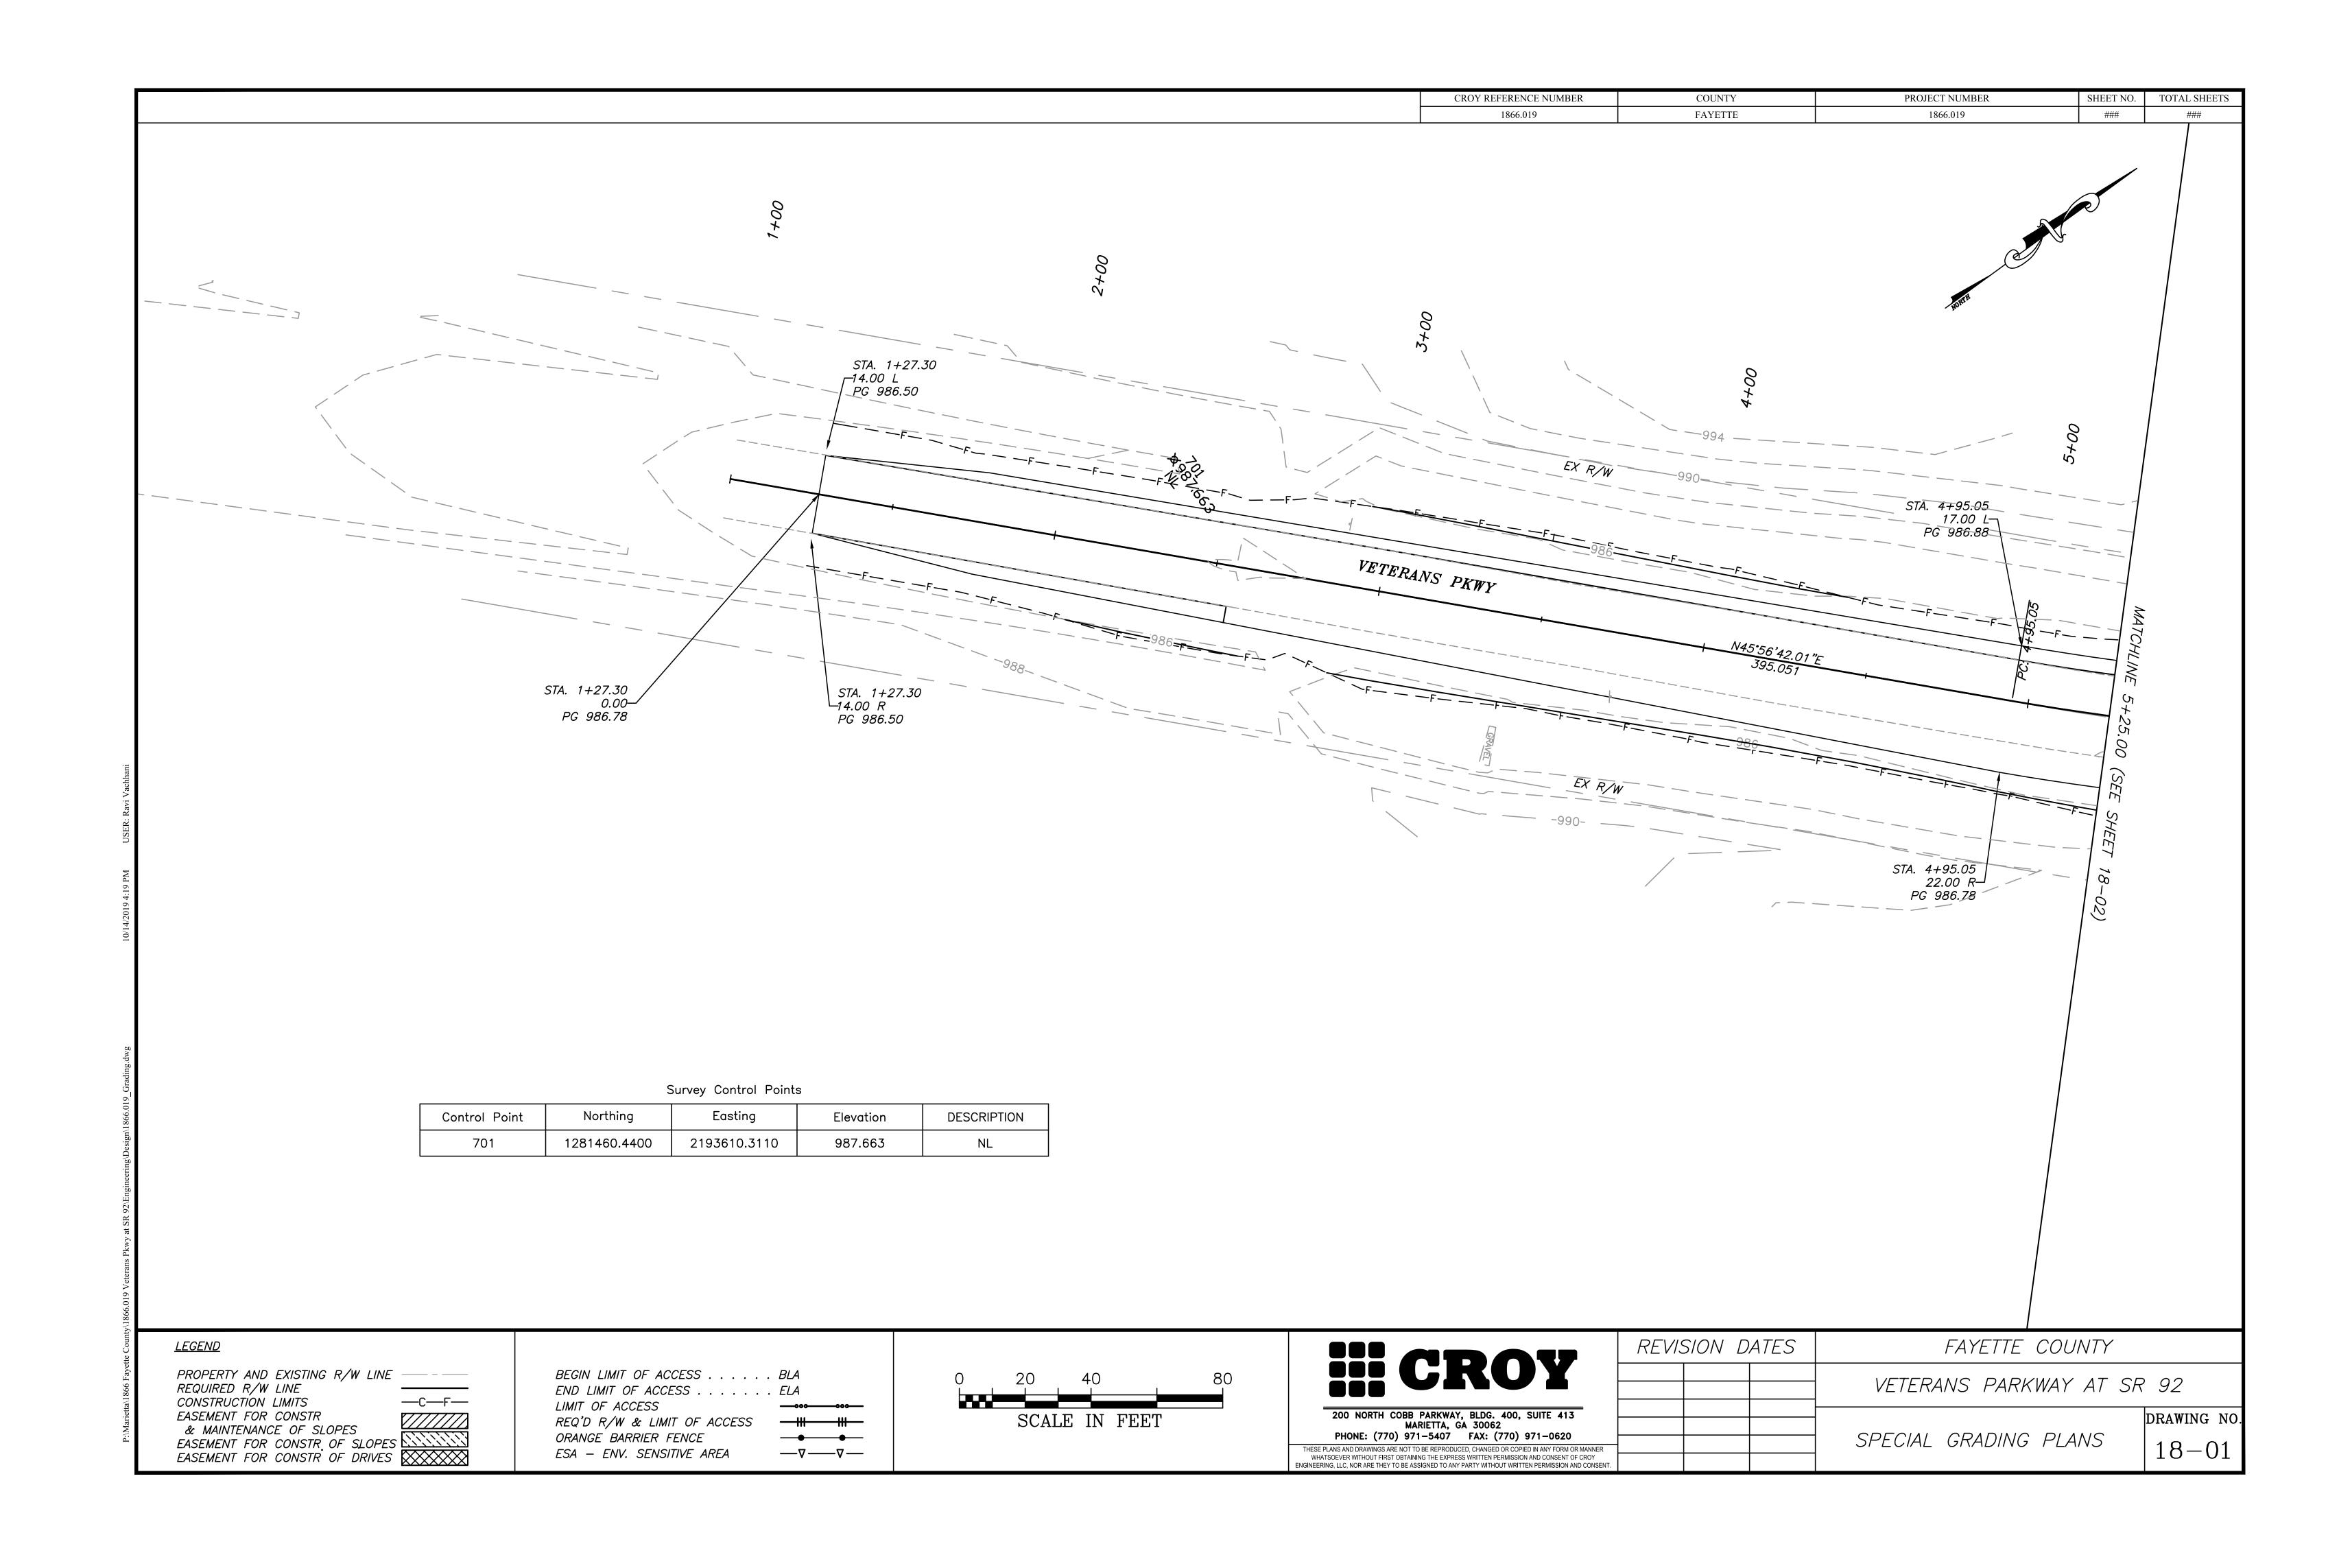


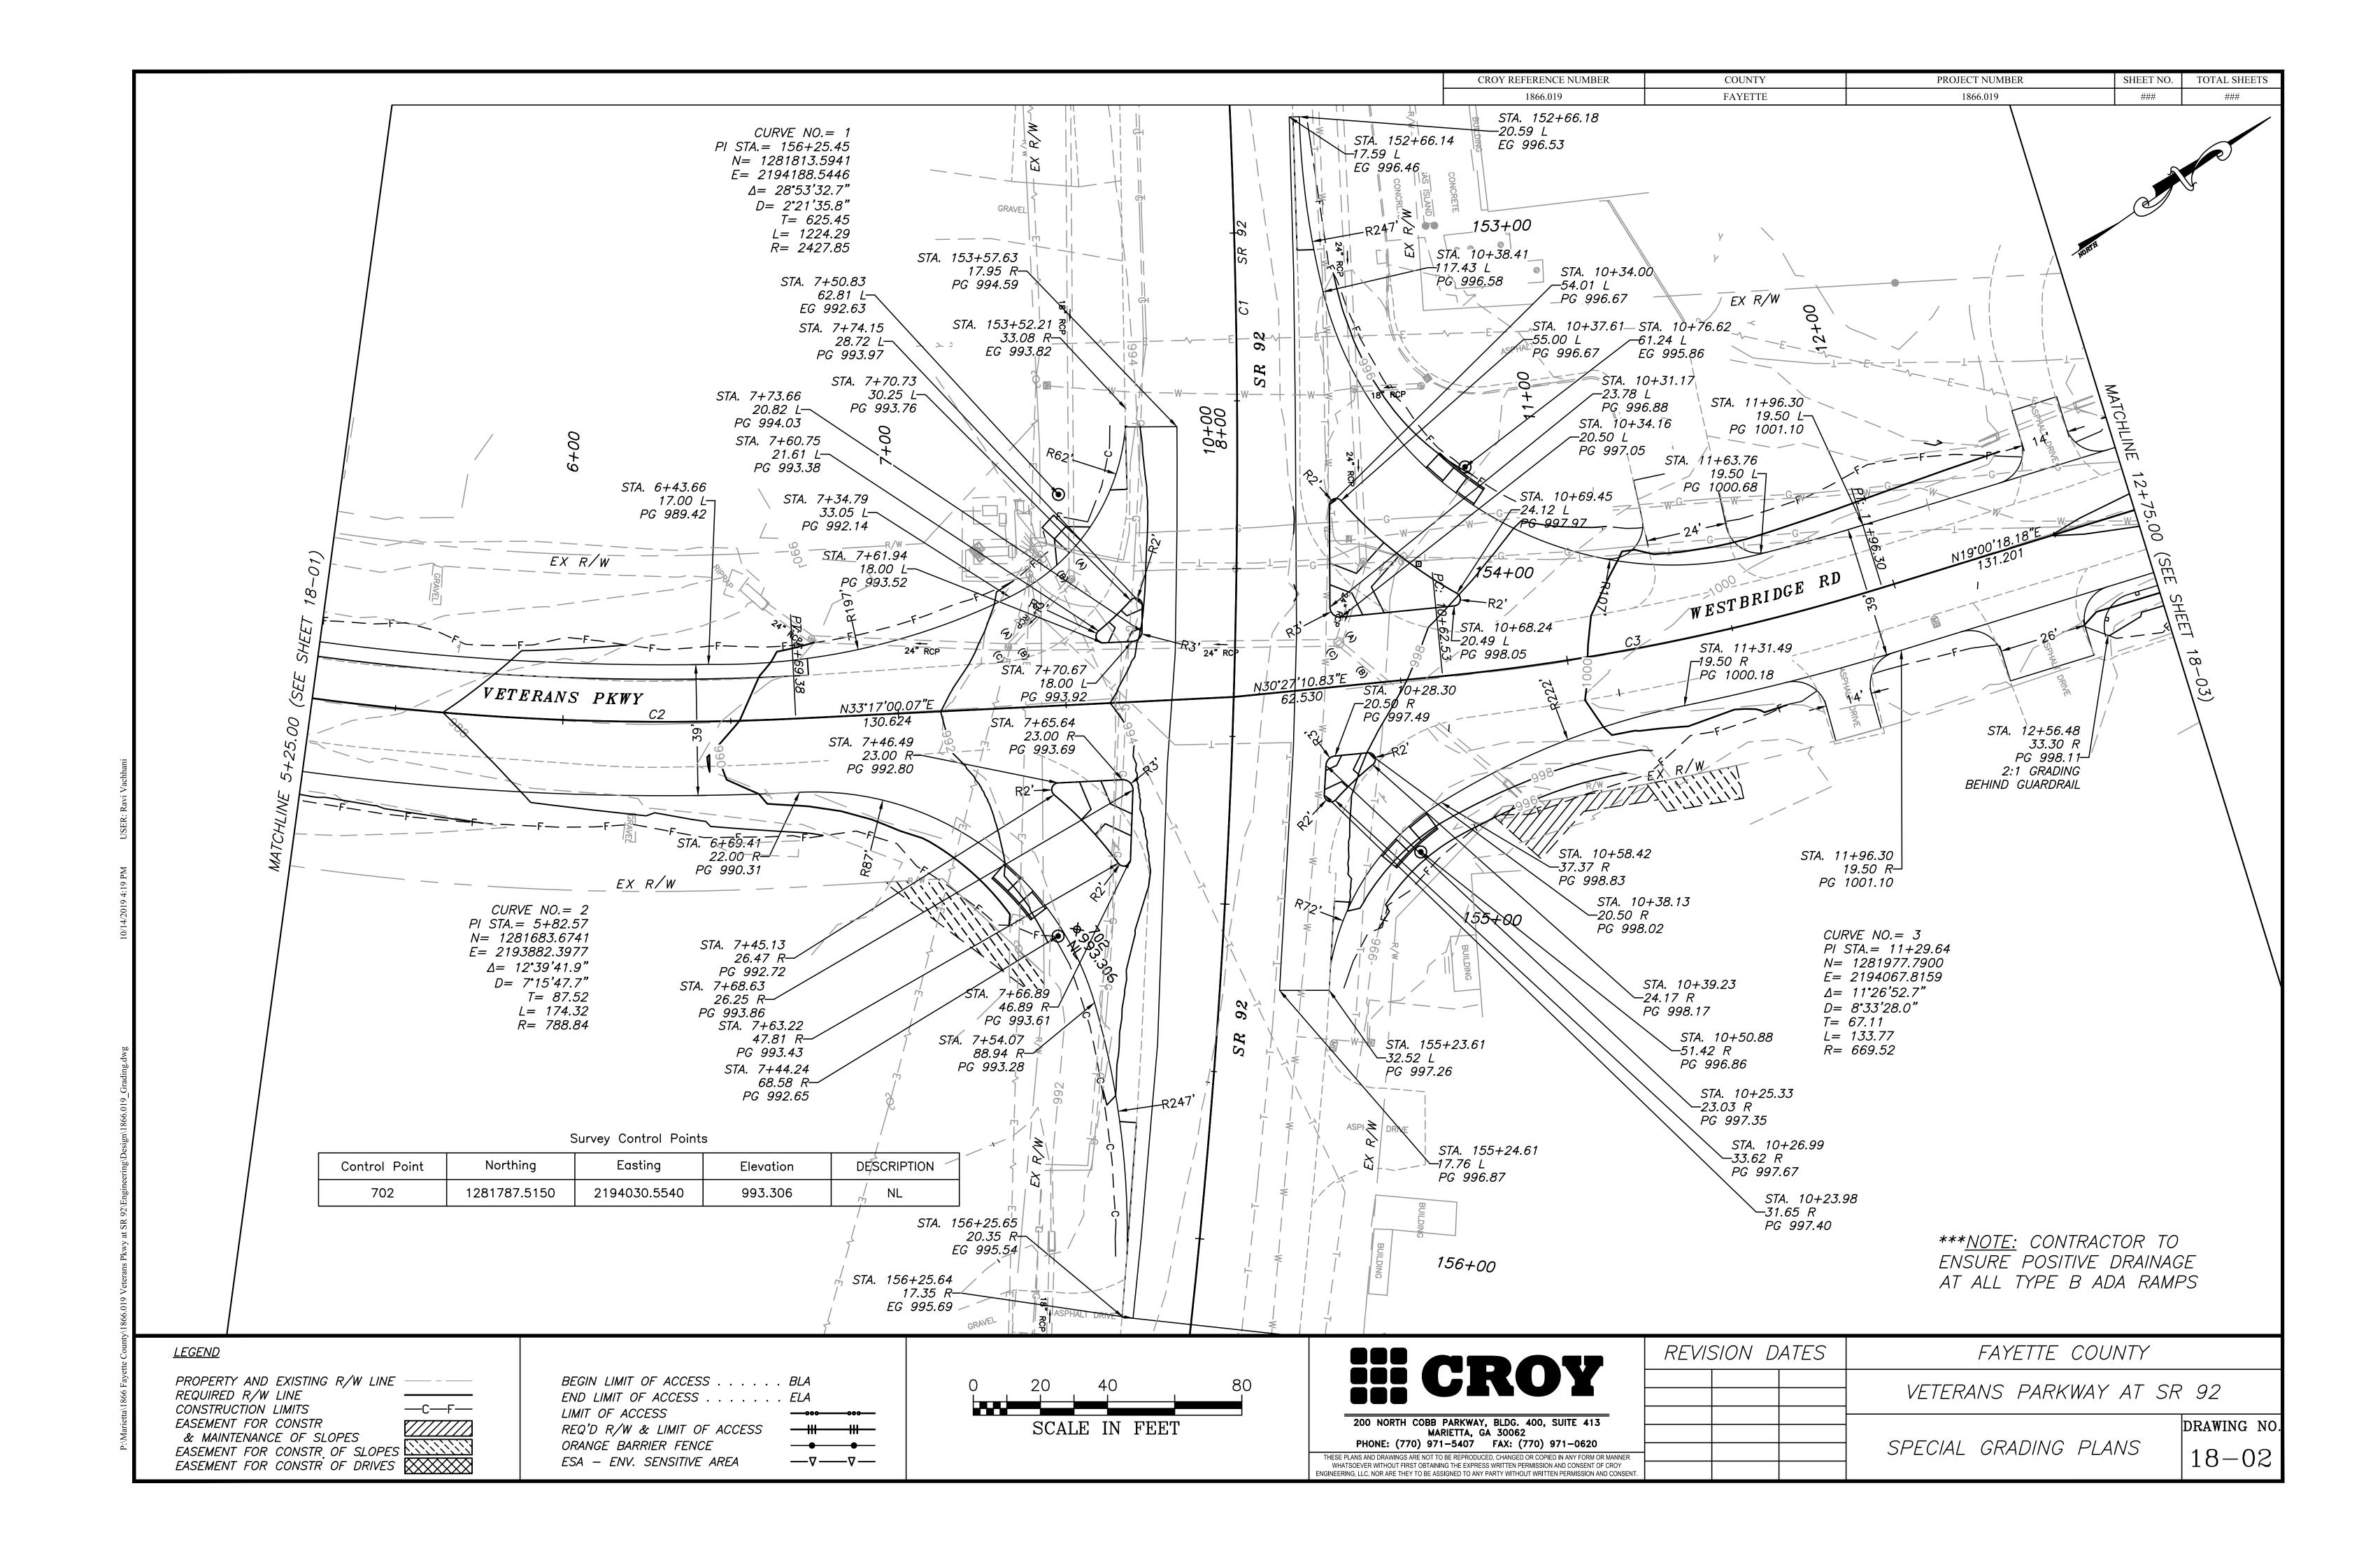


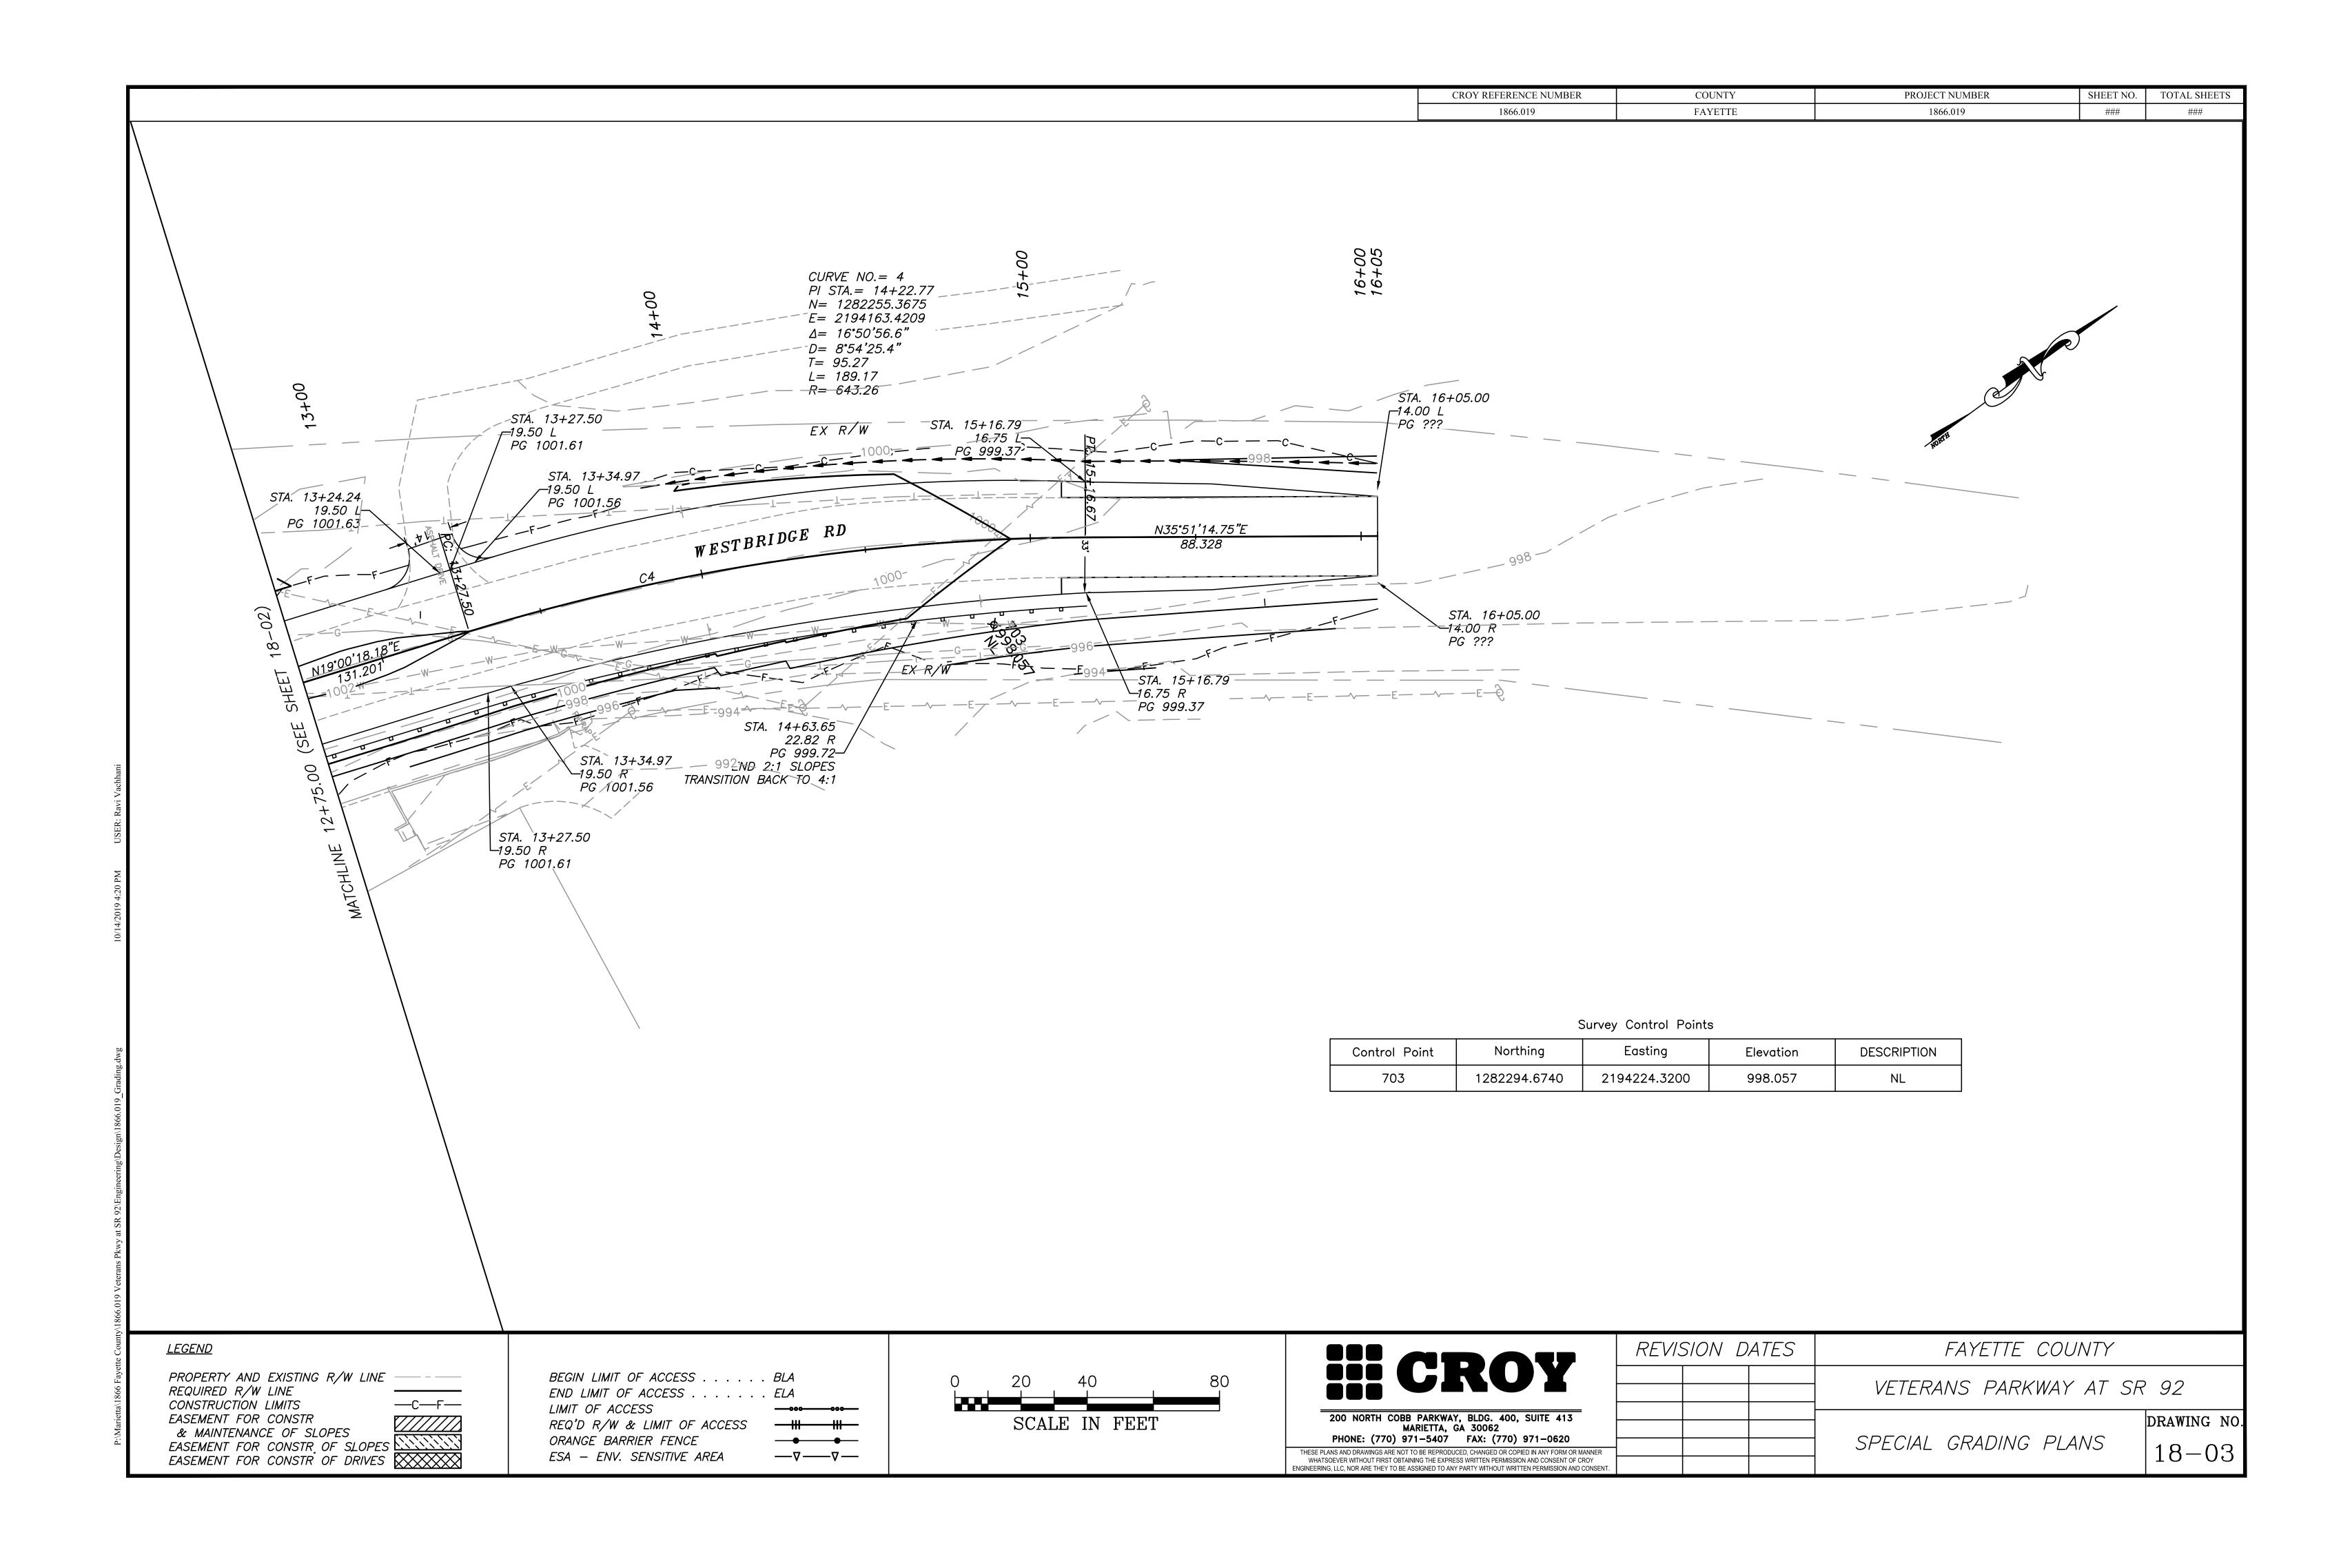


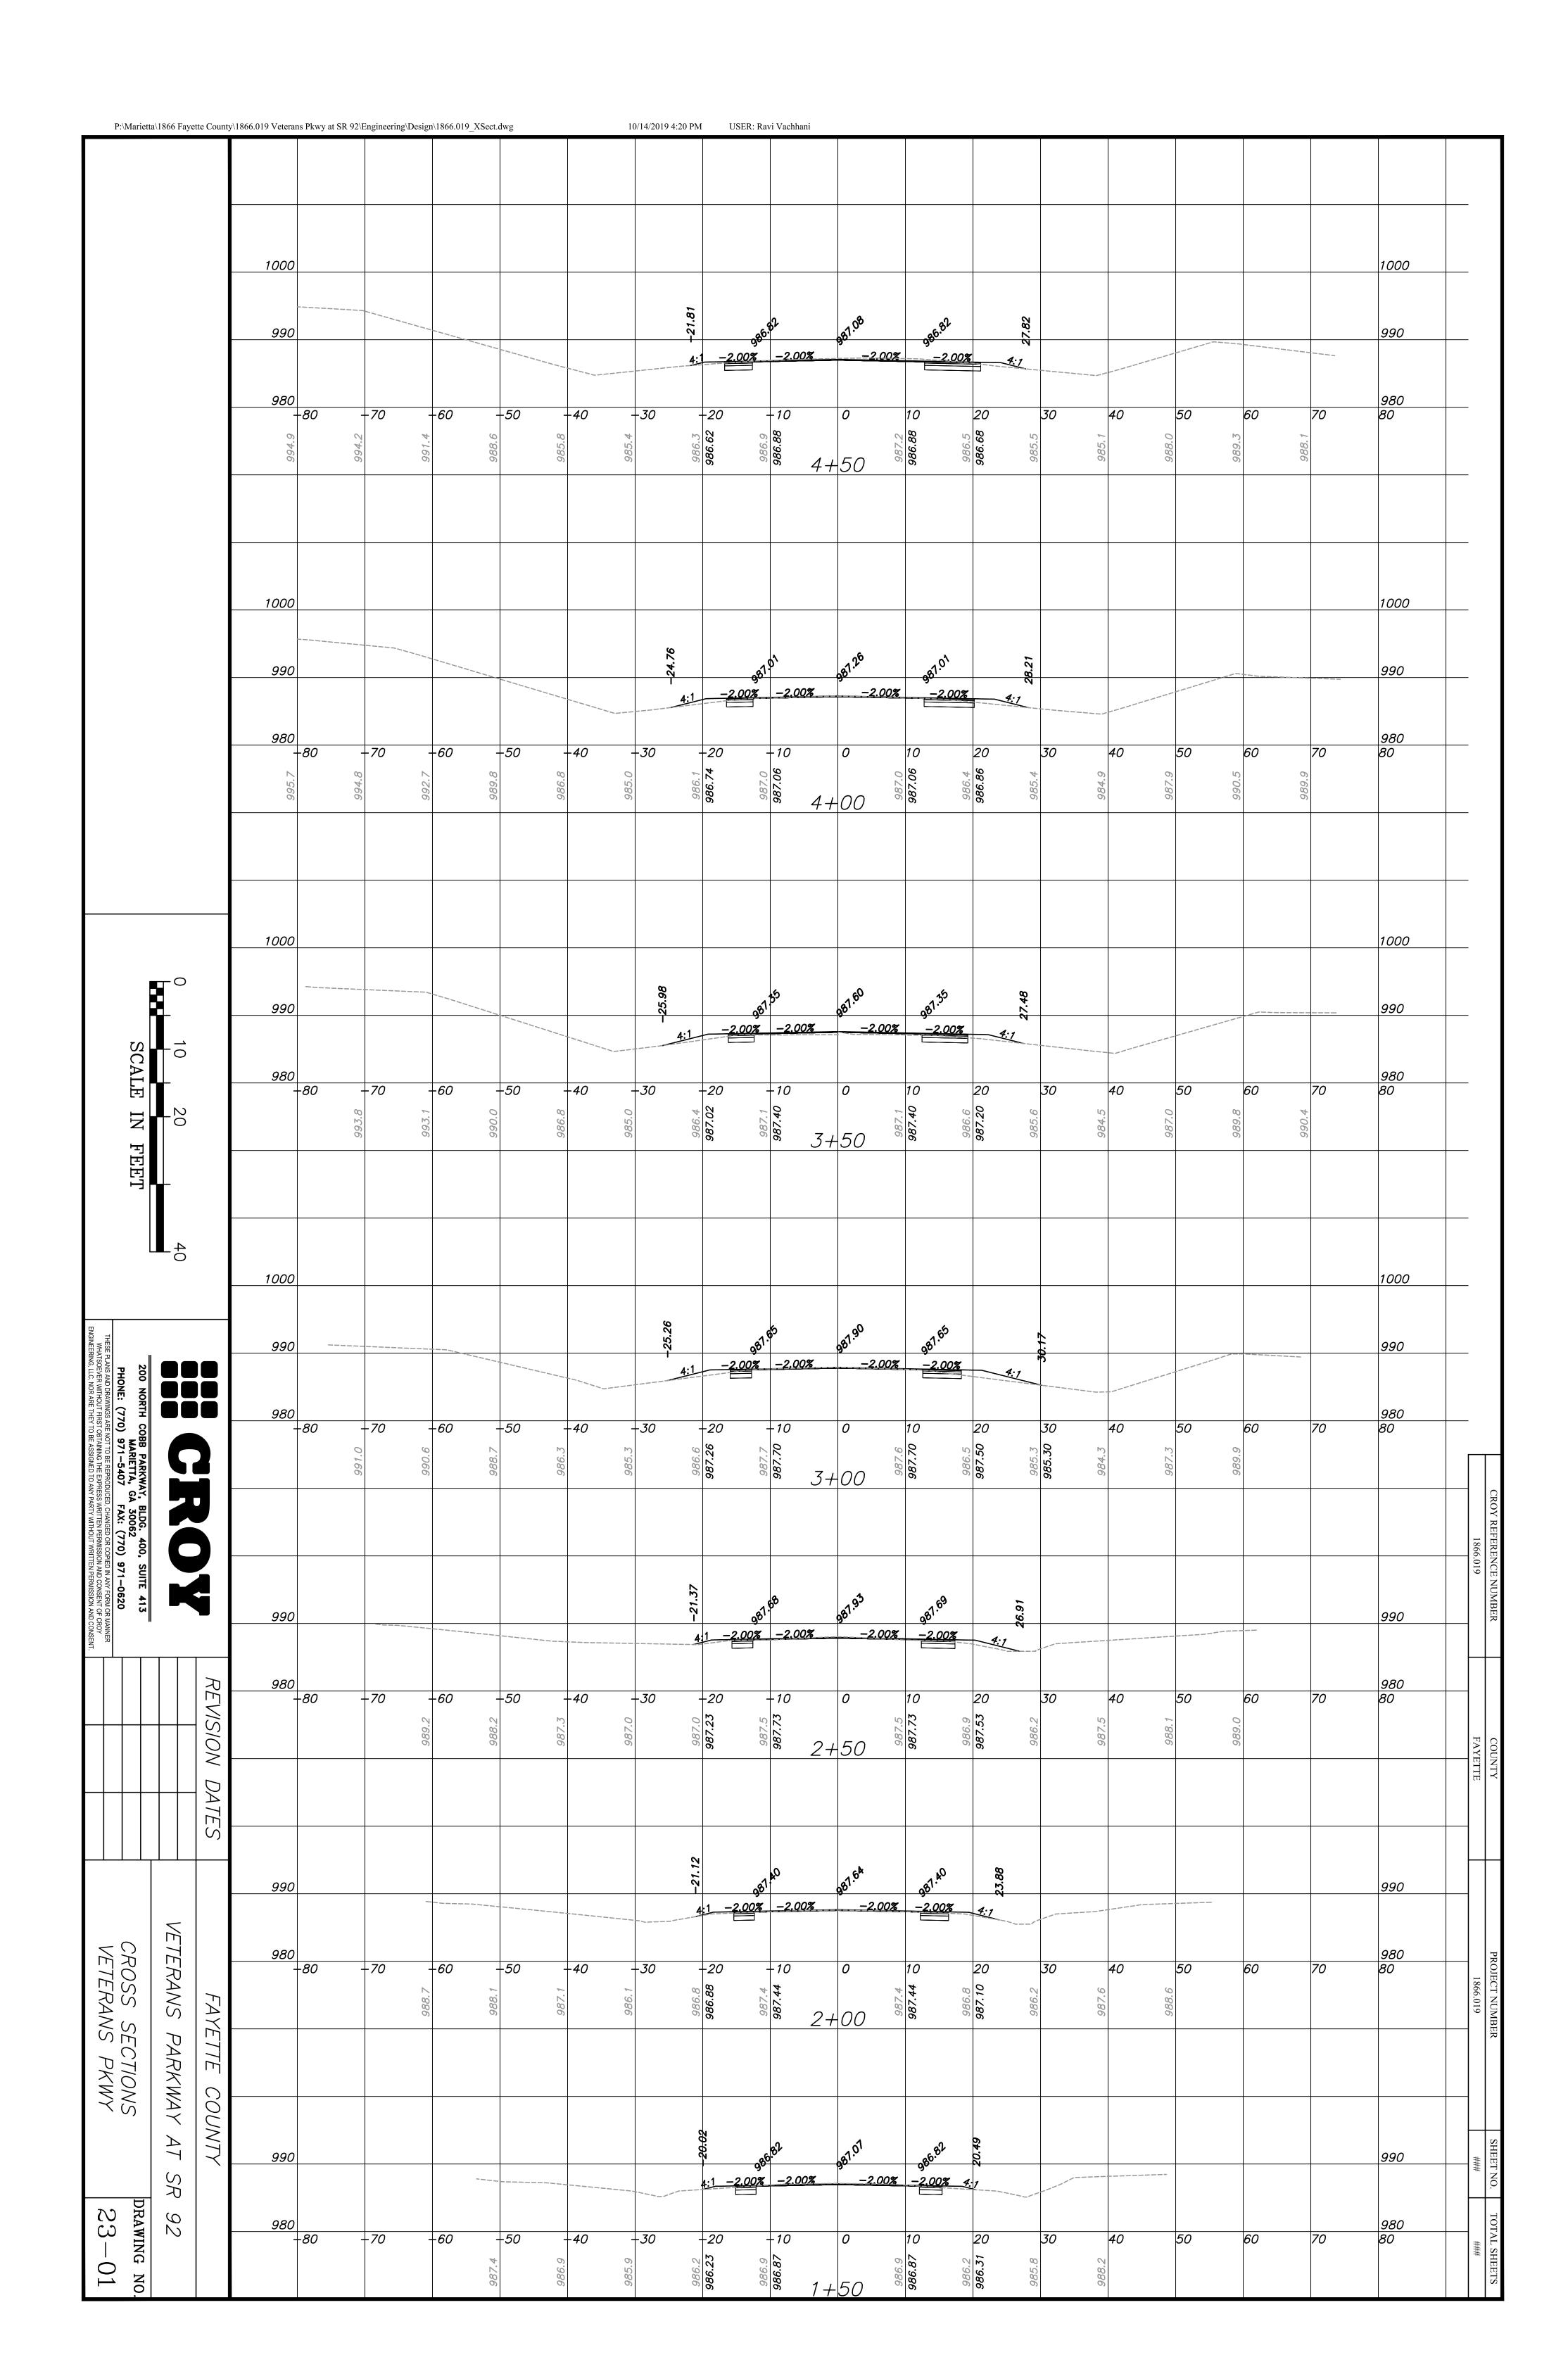



14+50

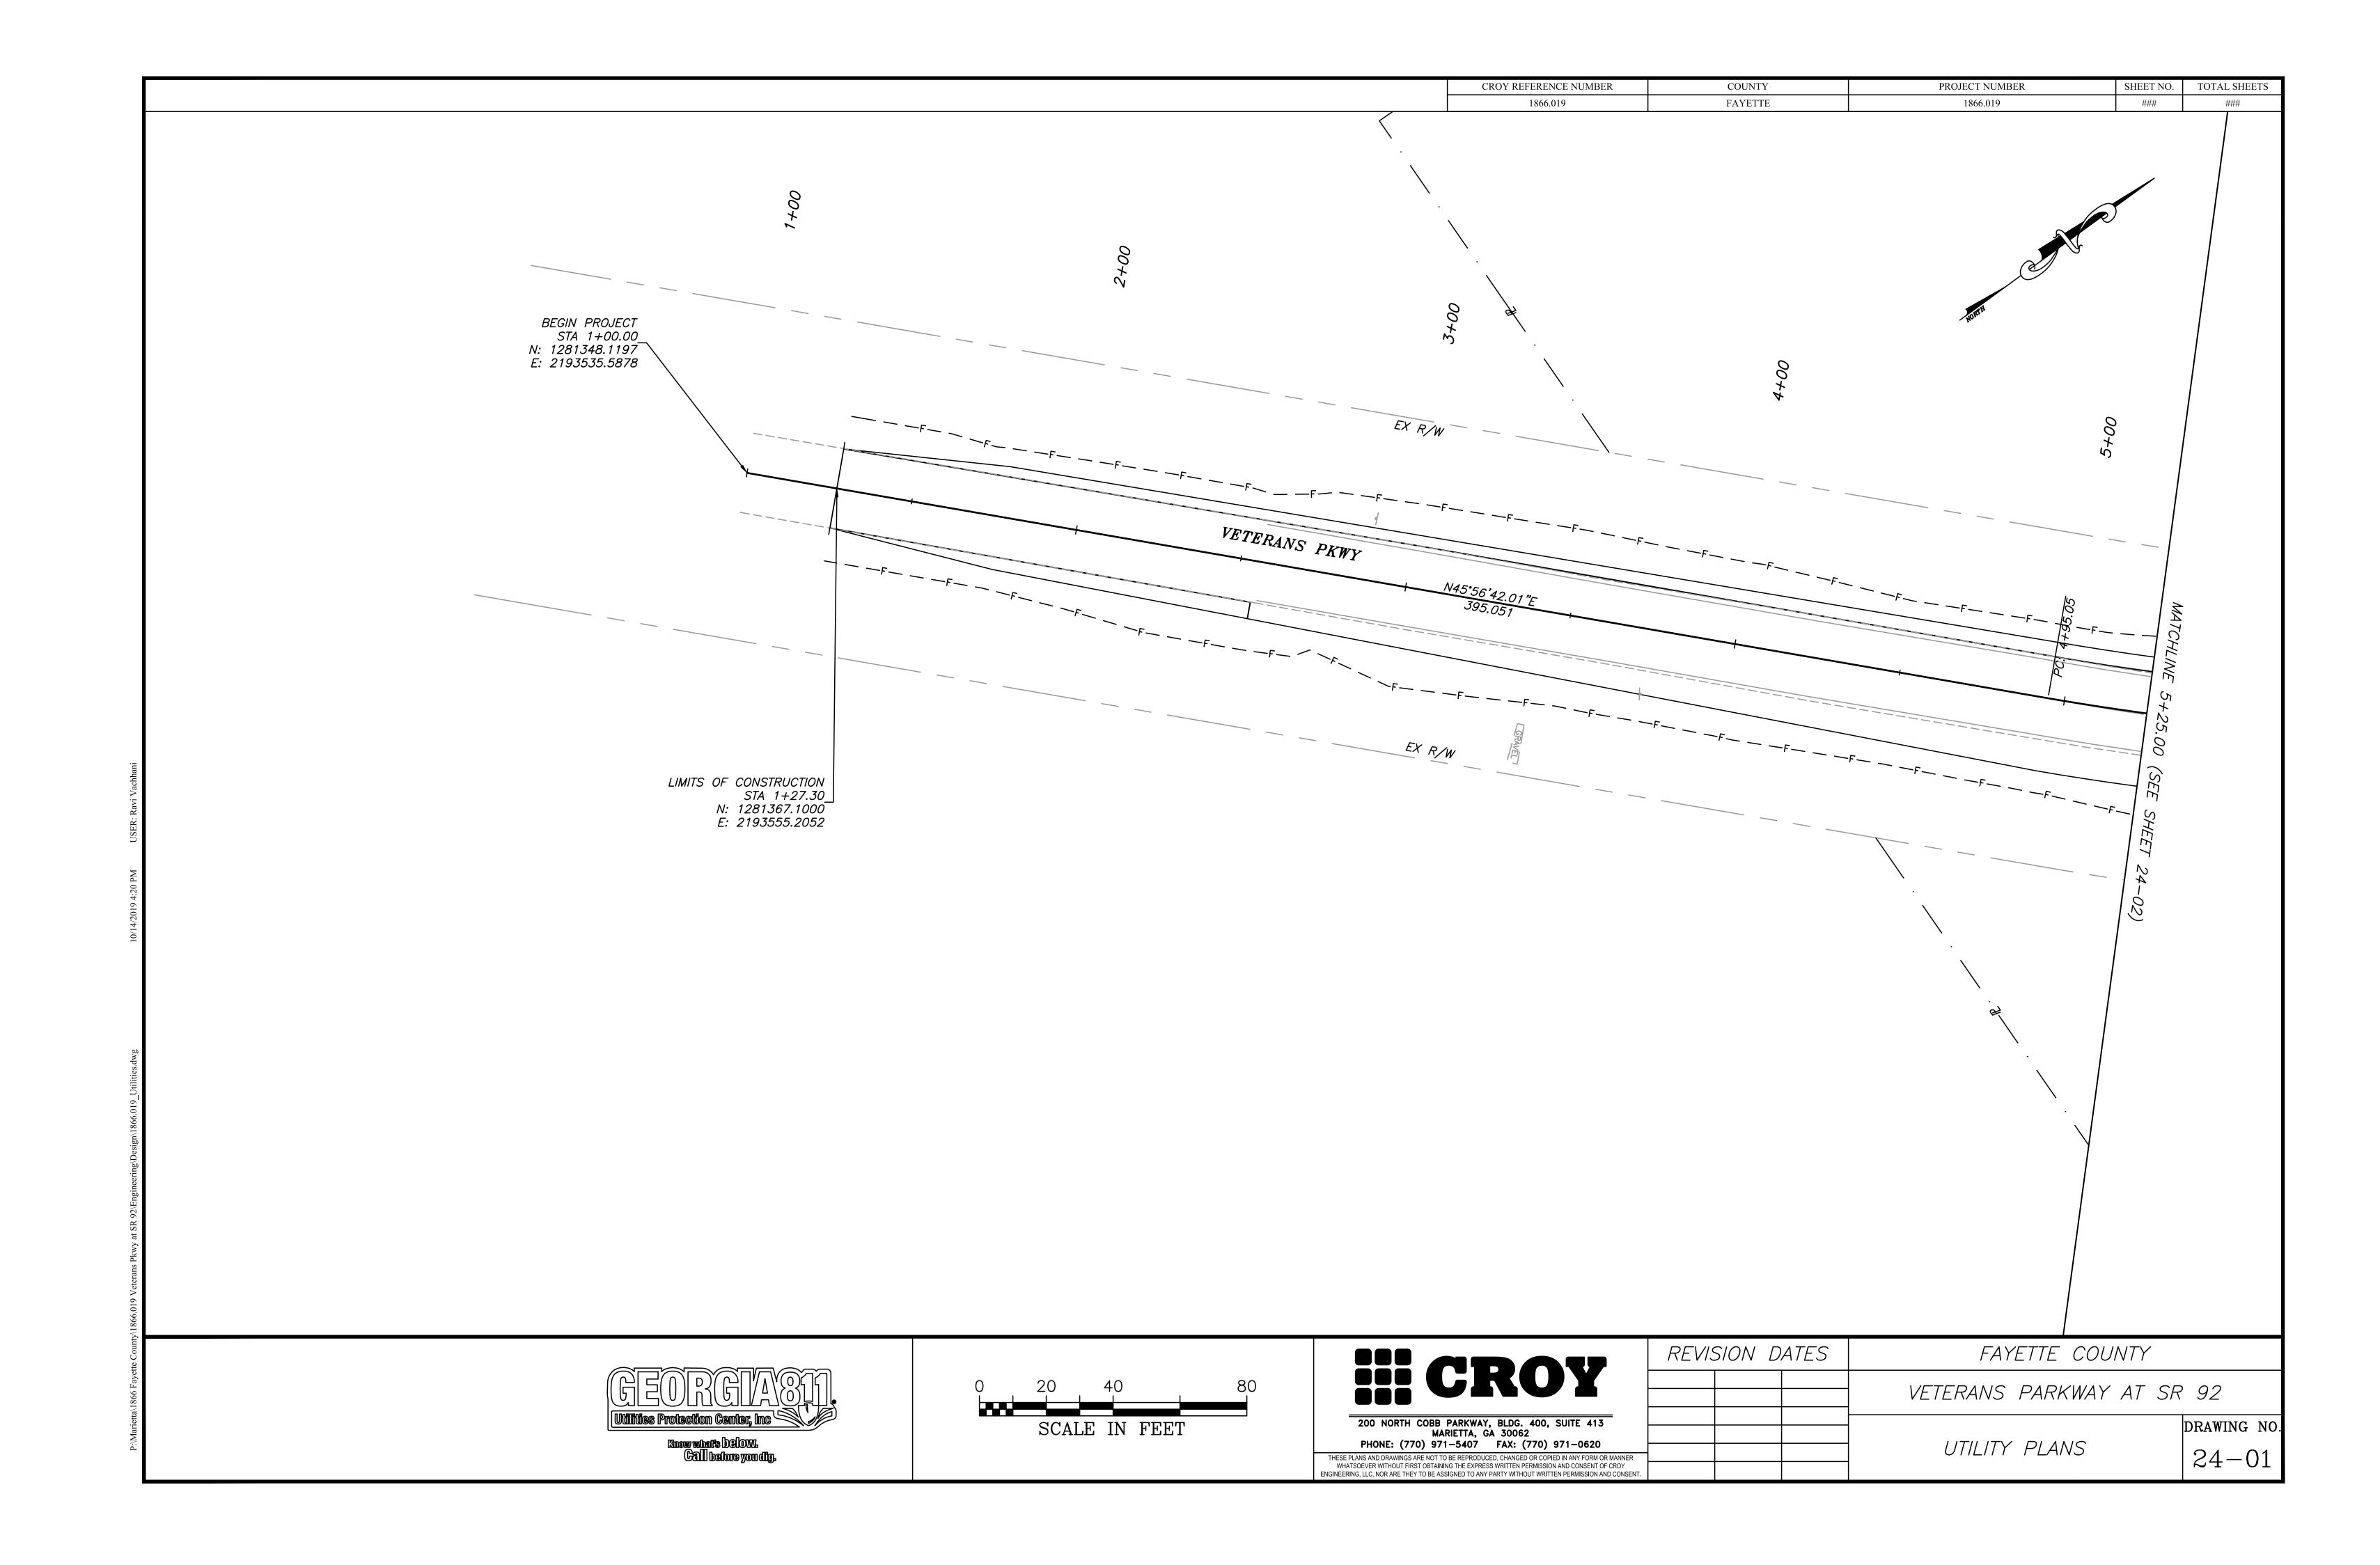


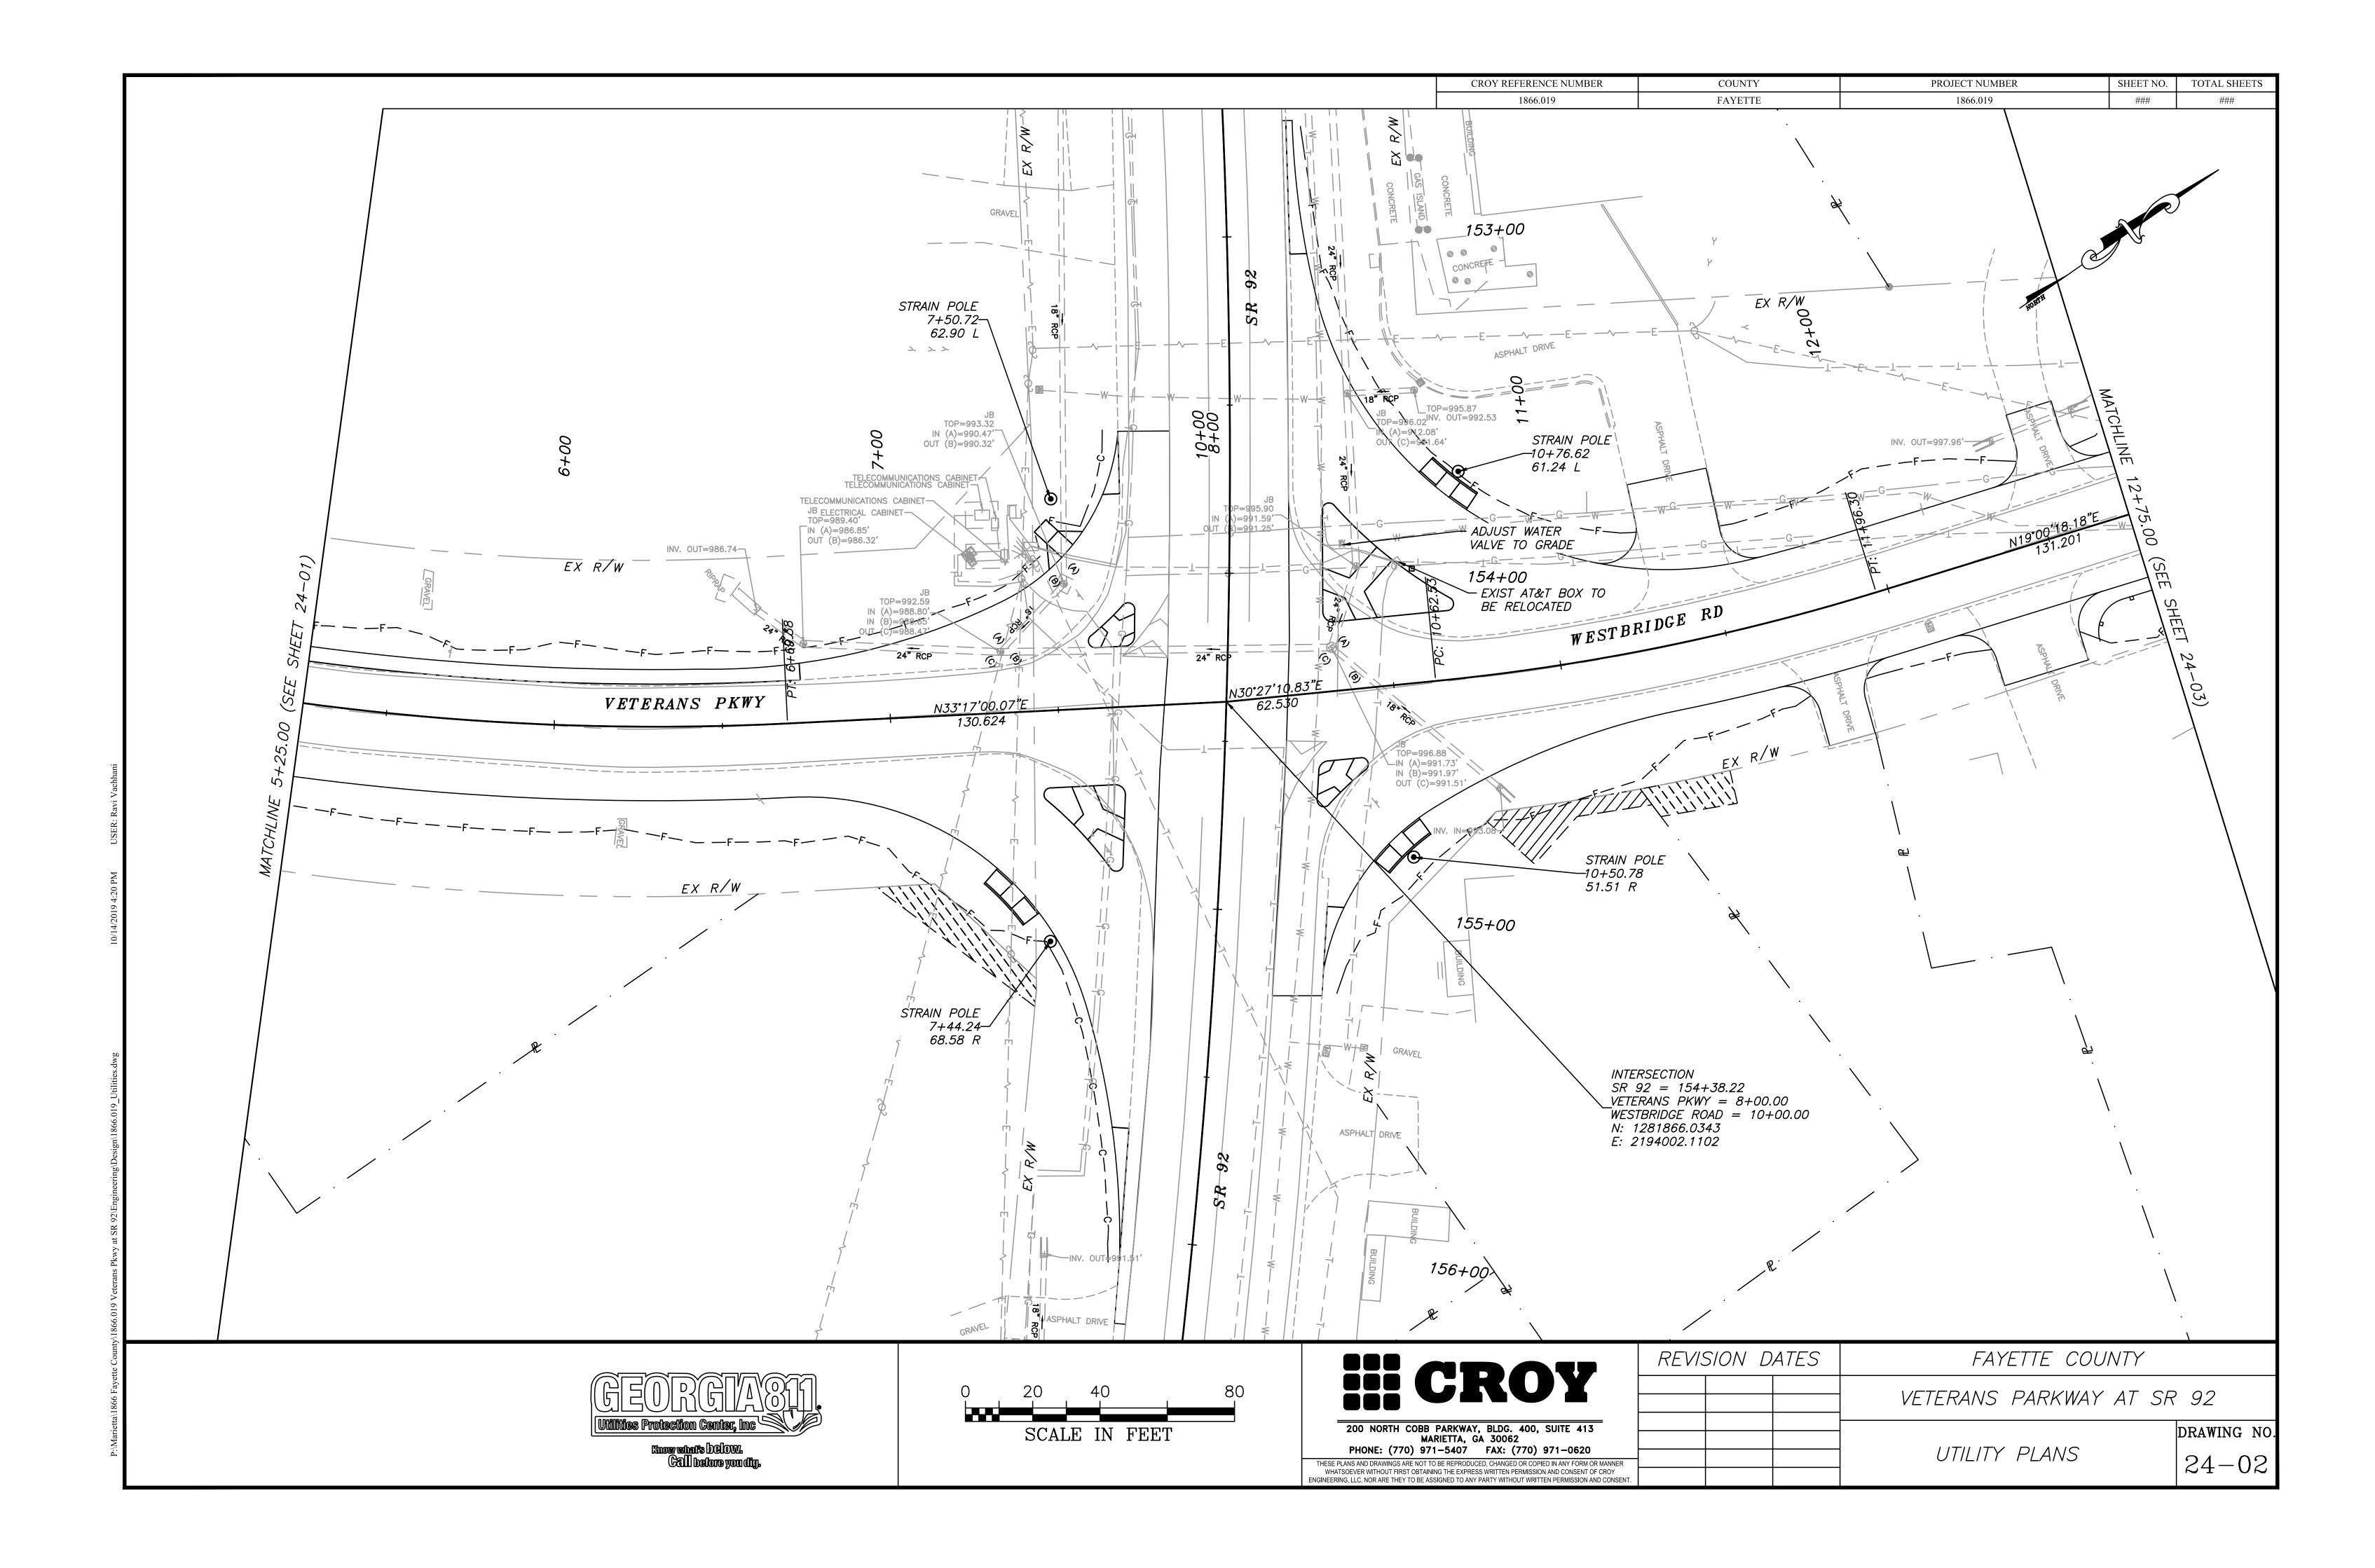

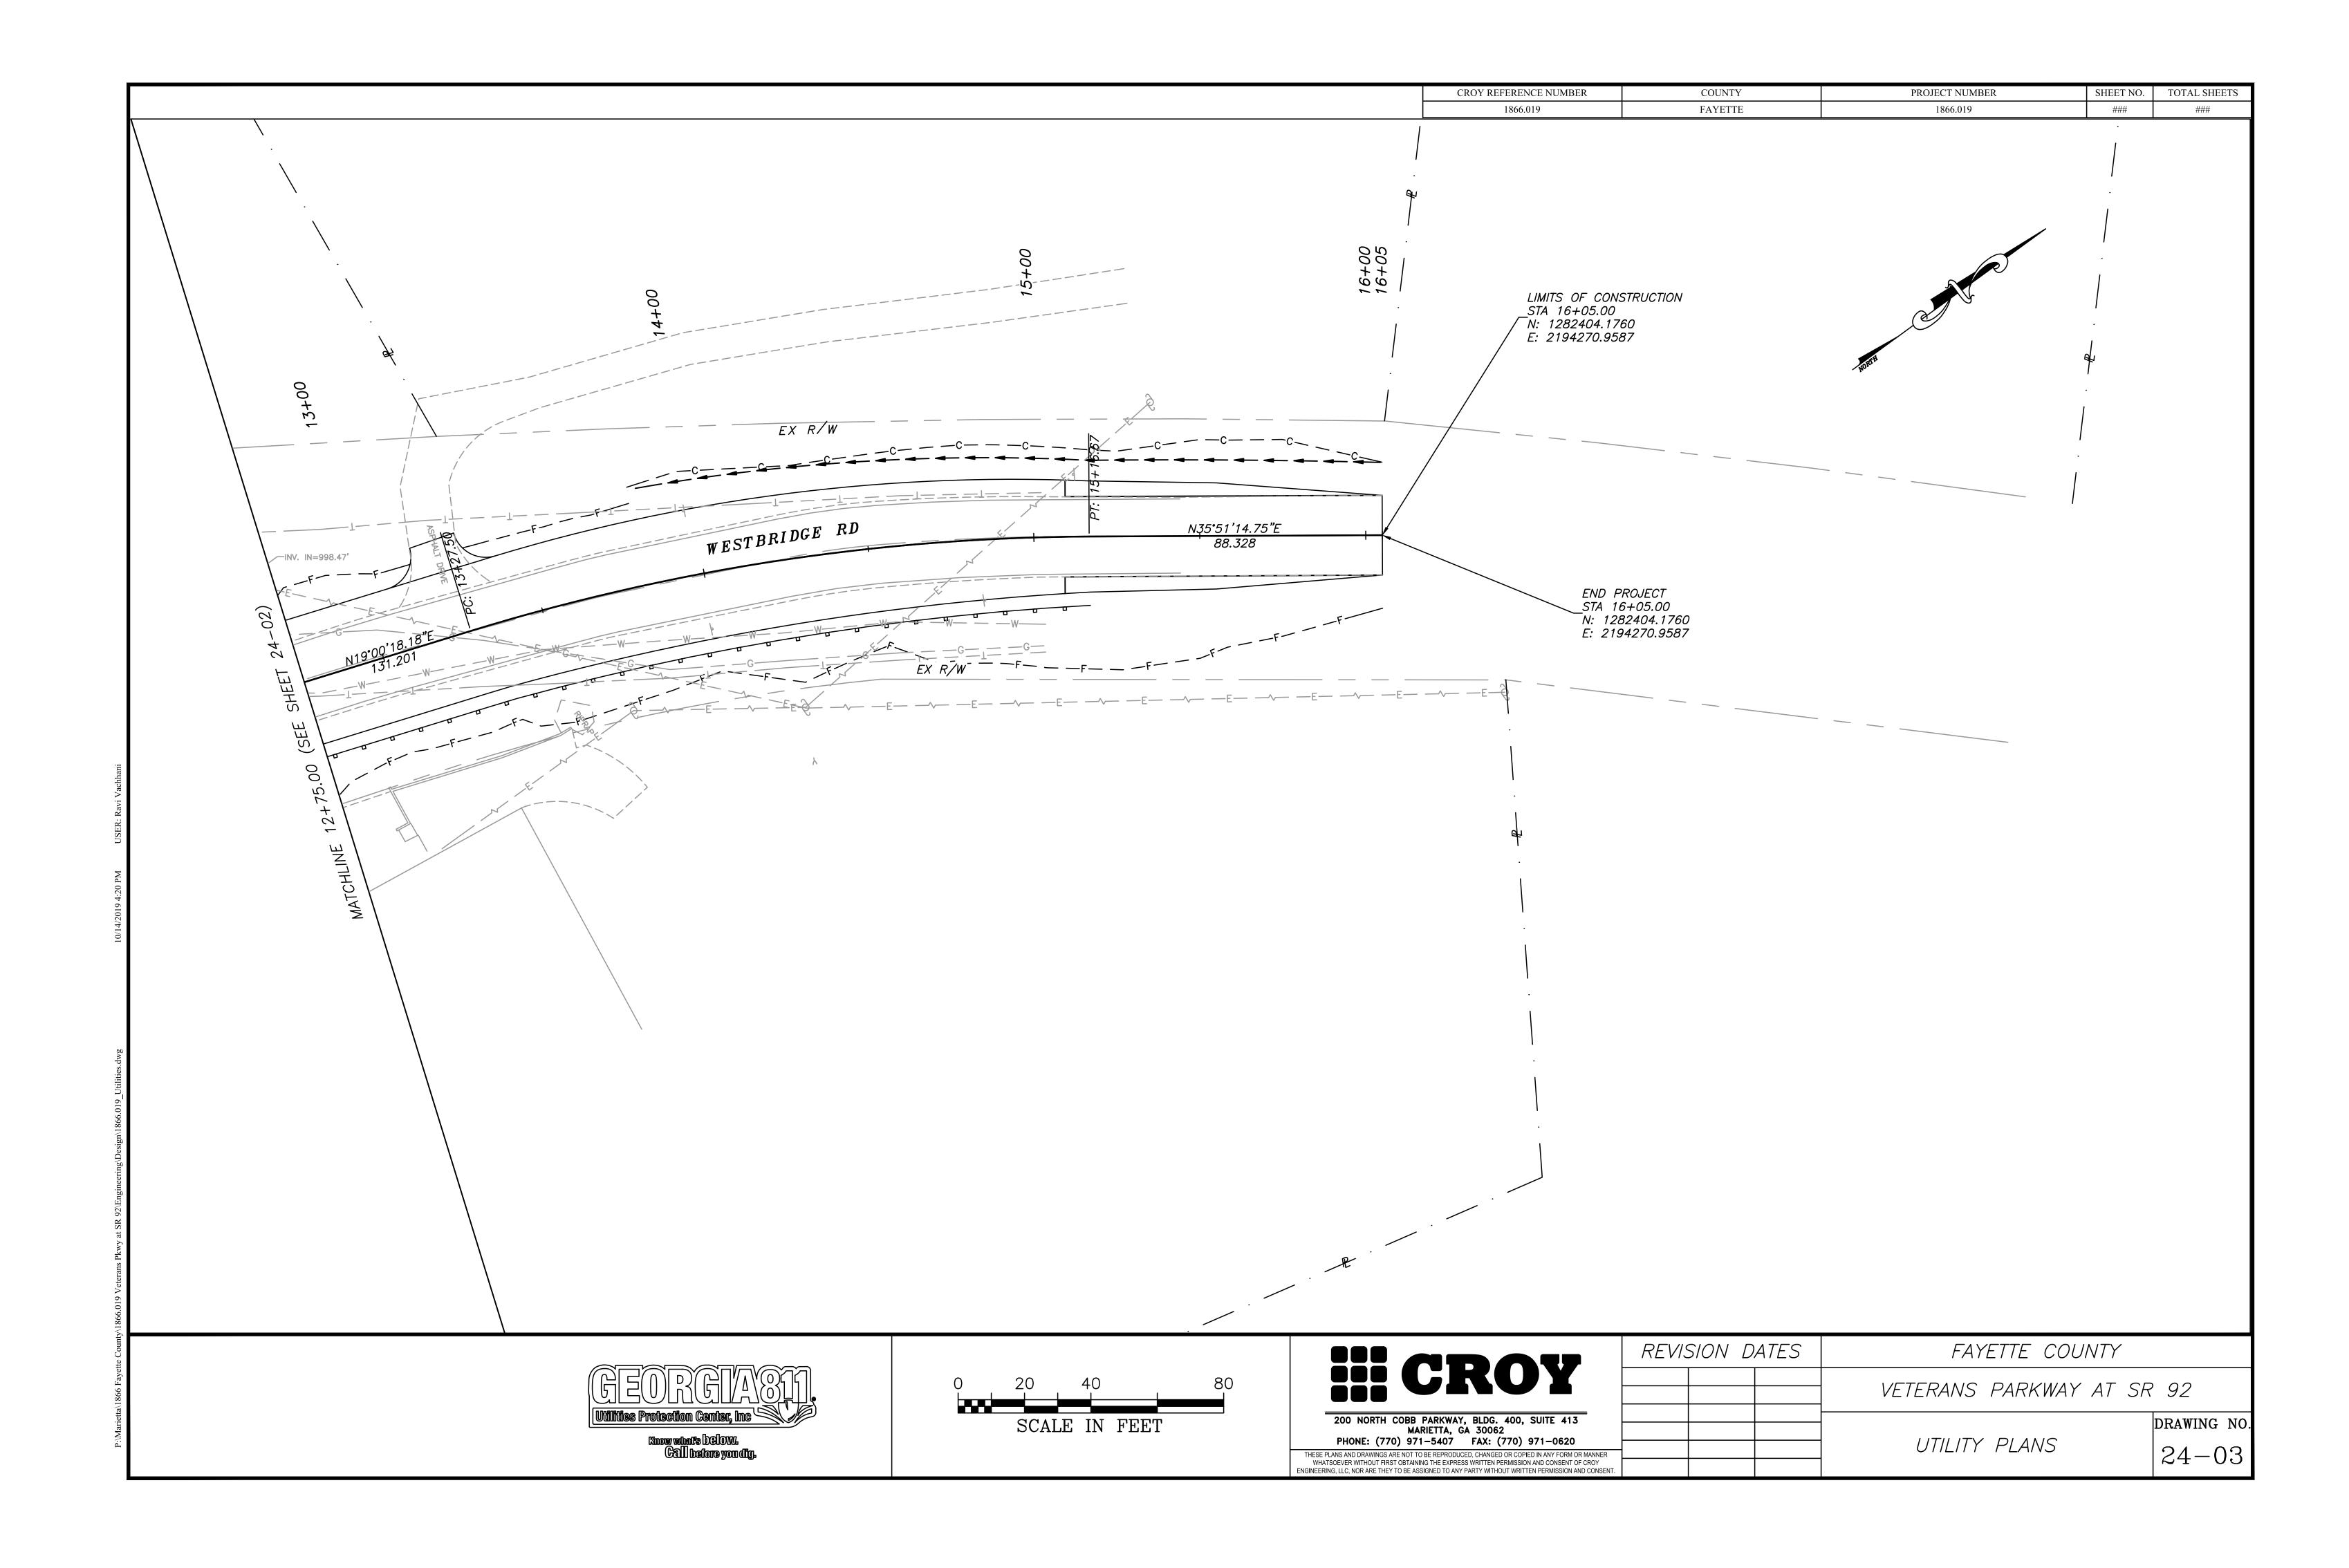

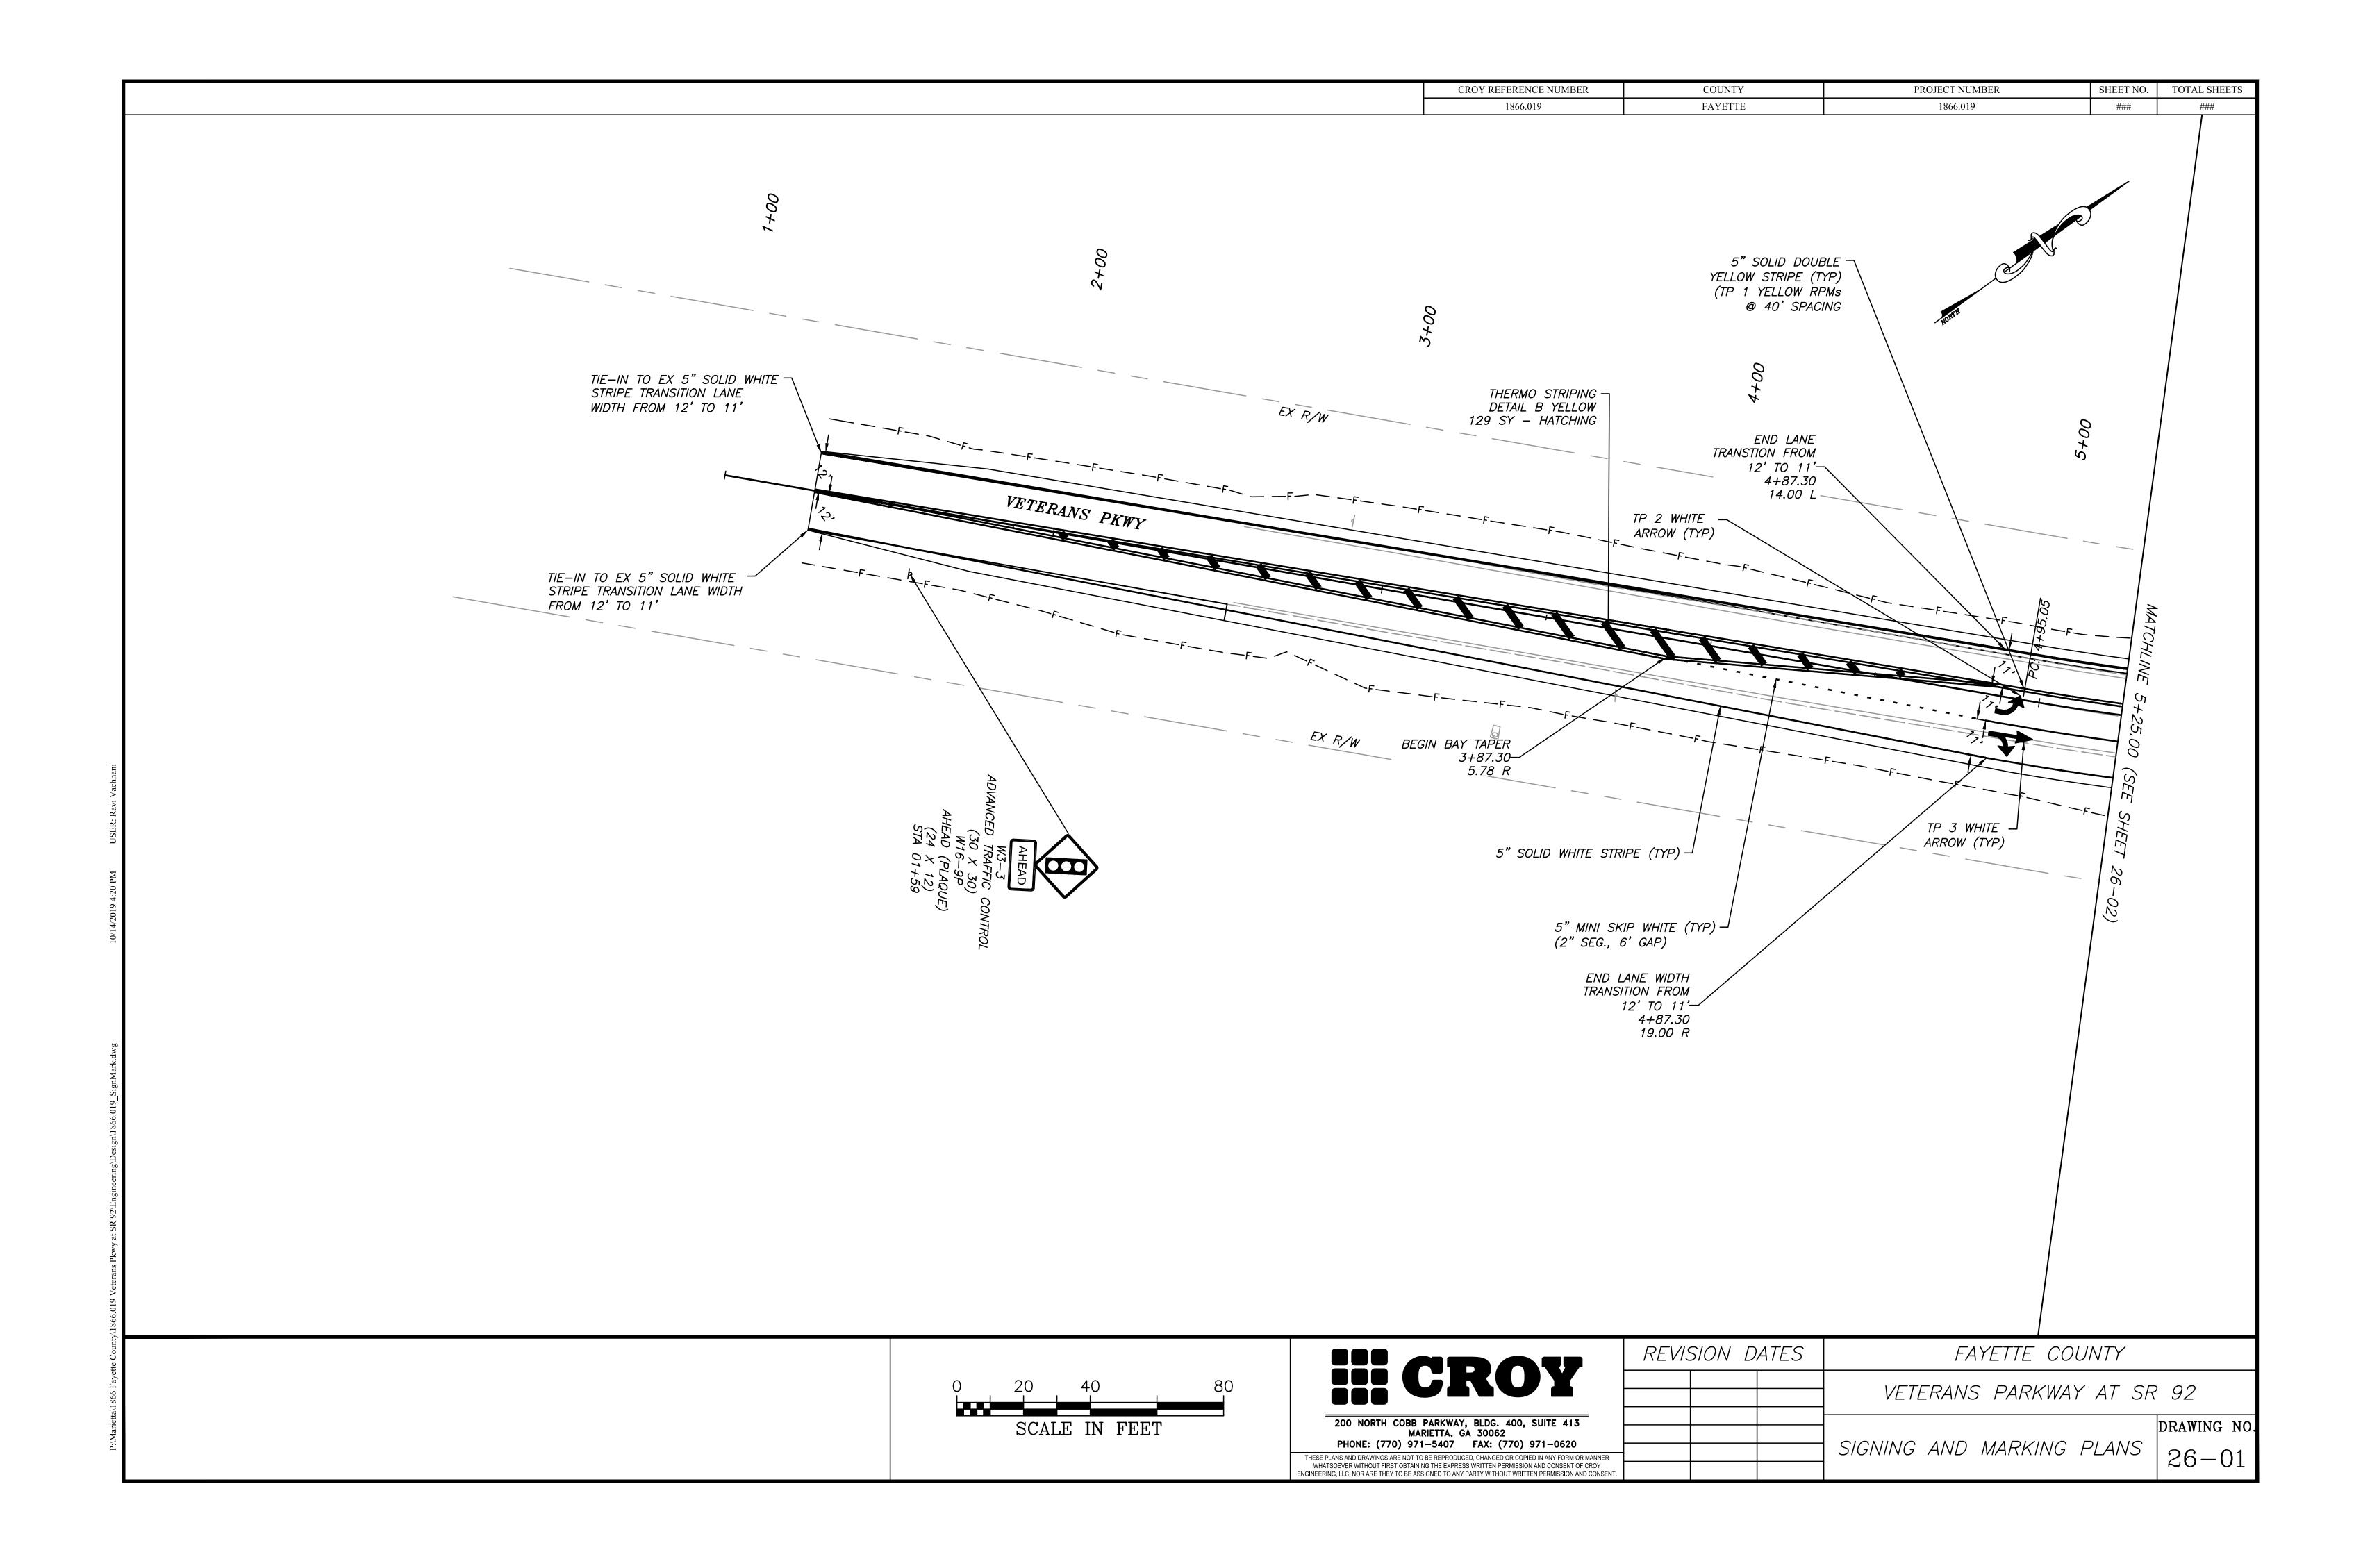

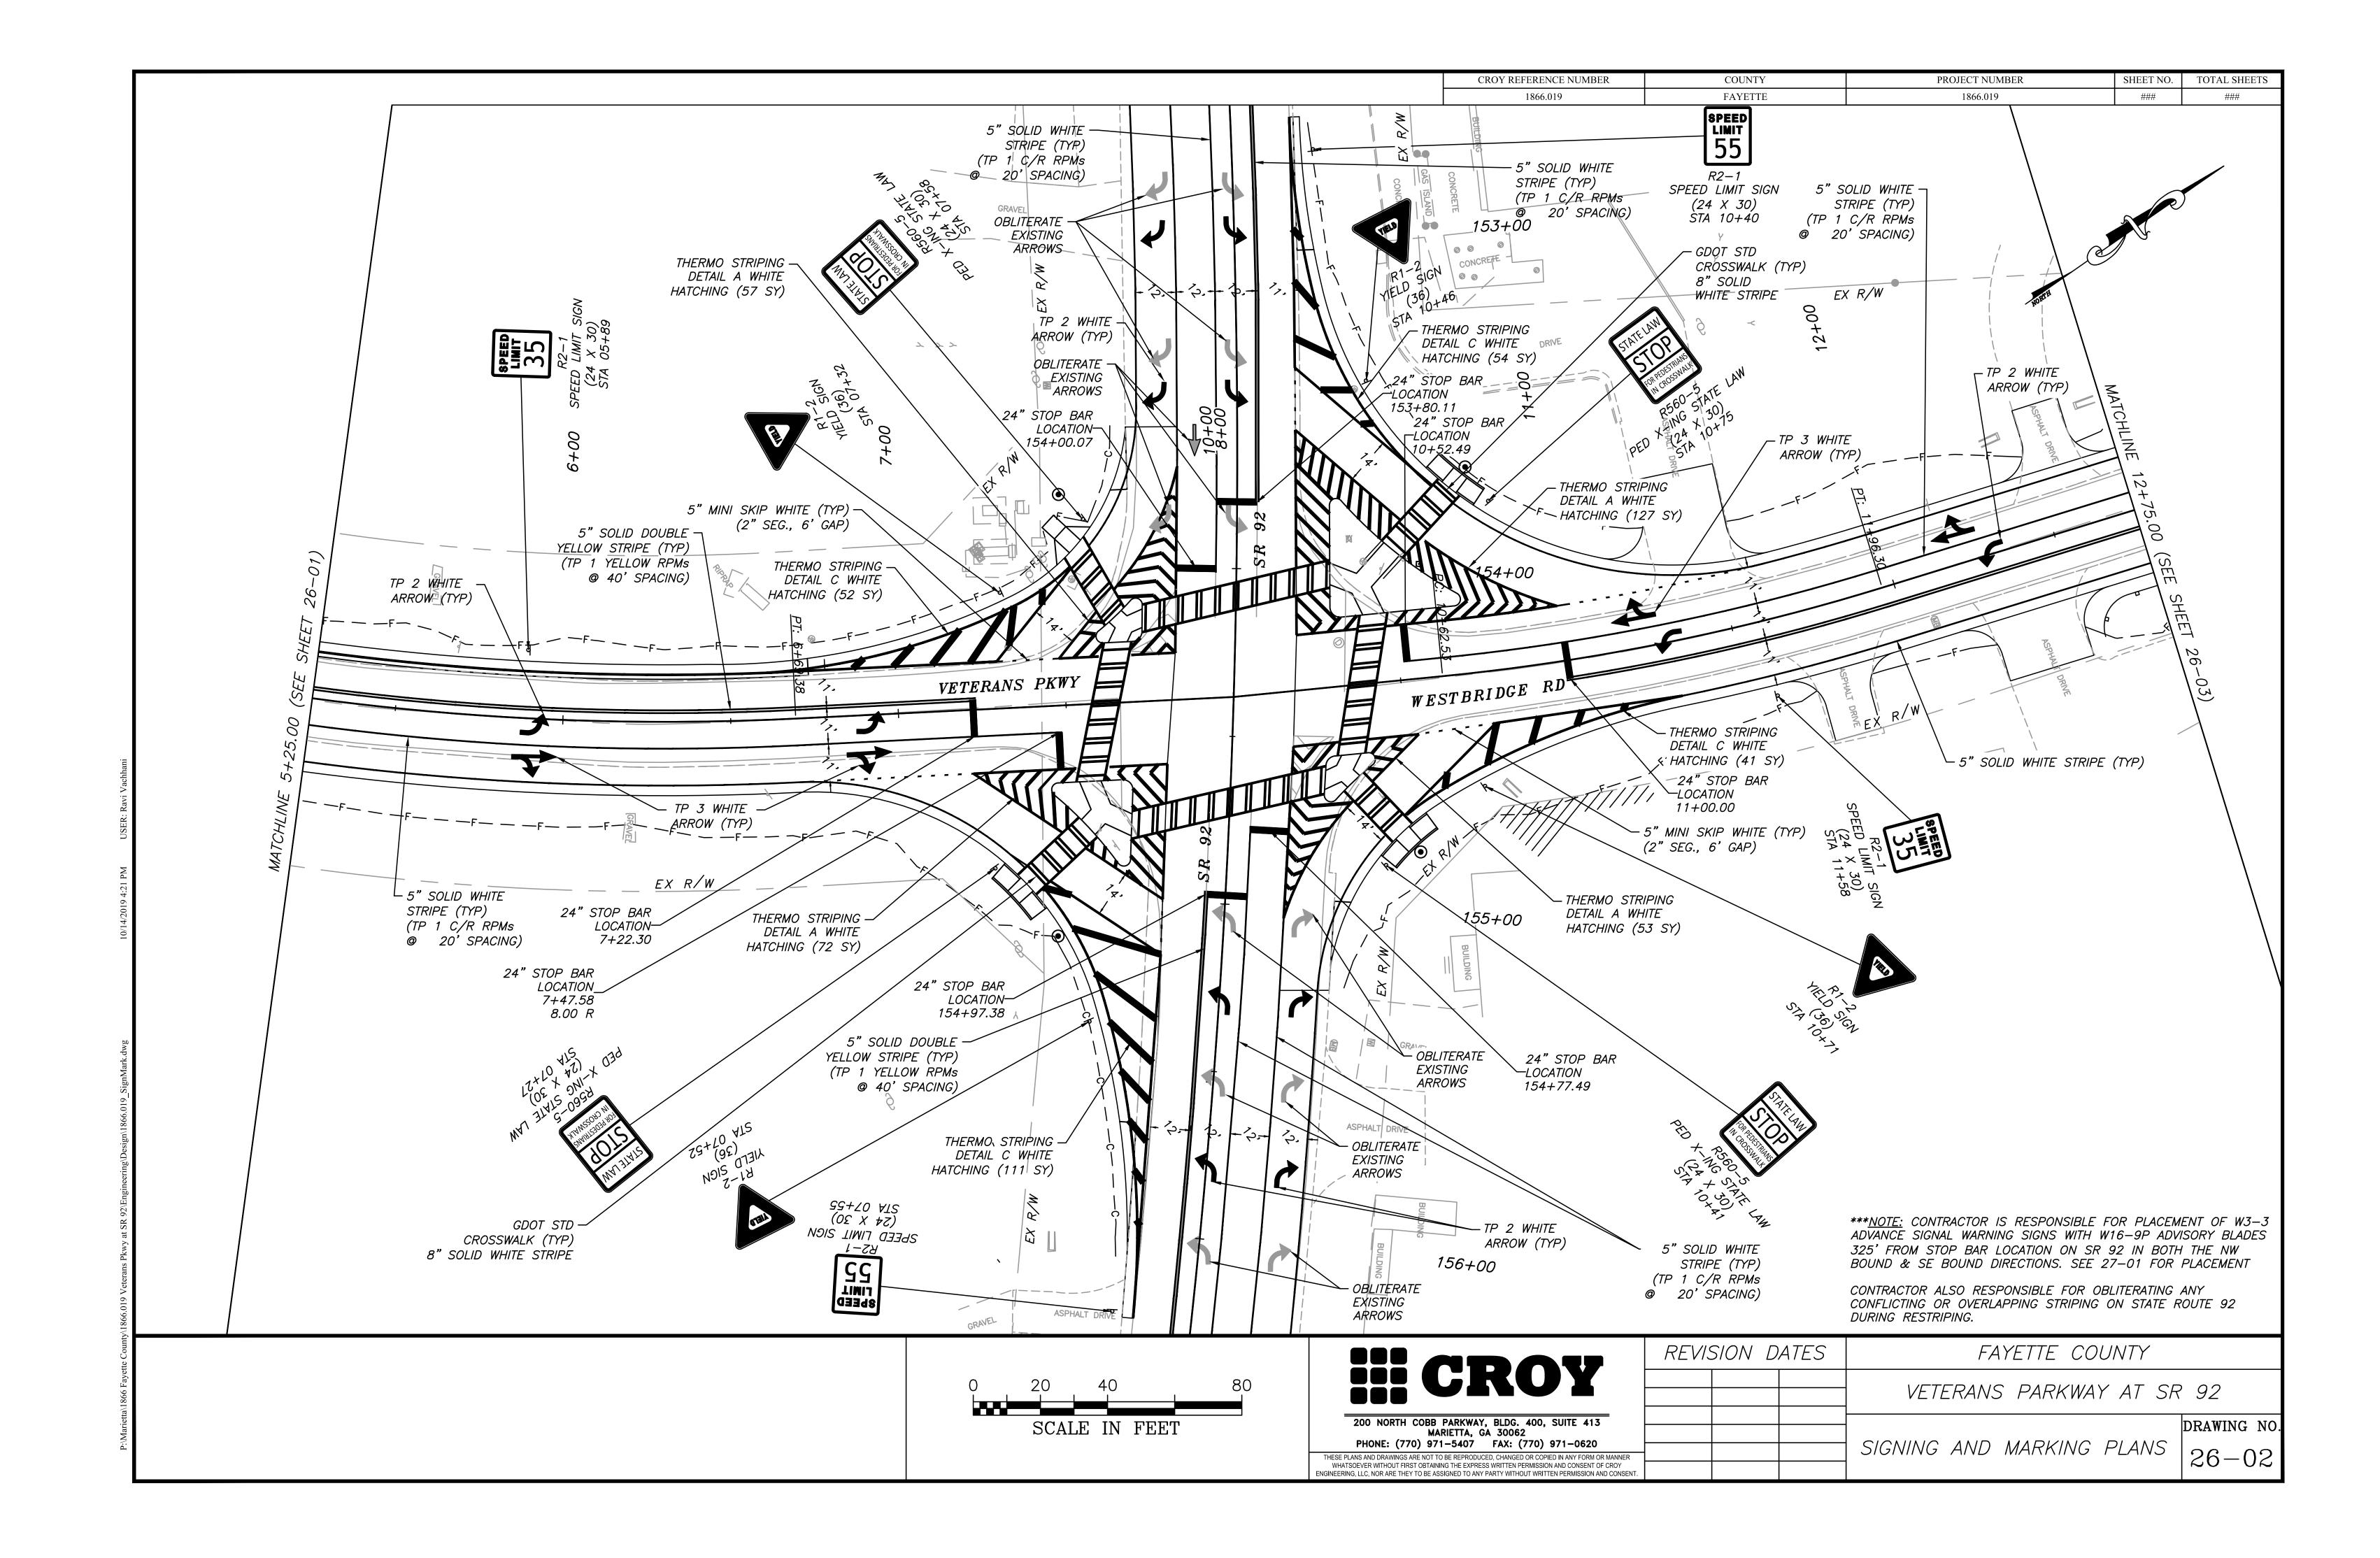

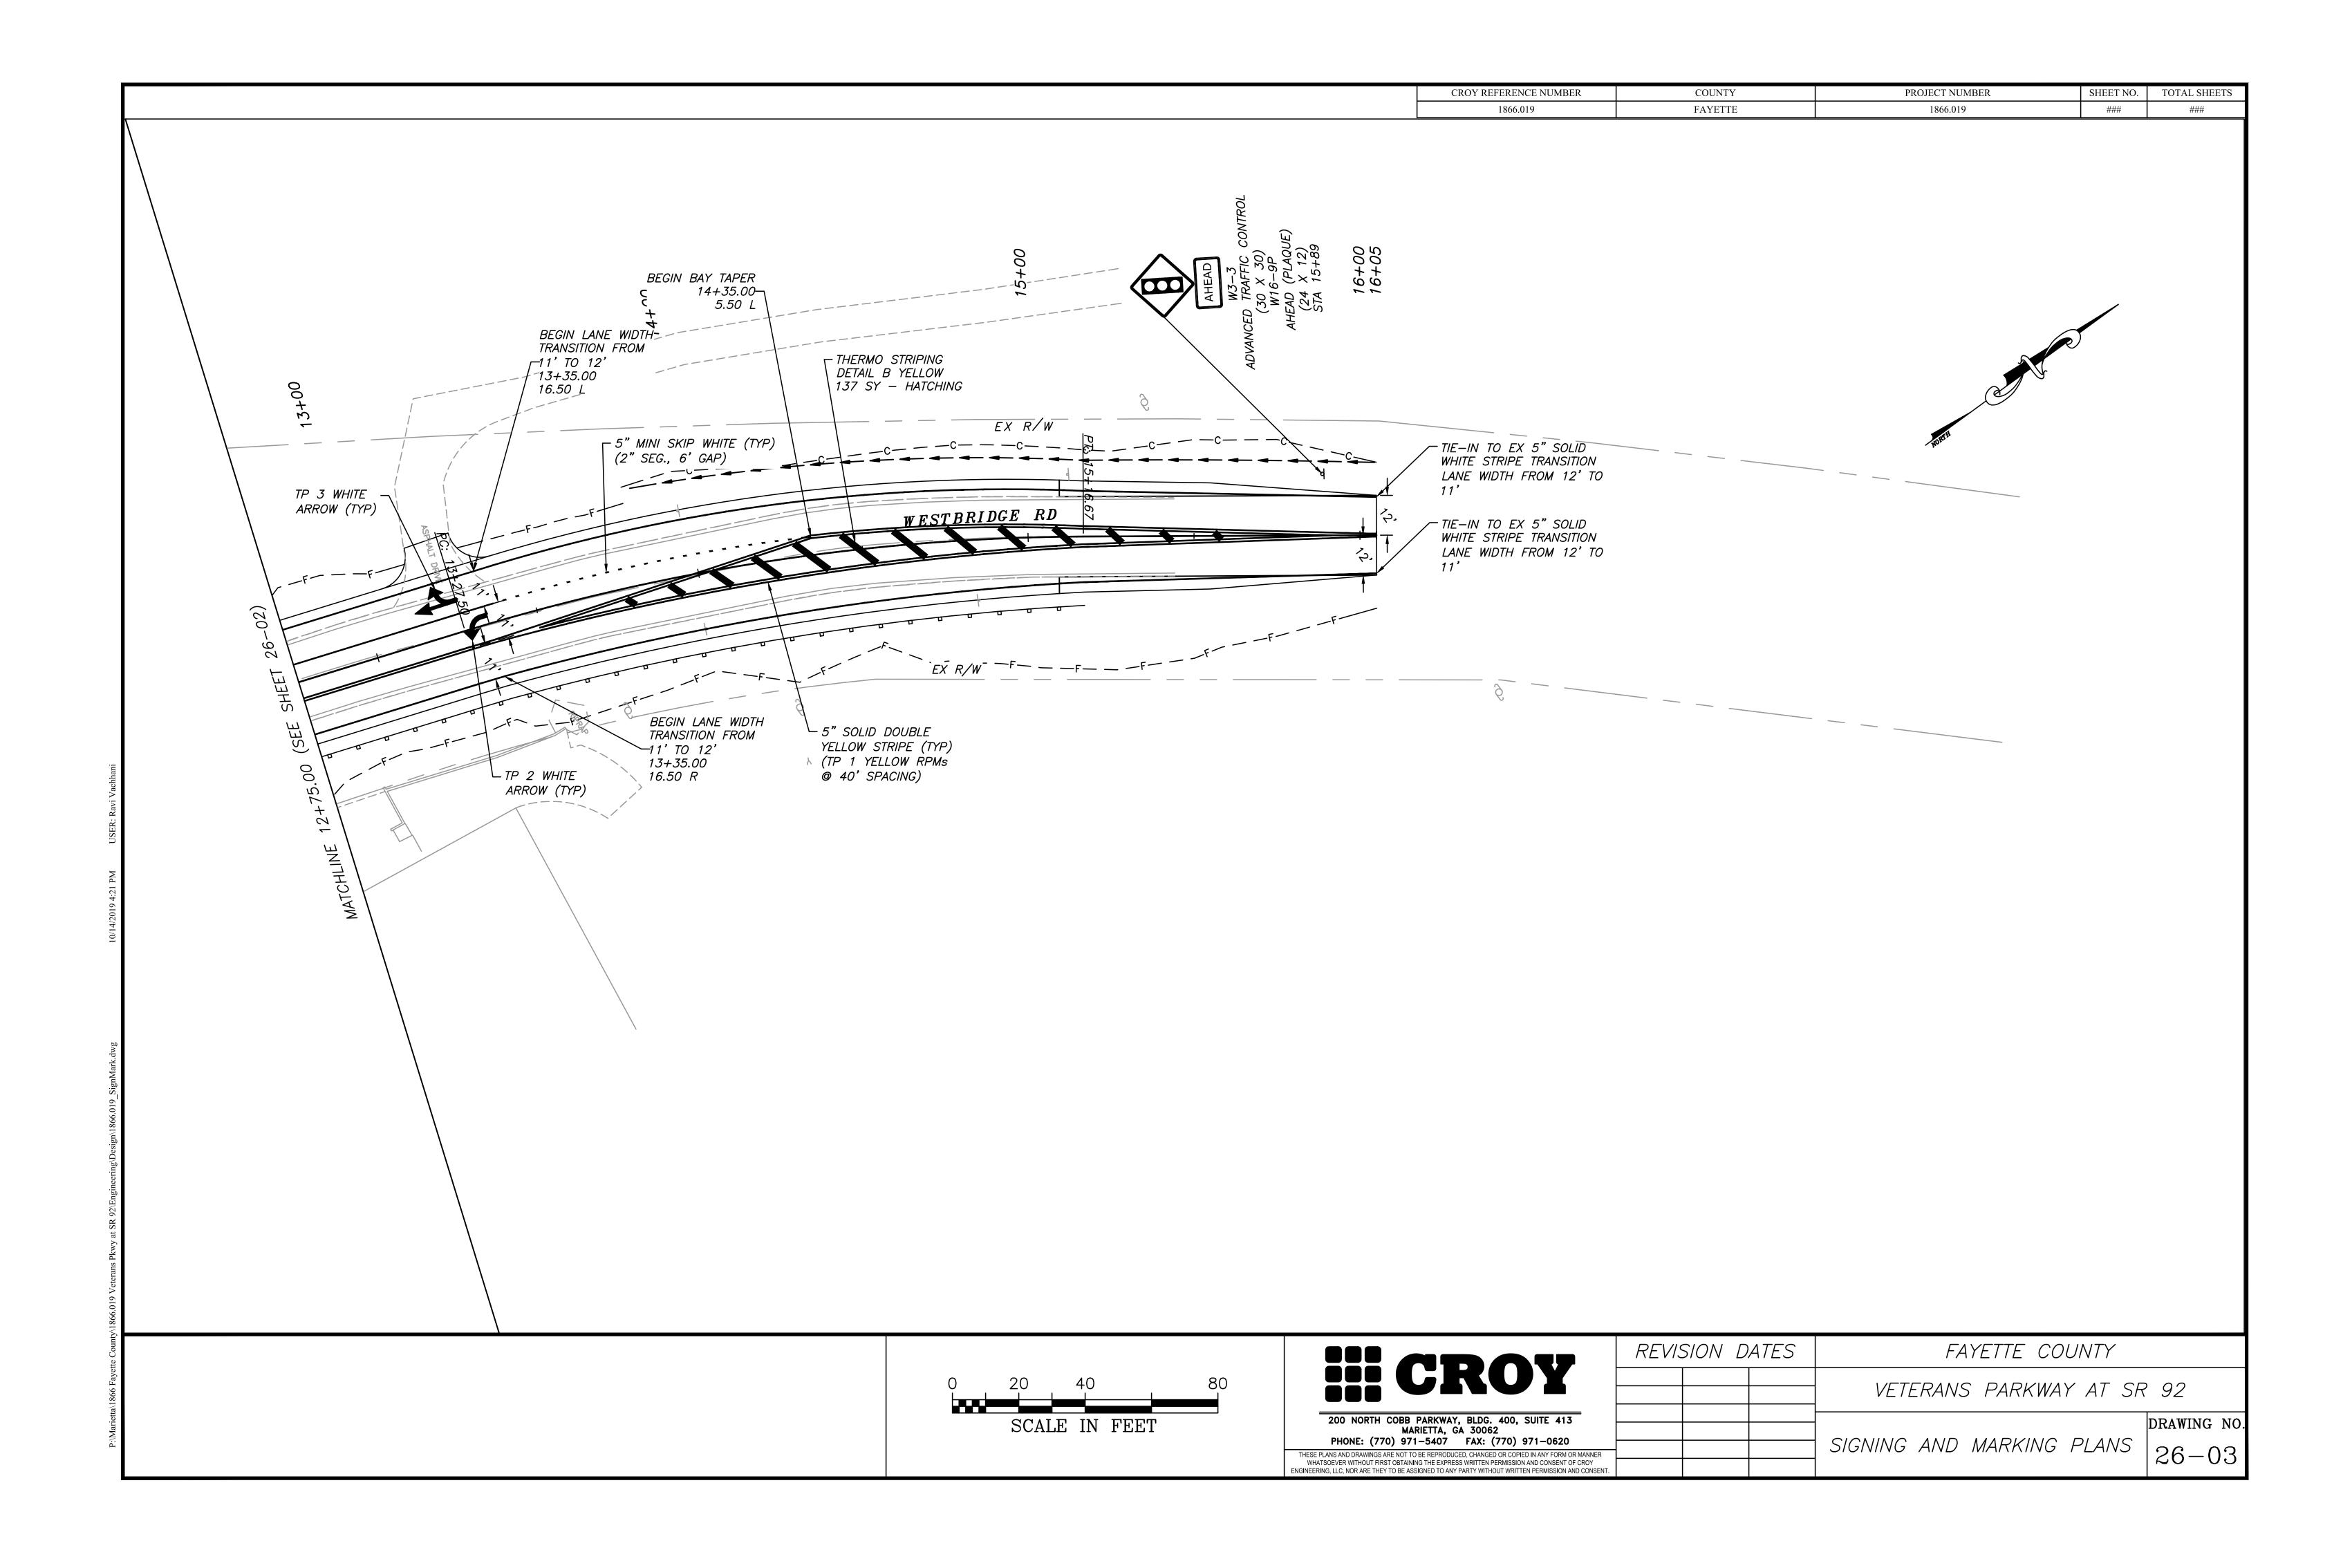

CROY REFERENCE NUMBER COUNTY PROJECT NUMBER SHEET NO. TOTAL SHEETS

1866.019 FAYETTE 1866.019 ### ###

### TRAFFIC SIGNAL GENERAL NOTES:

- 1. THE COMPLETE SIGNAL INSTALLATION, MODIFICATION AND/OR REBUILD SHALL CONFORM TO ALL APPROPRIATE PARTS OF THE MANUAL ON UNIFORM TRAFFIC CONTROL DEVICES CURRENT EDITION INCLUDING SUBSEQUENT PUBLISHED RULINGS.
- 2. MATERIAL CERTIFICATION IS REQUIRED PRIOR TO BEGINNING ANY SIGNAL INSTALLATION WORK. THE CONTRACTOR SHALL FOLLOW PROCEDURES OUTLINED IN THE CURRENT GDOT SPECIFICATIONS AND/OR SPECIAL PROVISIONS.
- 3. ALL INSTALLATION MATERIALS AND METHODS SHALL COMPLY WITH THE CURRENT GEORGIA DEPARTMENT OF TRANSPORTATION STANDARDS AND SPECIFICATIONS AND SPECIAL PROVISIONS.
- 4. THE CONTRACTOR SHALL MAINTAIN EXISTING COMMUNICATIONS DURING CONSTRUCTION. THE CONTRACTOR SHALL BE RESPONSIBLE FOR ALL COMMUNICATION ADJUSTMENTS, INCLUDING TEMPORARY SUPPORT POLE LOCATION(S) REQUIRED BY THE PROJECT DURING THE INTERIM PERIOD THROUGH INSTALLATION OF NEW SIGNAL EQUIPMENT. AT NO TIME SHALL THE CONTRACTOR CAUSE ANY PART OF THE COMMUNICATIONS TO BE INOPERABLE. ANY NECESSARY INTERRUPTION IN COMMUNICATION OR OPERATION DUE TO CONSTRUCTION MUST BE APPROVED BY GDOT TRAFFIC ENGINEER OR HIS/HER DESIGNEE.
- 5. THE CONTRACTOR SHALL LOCATE UNDERGROUND UTILITIES IN THE VICINTY OF NEW TRAFFIC SIGNAL POLES, CONDUIT, AND PULL BOXES BEFORE INSTALLATION. MINOR SHIFTS (UP TO A MAXIMUM OF FIVE (5) FEET) IN THE LOCATION OF NEW SIGNAL POLES, CONDUIT, AND PULL BOXES, SHALL BE AT THE DISCRETIONOF THE GDOT TRAFFIC ENGINEER.
- 6. PROVIDE A MINIMUM OF 10' CLEARANCE BETWEEN POWER LINES AND CONCRETE STRAIN POLES. RAISE POWER LINES IF NECESSARY.
- 7. POLE FOUNDATIONS SHALL CONFORM TO GDOT STANDARD CAISSON DETAILS FOR SITE SOIL STRENGTH. FOUNDATIONS SHALL BE ENLARGED AS NECESSARY TO COMPENSATE FOR INFERIOR OR FILL SOIL.
- 8. SIGNAL HEADS SHALL BE ERECTED TO PROVIDE AT LEAST 17 TO 19 FEET CLEARANCE FROM BOTTOM OF SIGNAL HEADS TO TOP OF ROAD SURFACE AND A MINIMUM OF 8 FEET MEASURED HORIZONTALLY BETWEEN CENTERS OF SIGNAL HEADS.
- 9. WHERE SIGNAL AND PEDESTRIAN HEADS ARE INDICATED TO BE INSTALLED OR REPLACED THIS SHALL INCLUDE ANY AND ALL HARDWARE TO COMPLETE THE INSTALLATION.
- 10. THE CONTRACTOR SHALL BE RESPONSIBLE FOR ALL NEW GUYS ON EXISTING UTILITY TIMBER POLES WHEN ATTACHING SPAN WIRE OR INTERCONNECT CABLE TO THE POLES UNLESS OTHERWISE DIRECTED BY THE ENGINEER.
- 11. THE GDOT DISTRICT SIGNAL SUPERVISOR (770-387-3632) MUST BE CONTACTED THREE (3) DAYS IN ADVANCE OF SETTING THE CONCRETE STRAIN POLES TO VERIFY LOCATION AND CONDUIT PLACEMENT.
- 12. INSTALLATION IS TO BE CHECKED AND ACCEPTED BY THE GDOT TRAFFIC ENGINEER OR HIS/HER DESIGNEE PRIOR TO FINAL ACCEPTANCE.
- 13. THE CONTRACTOR SHALL BE RESPONSIBLE FOR ALL MAINTENANCE AND MAINTAIN CONTROL OF THE SIGNAL UNTIL FINAL ACCEPTANCE OF THE SIGNAL BY GEORGIA DEPARTMENT OF TRANSPORTATION.
- 14. ALL TRAFFIC SIGNAL EQUIPMENT SHOULD BE ON THE GDOT APPROVED QUALIFIED PRODUCTS LIST (QPL).
- 15. TRAFFIC SIGNAL HEADS ARE REQUIRED WITH L.E.D. (ITE STANDARD) MODULES.


- 16. PEDESTRIAN SIGNAL HEADS SHALL BE L.E.D. (ITE STANDARD) PEDESTRIAN AND COUNTDOWN (16" X 18" TYPE W/OVERLAPPING FULLY POPULATED HAND AND MAN + COUNTDOWN) AND SHALL BE INSTALLED FOR ALL PEDESTRIAN SIGNAL HEADS.
- 17. GROUNDING SHALL BE 5 OHMS OR LESS.
- 18. CONNECT POWER SERVICE TO CABINET WITH 1 INCH RIGID CONDUIT AND RISER.
- 19. MATERIALS LISTED FOR SIGNAL INSTALLATION ARE FOR INFORMATIONAL PURPOSES ONLY. THE CONTRACTOR SHALL DETERMINE THE MATERIALS AND QUANTITIES REQUIRED FOR THE COMPLETE AND ACCEPTED INSTALLATION.
- 20. THE SIGNAL CONTRACTOR IS RESPONSIBLE FOR RELOCATIONS OF ANY FIBER OPTIC CABLES ASSOCIATED WITH THIS PROJECT, INCLUDING POWER SERVICE TO SIGNAL EQUIPMENT.
- 21. THE CONTRACTOR SHALL FIELD VERIFY ALL EXISTING UTILITY CONDITIONS PRIOR TO ANY CONSTRUCTION. DAMAGE TO EXISTING UTILITY LINES RESULTING FROM THE CONTRACTOR NEGLIGENCE SHALL BE REPAIRED AT THE CONTRACTORS EXPENSE.
- 22. THE CONTRACTOR SHALL ADHERE TO THE CALL BEFORE YOU DIG LAW BY CALLING THE UNDERGROUND PROTECTION CENTER AT GEORGIA811 BEFORE BEGINNING CONSTRUCTION.
- 23. THE CONTRACTOR SHALL COORDINATE WITH UTILITY COMPANIES TO PROVIDE APPROPRIATE CLEARANCES FROM UTILITIES.

## PROPOSED SIGNAL

		<b>\ / \</b> \ <b>L</b>	
$\searrow$	CONTROLLER CABINET		PULLBOX, TP 2
•	STRAIN POLE		PULLBOX, TP 3
•	TIMBER POLE		PULLBOX, TP 4
$\prec$	DOWN GUY		6x6 PULSE LOOP
	LUMINAIRE		6X40 PRESENSE DETECTION LOOP
<b>+</b>	3 SECTION HEAD W/ BACKPLATE -		CONDUIT
<b>+</b>	3 OR 4 SECTION FYA W/ BACKPLATE		AERIAL SPAN
0	PEDESTAL POLE	丁	SIGN POST
	PED SIGNAL HEAD		UNDERGROUND FIBER OPTIC CABLE
	CURB CUT RAMP — (See ADA Detail)		

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MARIETTA, GA 30062
PHONE: (770) 971-5407 FAX: (770) 971-0620

	INTY	ETTE COU	FAY		ATES	SION D	REVIS
R 92	AT SR	PARKWAY	TERANS	VE			
DRAWING 1							
S 27-0	NOTES	GENERAL	SIGNAL	TRAFFIC			

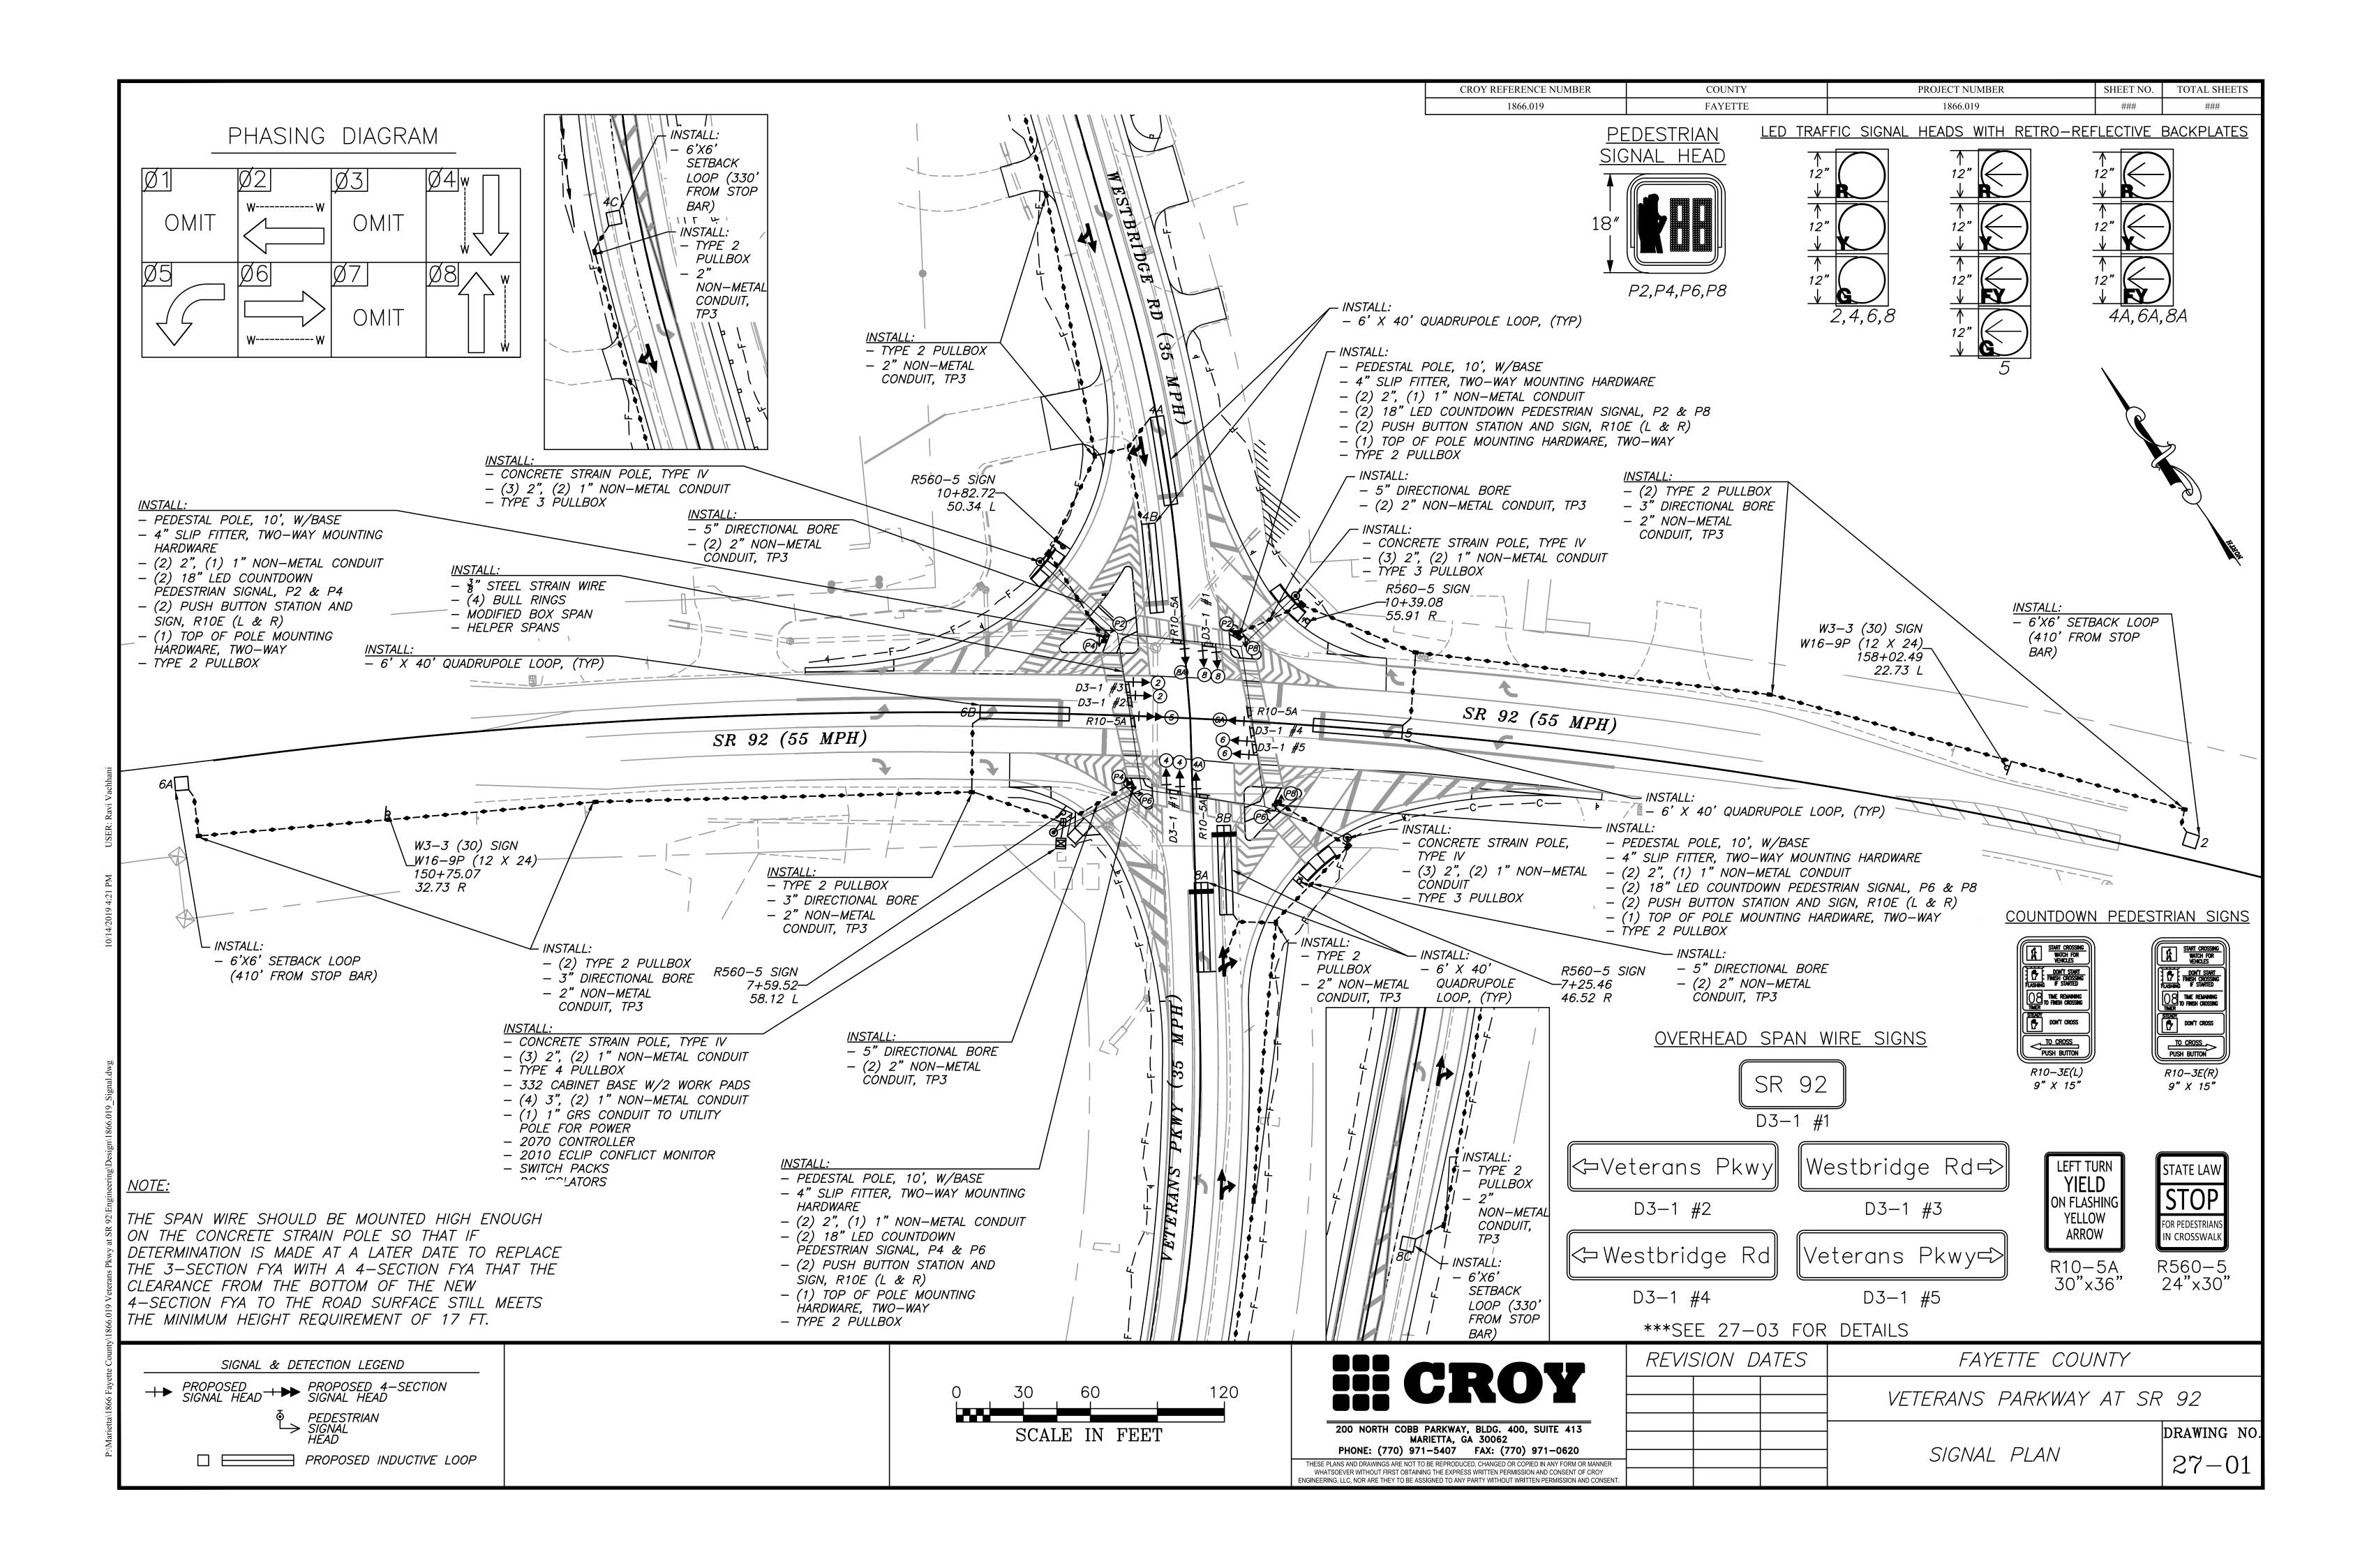

TRAFFIC SIGNAL INSTALLATION NO.1	T	
MATERIALS	UNIT	QUANTITY
NON-NEMA CABINET, CONTROLLER ASSEMBLIES		
A. CABINET ASSEMBLY, MODEL 332A W AUXILLIARY OUTPUT FILE	EACH	1
B. SWITCH PACK	EACH	12
C. DC ISOLATOR	EACH	3
D. 2010 ECLIP CONFLICT MONITOR. EXTENDED FEATURES	EACH	1
E. 2070 CONTROLLER W/ CURRENT GDOT OPERATING SOFTWARE	EACH	1
F. 2-CHANNEL LOOP DETECTOR	EACH	5
G. 332 CABINET BASE***	EACH	1
H. 332 CABINET WORKPADS***	EACH	2
LOOP / PED DETECTOR LEAD-IN WIRE		
A. 3 PAIR,18 AWG***	LIN FT	<del>3500</del>
SIGNAL CABLE		
B. 7-CONDUCTOR, (14 AWG)***	LIN FT	<del>2700</del>
ONE-WAY, 3-SECTION, 12" , LED, TRAFFIC SIGNAL HEAD. PLASTIC***	EACH	11
ONE-WAY, 4-SECTION, 12" , LED, TRAFFIC SIGNAL HEAD. PLASTIC***	EACH	1
BACK PLATE FOR ONE-WAY, 3-SECTION, 12" SIGNAL HEAD-2" RETROREFLECTIVE TP***	EACH	11
BACK PLATE FOR ONE-WAY, 4-SECTION, 12" SIGNAL HEAD-2" RETROREFLECTIVE TP***	EACH	1
ONE-WAY I-SECTION, 18" LED COUNTDOWN PEDESTRIAN SIGNAL HEAD, FULL HAND/MAN PVERLAP, 9" HIGH NUMBERS & 12" SYMBOLS***	EACH	8
PEDESTRIAN PUSH BUTTON STATION ASSEMBLY		
A. 9"X15", W/ DOUBLE PUSH BUTTON STATION ADAPTER FOR 4" DIA PEDESTRIAN POLE,		
ADJUSTABLE W/ ADAPTERS TO EXTEND FOR 9"X15" SIGNS***	EACH	4
PEDESTRIAN SIGN		
A. 9"X15", RIO-3E, (L)EFT OR (R)IGHT, STANDARD***	EACH	8
PEDESTAL POLE, 10 FT, BASE AND FOOTING***	EACH	4
HARDWARE FOR SPAN WIRE MOUNTING (3 OR 4 SECTION SIGNAL HEADS AND SIGNS)***	EACH	<del>22</del>
HARDWARE FOR POST TOP ERECTION FOR 18" PEDESTRIAN SIGNAL HEADS, TWO-WAY MOUNTING***	EACH	4
PULLBOX, TYPE 2, POLYMER CONCRETE***	EACH	<del>12</del>
PULLBOX, TYPE 3, POLYMER CONCRETE***	EACH	3
CONDUIT NON-METAL, 1"***	LIN FT	<del>150</del>
CONDUIT NON-METAL, 2"***	LIN FT	<del>200</del>
CONDUIT NON-METAL, 3"	LIN FT	60
OVERHEAD SPAN WIRE SIGNS		
A. D3-1 #1 (SR92)	EACH	2
B. D3-1 #2 ((ARROW) VETERANS PKWY)	EACH	1
C. D3-1 #3 (WESTBRIDGE RD (ARROW))	EACH	1
D. D3-1 #4 ((ARROW) WESTBRIDGE RD)	EACH	
E. D3-1 #5 (VETERANS PKWY (ARROW))	EACH	
F. RIO-5A (LEFT TURN YIELD ON FLASHING YELLOW ARROW SIGN)***		
1. INO-OA (LLI I TOINN TILLD ON LASTIING TELLOW ARROW SIGN)	EACH	<u> </u>

MATERIALS LISTED FOR SIGNAL INSTALLATION ARE FOR INFORMATIONAL PURPOSES ONLY. <u>ALL ITEMS WITH ASTERISKS NEXT TO THE DESCRIPTION AND STRIKED OUT QUANTITIES ARE TO BE PROVIDED BY THE COUNTY AND SHOULD NOT BE INCLUDED IN THE BID FOR SIGNAL INSTALLATION.</u> THE CONTRACTOR SHALL DETERMINE THE MATERIALS AND QUANTITIES REQUIRED FOR THE COMPLETE AND ACCEPTED INSTALLATION.

CROY REFERENCE NUMBER	COUNTY	PROJECT NUMBER	SHEET NO.	TOTAL SHEETS
1866.019	FAYETTE	1866.019	###	###

### 332 CABINET INPUT ASSIGNMENT

SLOT | 1 | 2 | 3 | 4 | 5 | 6 | 7 | 8 | 9 | 10 | 11 | 12 | 13 |

### UPPER INPUT FILE

	TYPE	DET	DET	DET	DET	DET	DET	DET	DET	DET	TBA	TBA	DC	DC	DC
	CARD		2-CH				2-CH							DC ISO	DC ISO
	C1 PIN	56	39	63	47	58	41	65	49	60		80	67	68	81
CHANNEL 1	FUNCTION		2A				4A						02 PED	06 PED	FLASH
	FIELD TERM	TB2 1,2	TB2 5,6	TB2 9,10	TB4 1,2	TB4 5,6	TB4 9,10	TB6 1,2	TB6 5,6	TB6 9,10			TB8 4,6	TB8 7,9	N/C

	C1 PIN	56	43	76	47	58	45	78	49	62	53	69	70	82
CHANNEL 2	FUNCTION						4B					04 PED	08 PED	STOP TIME
	FIELD TERM	TB2 3,4	TB2 7,8	TB2 11,12	TB4 3,4	TB4 7.8	TB4 11.12	TB6 3.4	TB6 7.8	TB6 11,12		TB8 5,6	TB8 8.9	N/C

### LOWER INPUT FILE

	TYPE	DET	DET	DET	DET	DET	DET	DET	DET	DET	TBA	TBA	DC	DC	DC
	CARD	2-CH	2-CH				2-CH								
	C1 PIN	55	40	64	48	57	42	66	50	59		54	71	72	51
CHANNEL 1	FUNCTION	R5	L6A				R8								
	FIELD TERM	TB3 1,2	TB3 5,6	TB3 9,10	TB5 1,2	TB5 5,6	TB5 9,10	TB7 1,2	TB7 5,6	TB7 9,10			TB9 4,6	TB9 7,9	TB9 10,12

	C1 PIN	55	44	77	48	57	46	79	50	61	75	73	74	52
CHANNEL 2	FUNCTION		6B				8B							
	FIELD TERM	TB3 3,4	TB3 7,8	TB3 11,12	TB5 3,4	TB5 7,8	TB5 11,12	TB7 3,4	TB7 7,8	TB7 11,12		TB9 5,6	TB9 8,9	TB9 11,12

	PAY ITEM		
ITEM NO.	DESCRIPTION	UNITS	QUANTITY
639-2002	STEEL WIRE STRAND CABLE, $\frac{3}{8}$ IN***	LIN FT	500
639-5000	PRESTRESSED CONC STRAIN POLE. TP IV, 50'***	EACH	4
647-1000	TRAFFIC SIGNAL INSTALLATION NO.1	LUMP	1
647-2141	PULLBOX, PB-4S	EACH	1
647-6200	LOOP DETECTOR, 6 FT X 6 FT, BIPOLE***	EACH	4
647-6300	LOOP DETECTOR, 6 FT X 50 FT, QUADRUPOLE***	EACH	6
682-6233	CONDUIT, NON-METAL, TP3, 2 IN	LIN FT	1250
682-9950	DIRECTIONAL BORE, DESC: 3 IN	LIN FT	800
682-9950	DIRECTIONAL BORE, DESC: 5 IN	LIN FT	160


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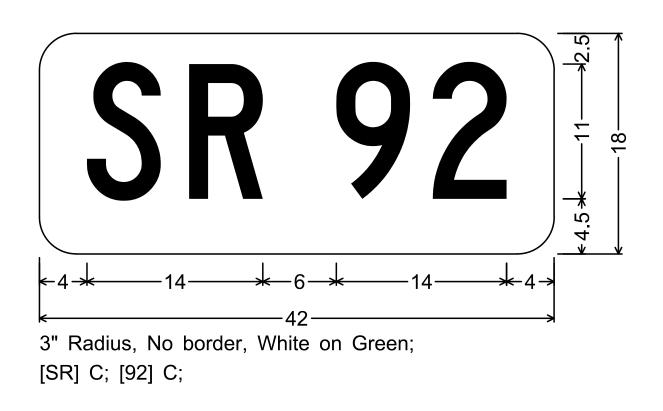
MATERIALS LISTED FOR SIGNAL INSTALLATION ARE FOR INFORMATIONAL PURPOSES ONLY. ALL ITEMS WITH ASTERISKS NEXT TO THE DESCRIPTION AND STRIKED OUT QUANTITIES ARE TO BE PROVIDED BY THE COUNTY AND SHOULD NOT BE INCLUDED IN THE BID FOR SIGNAL INSTALLATION. THE CONTRACTOR SHALL DETERMINE THE MATERIALS AND QUANTITIES REQUIRED FOR THE COMPLETE AND ACCEPTED INSTALLATION.

iii CROY
200 NORTH COBB PARKWAY, BLDG. 400, SUITE 413  MARIETTA, GA 30062  PHONE: (770) 971-5407 FAX: (770) 971-0620
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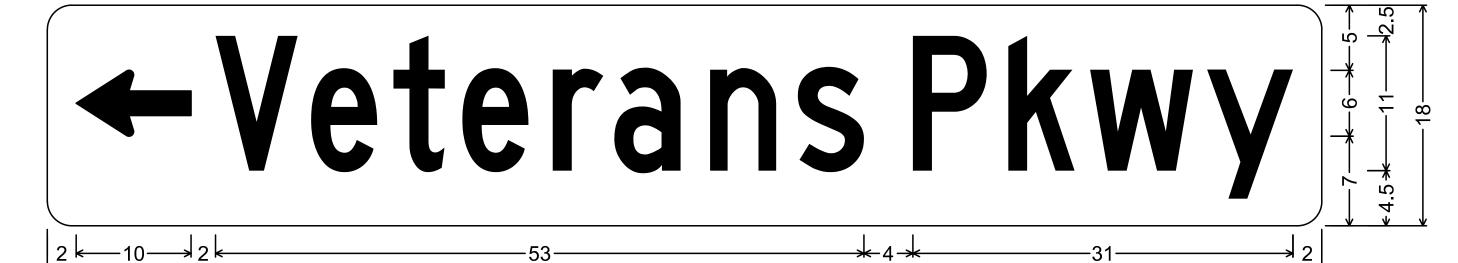
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REVISION DATES	FAYETTE COUNTY
	VETERANS PARKWAY AT SR 92
	SIGNAL OPERATIONS - DRAWING N
	$oxed{VETERANS~\&~WESTBRIDGE~@}{SR~92}$






D3-1 (2 REQ'D)

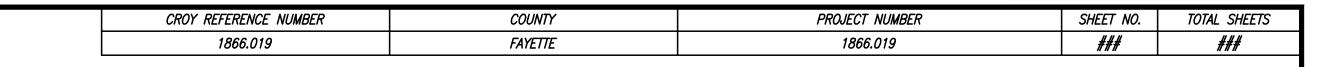

2" Radius, No border, White on Green:

Standard Arrow Custom 9" X 5" 180°; [Veterans] C 70% spacing; [Pkwy] C 70% spacing;

D3-2 (1 REQ'D)

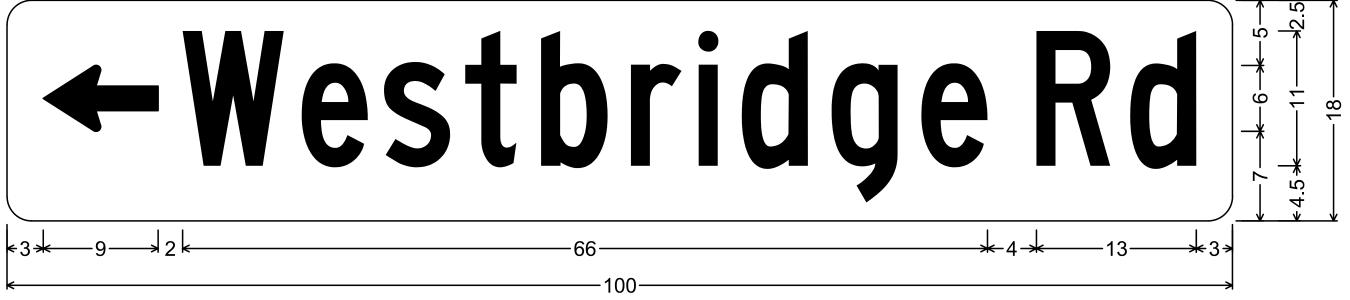

2" Radius, No border, White on Green; Standard Arrow Custom 9" X 5" 180°; [Westbridge] C 70% spacing; [Rd] C 70% spacing;

D3-4 (1 REQ'D)

## Westbridge Rd-

2" Radius, No border, White on Green;

[Westbridge] C 70% spacing; [Rd] C 70% spacing; Standard Arrow Custom 9" X 5" 0°;

D3-3 (1 REQ'D)

# Veterans Pkwy→

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2" Radius, No border, White on Green; [Veterans] C 70% spacing; [Pkwy] C 70% spacing; Standard Arrow Custom 9" X 5" 0°;

D3-5 (1 REQ'D)

200 NORTH COBB PARKWAY, BLDG. 400, SUITE 413
MARIETTA, GA 30062

200 NORTH COBB PARKWAY, BLDG. 400, SUITE 413

MARIETTA, GA 30062

PHONE: (770) 971–5407 FAX: (770) 971–0620

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REVISION DATES

VETERANS PARKWAY AT SR 92


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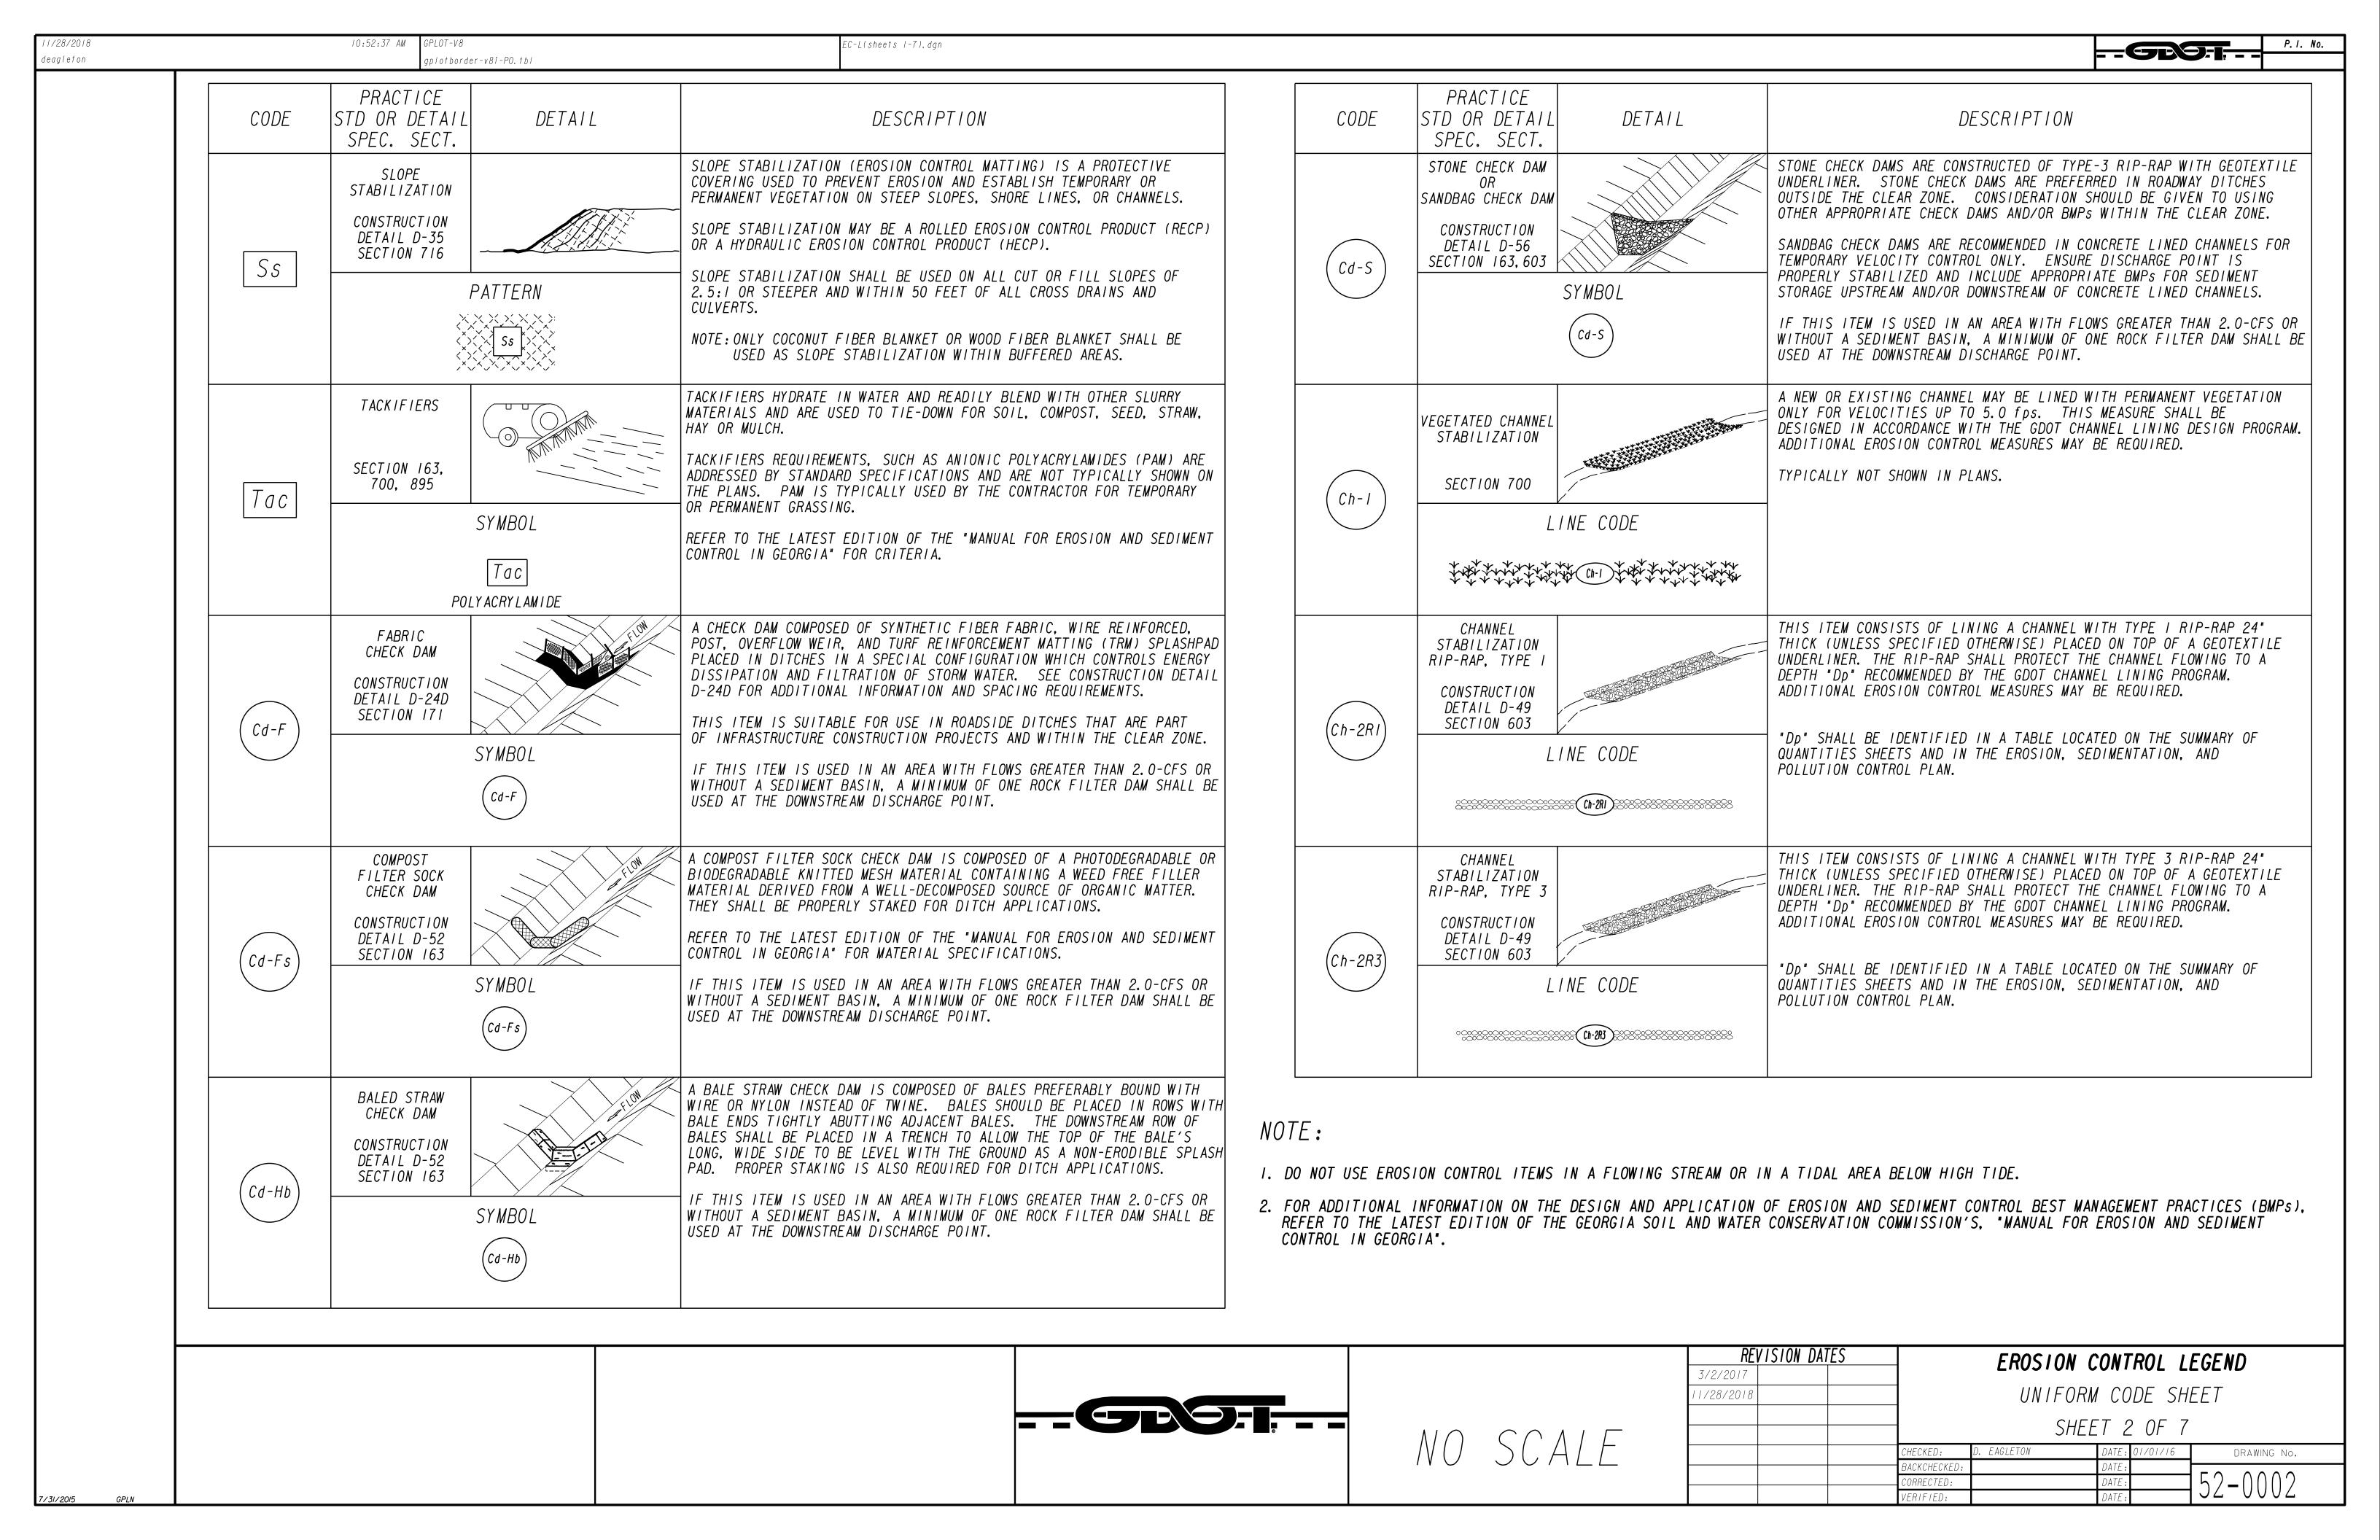
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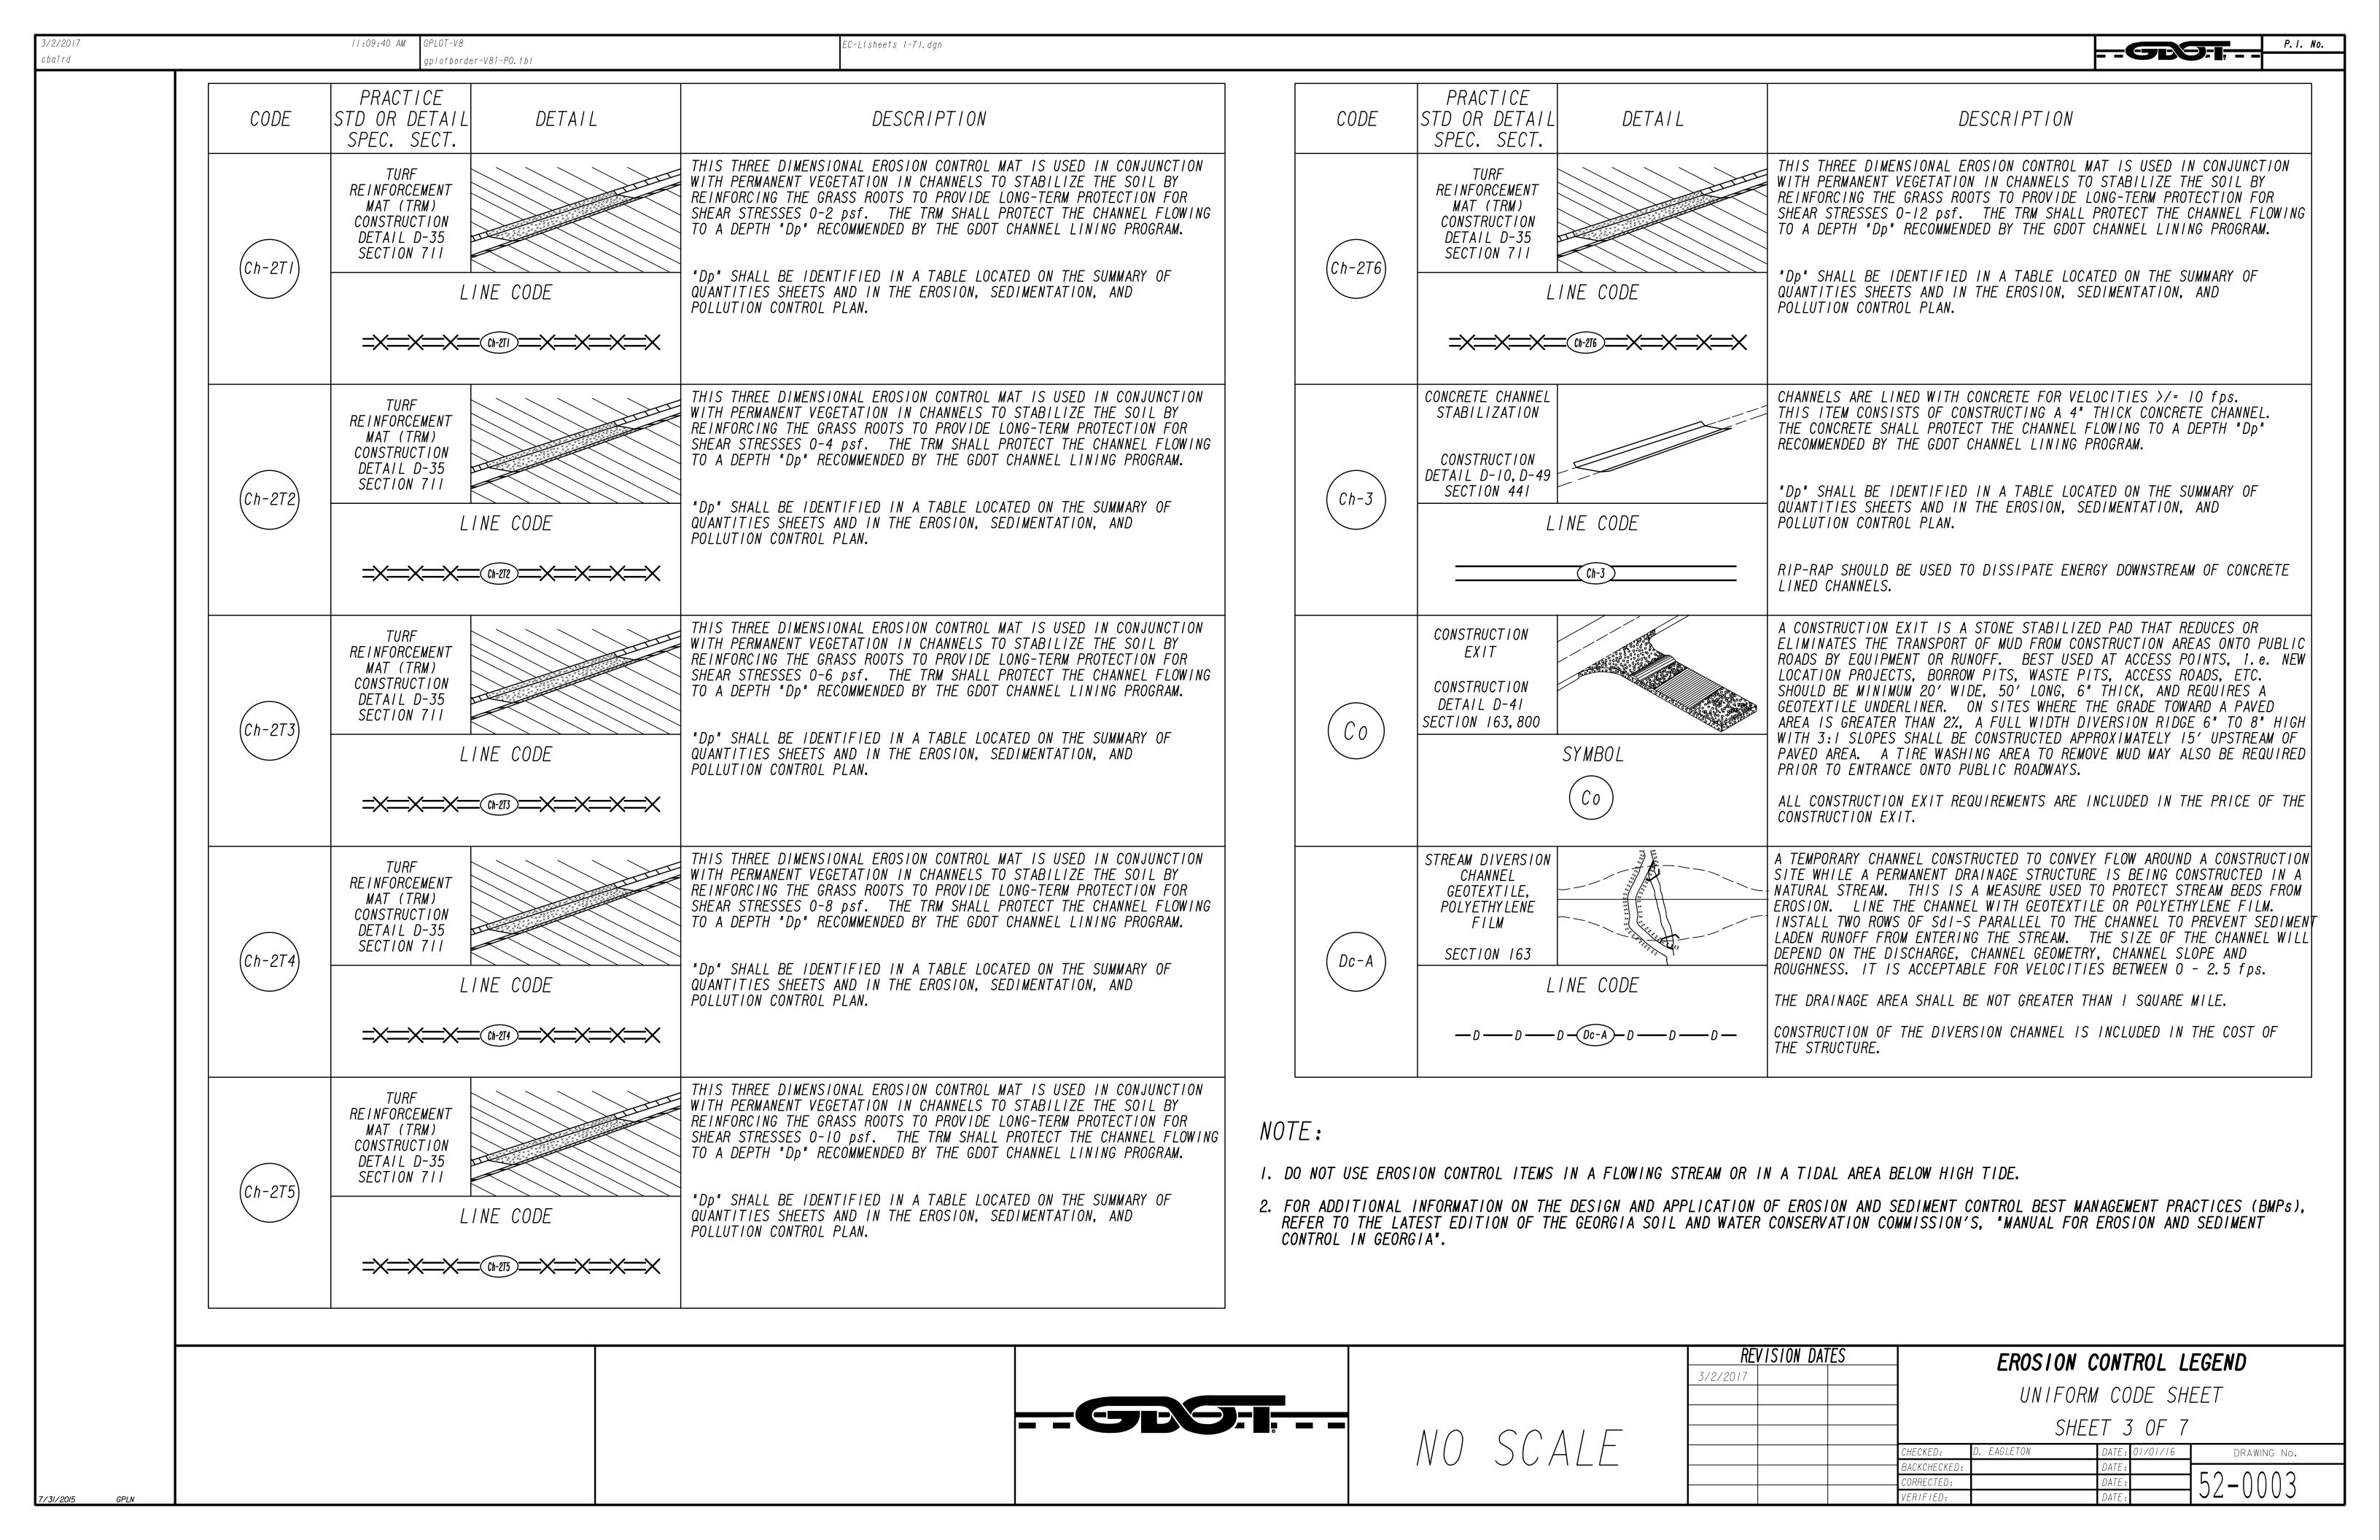
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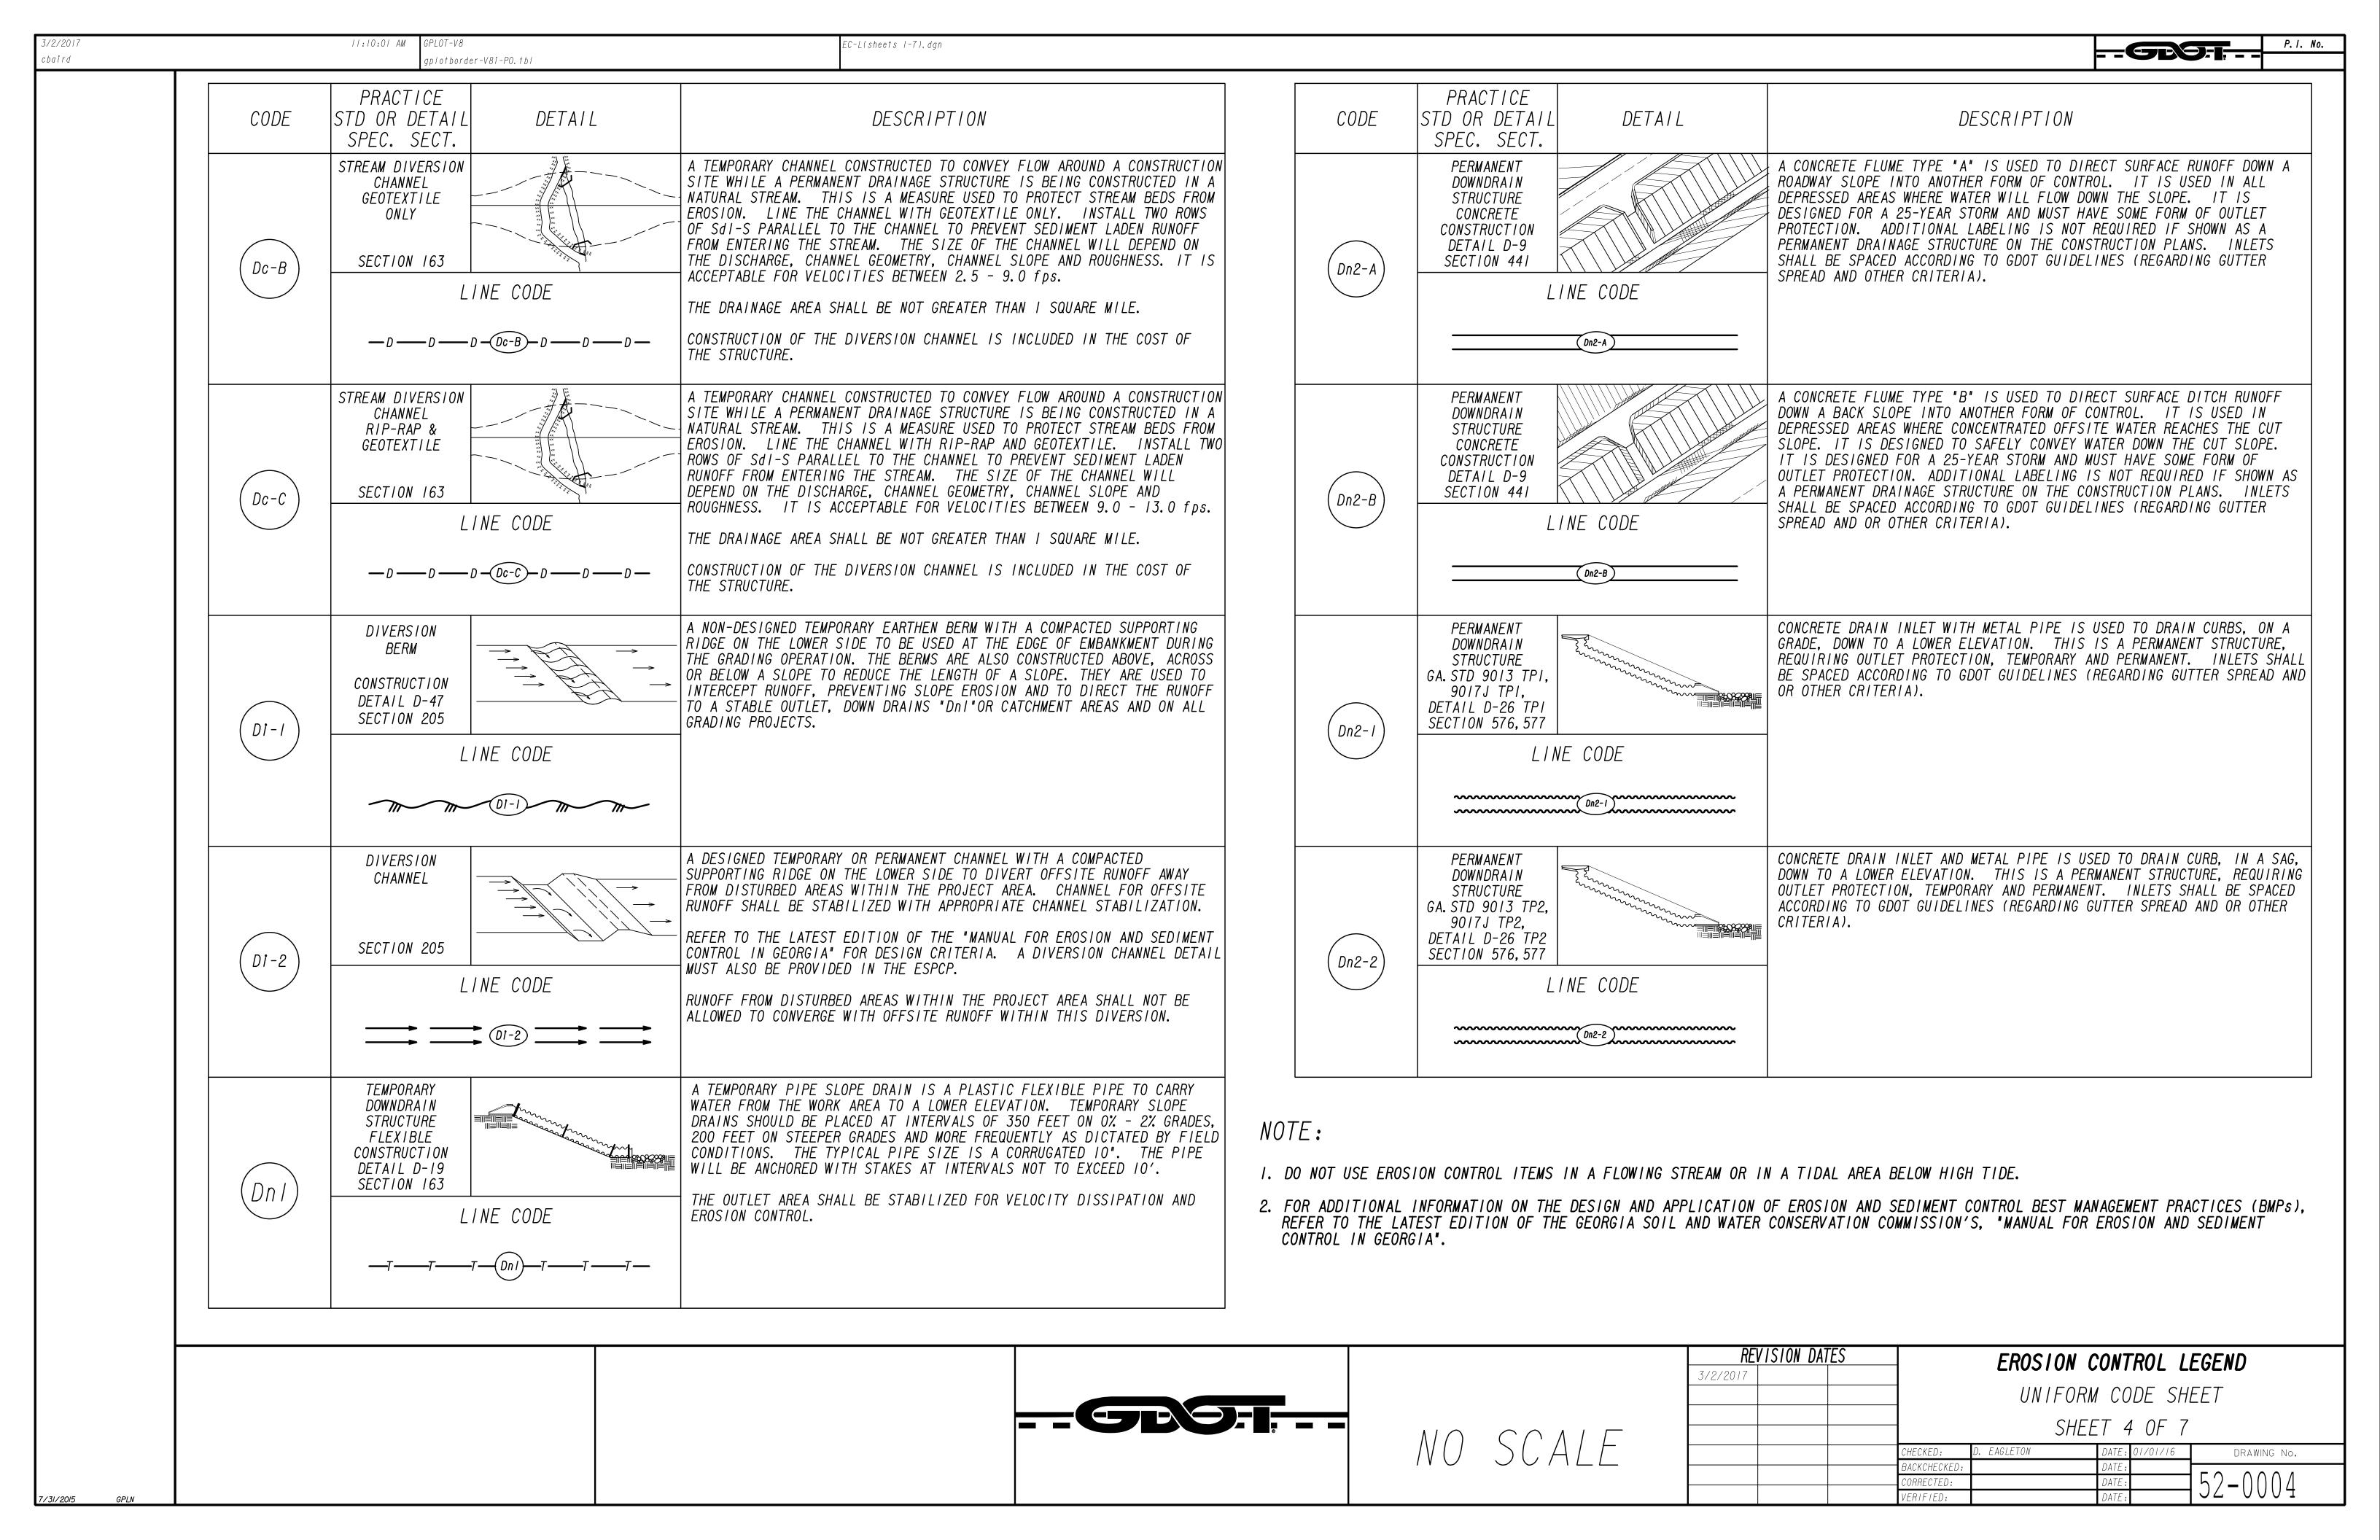
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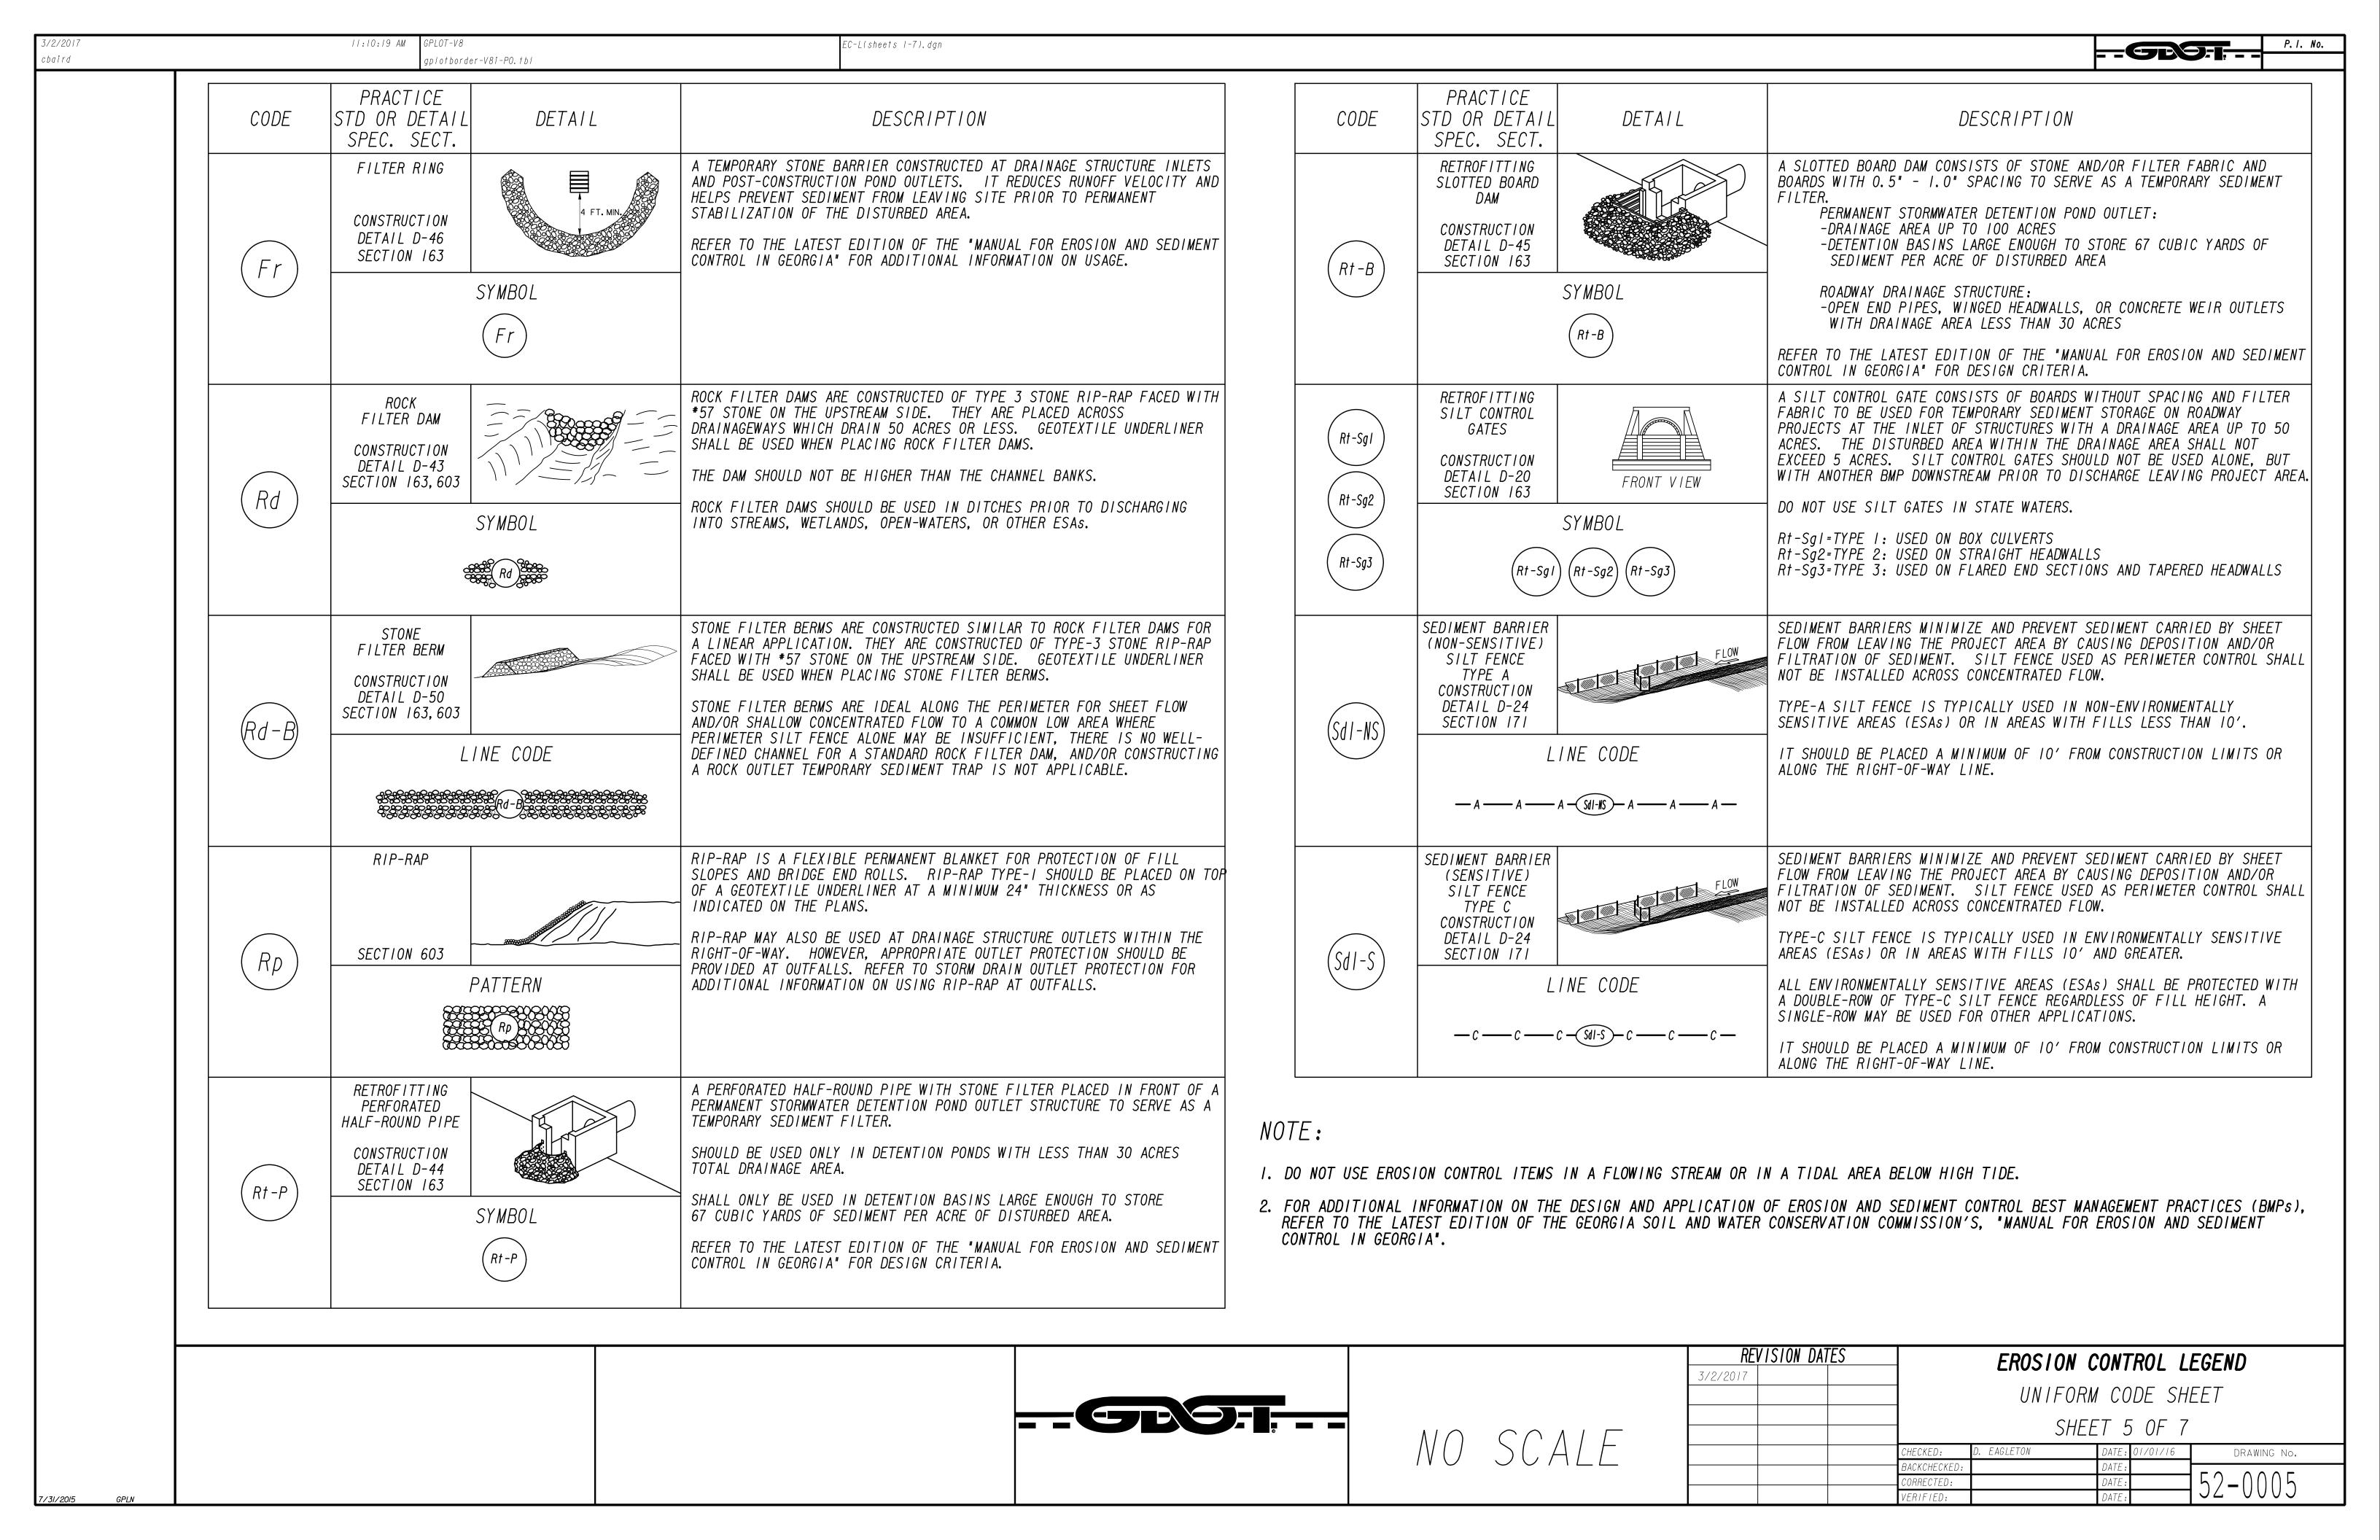
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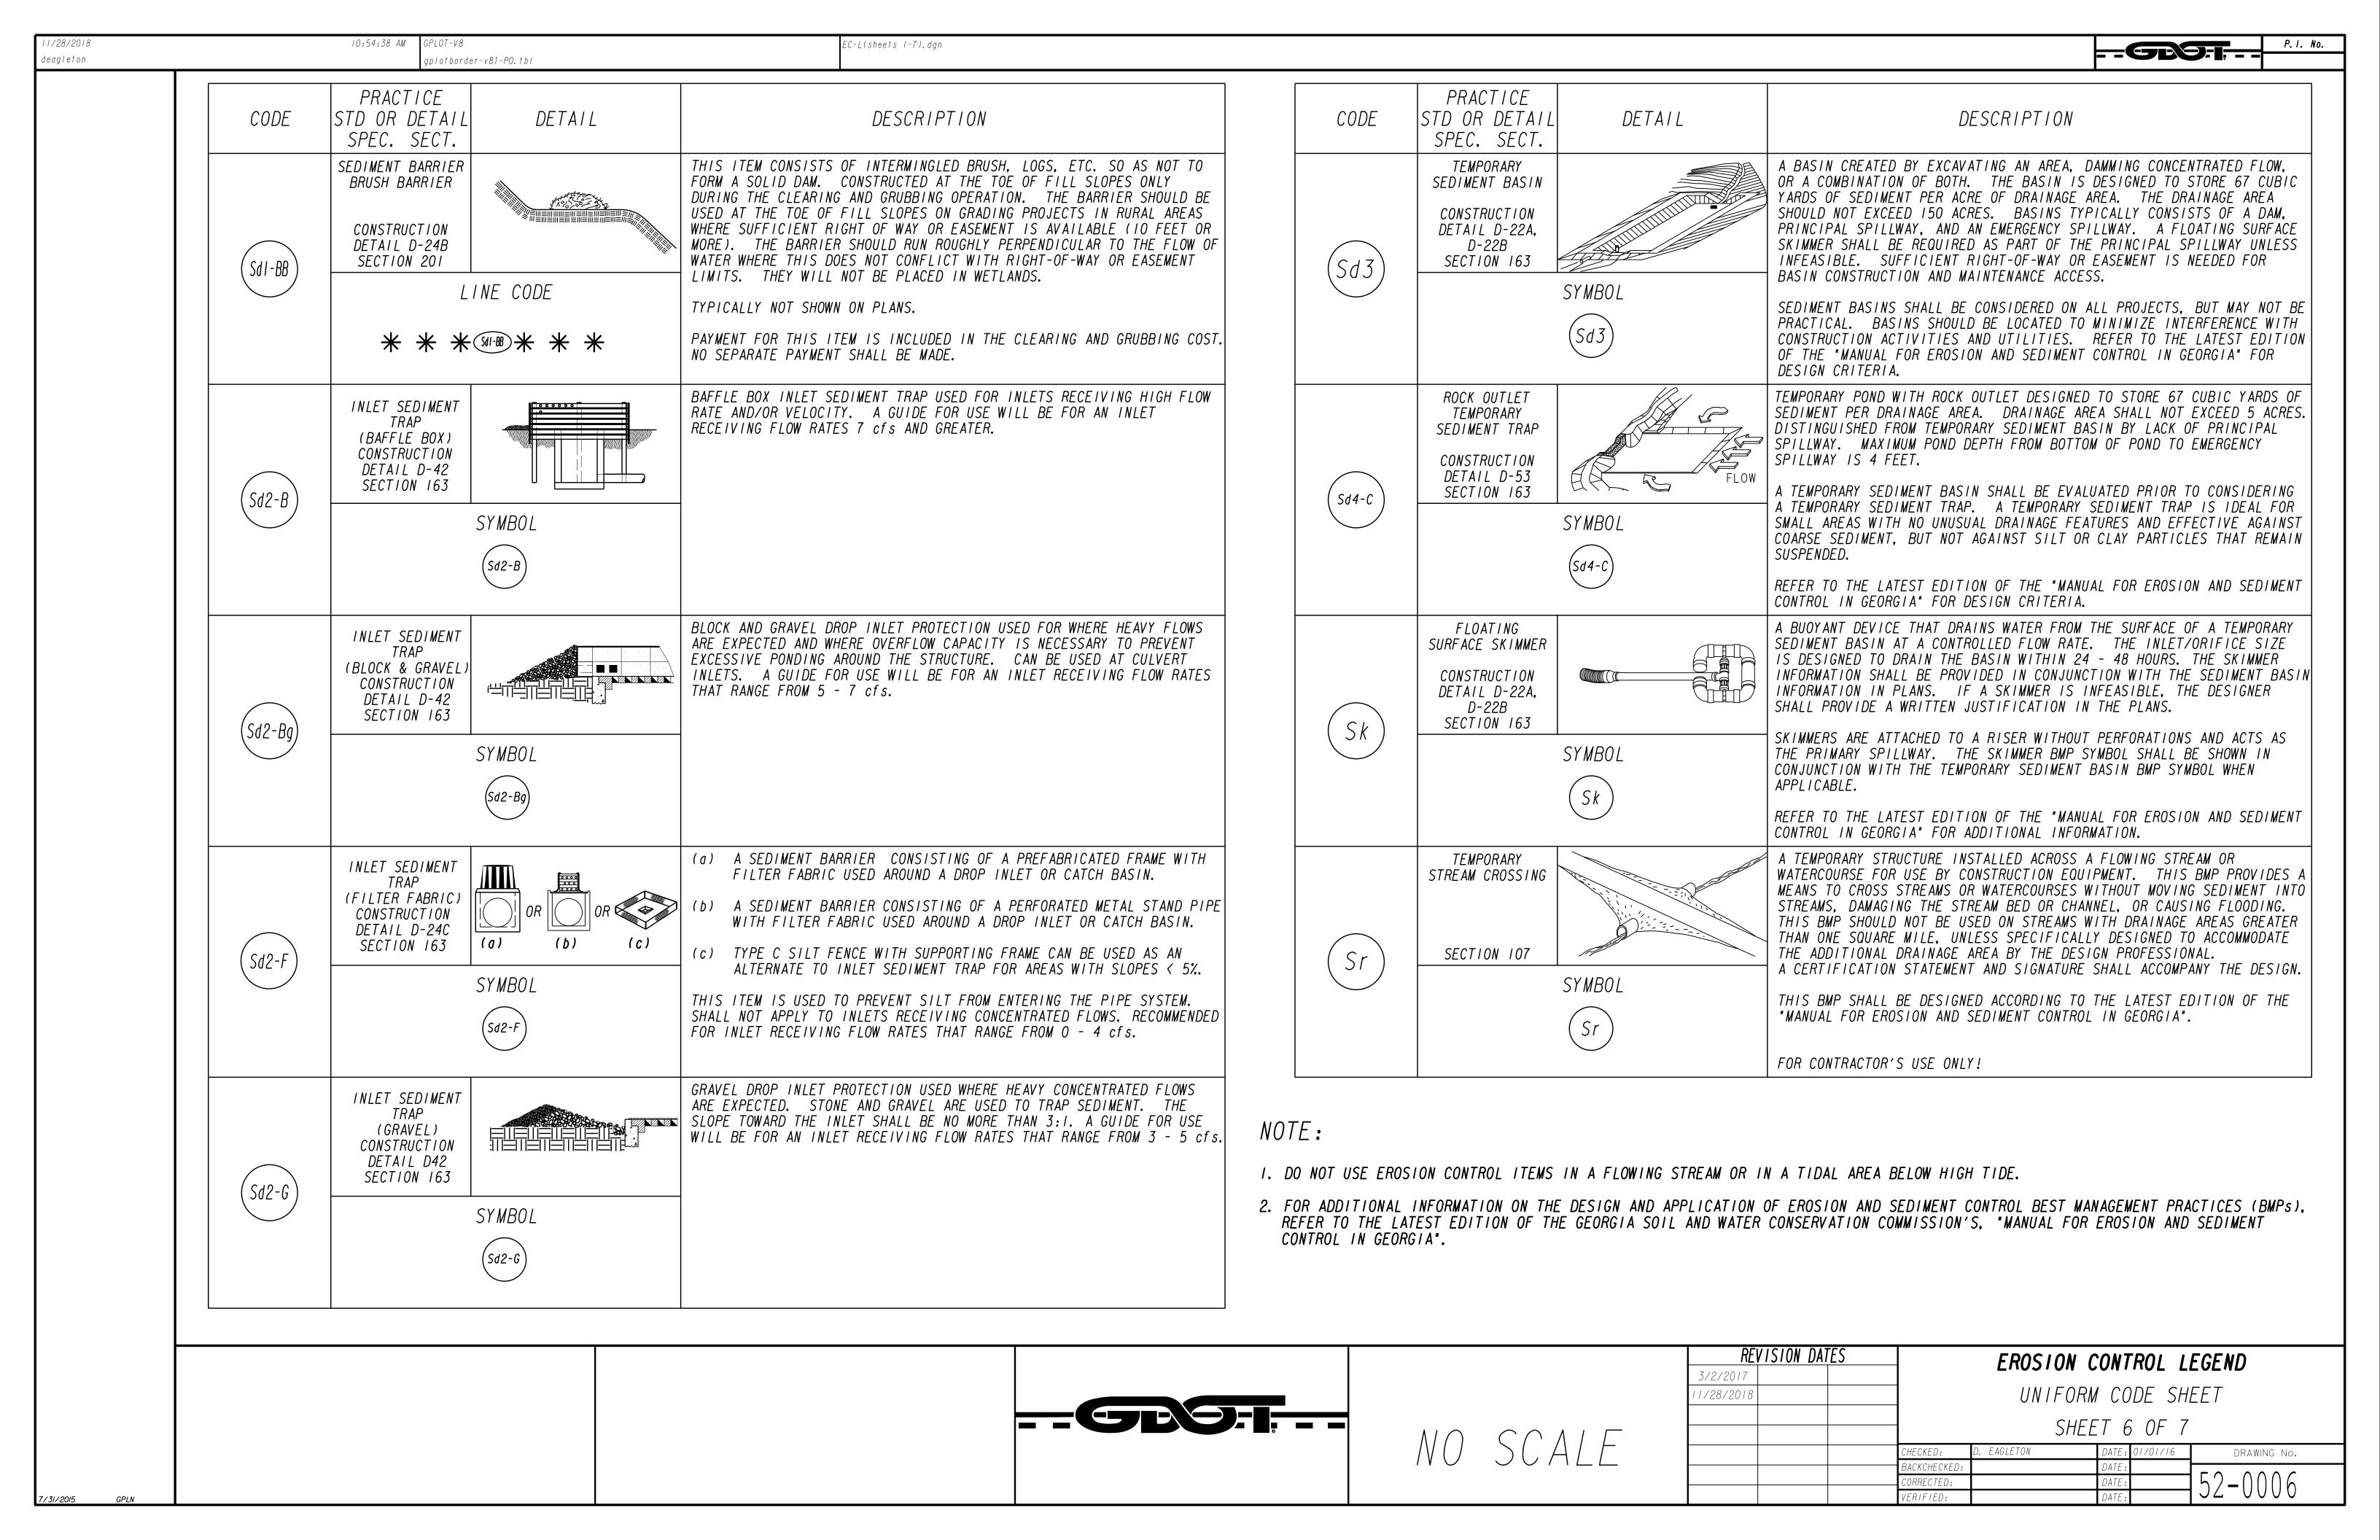













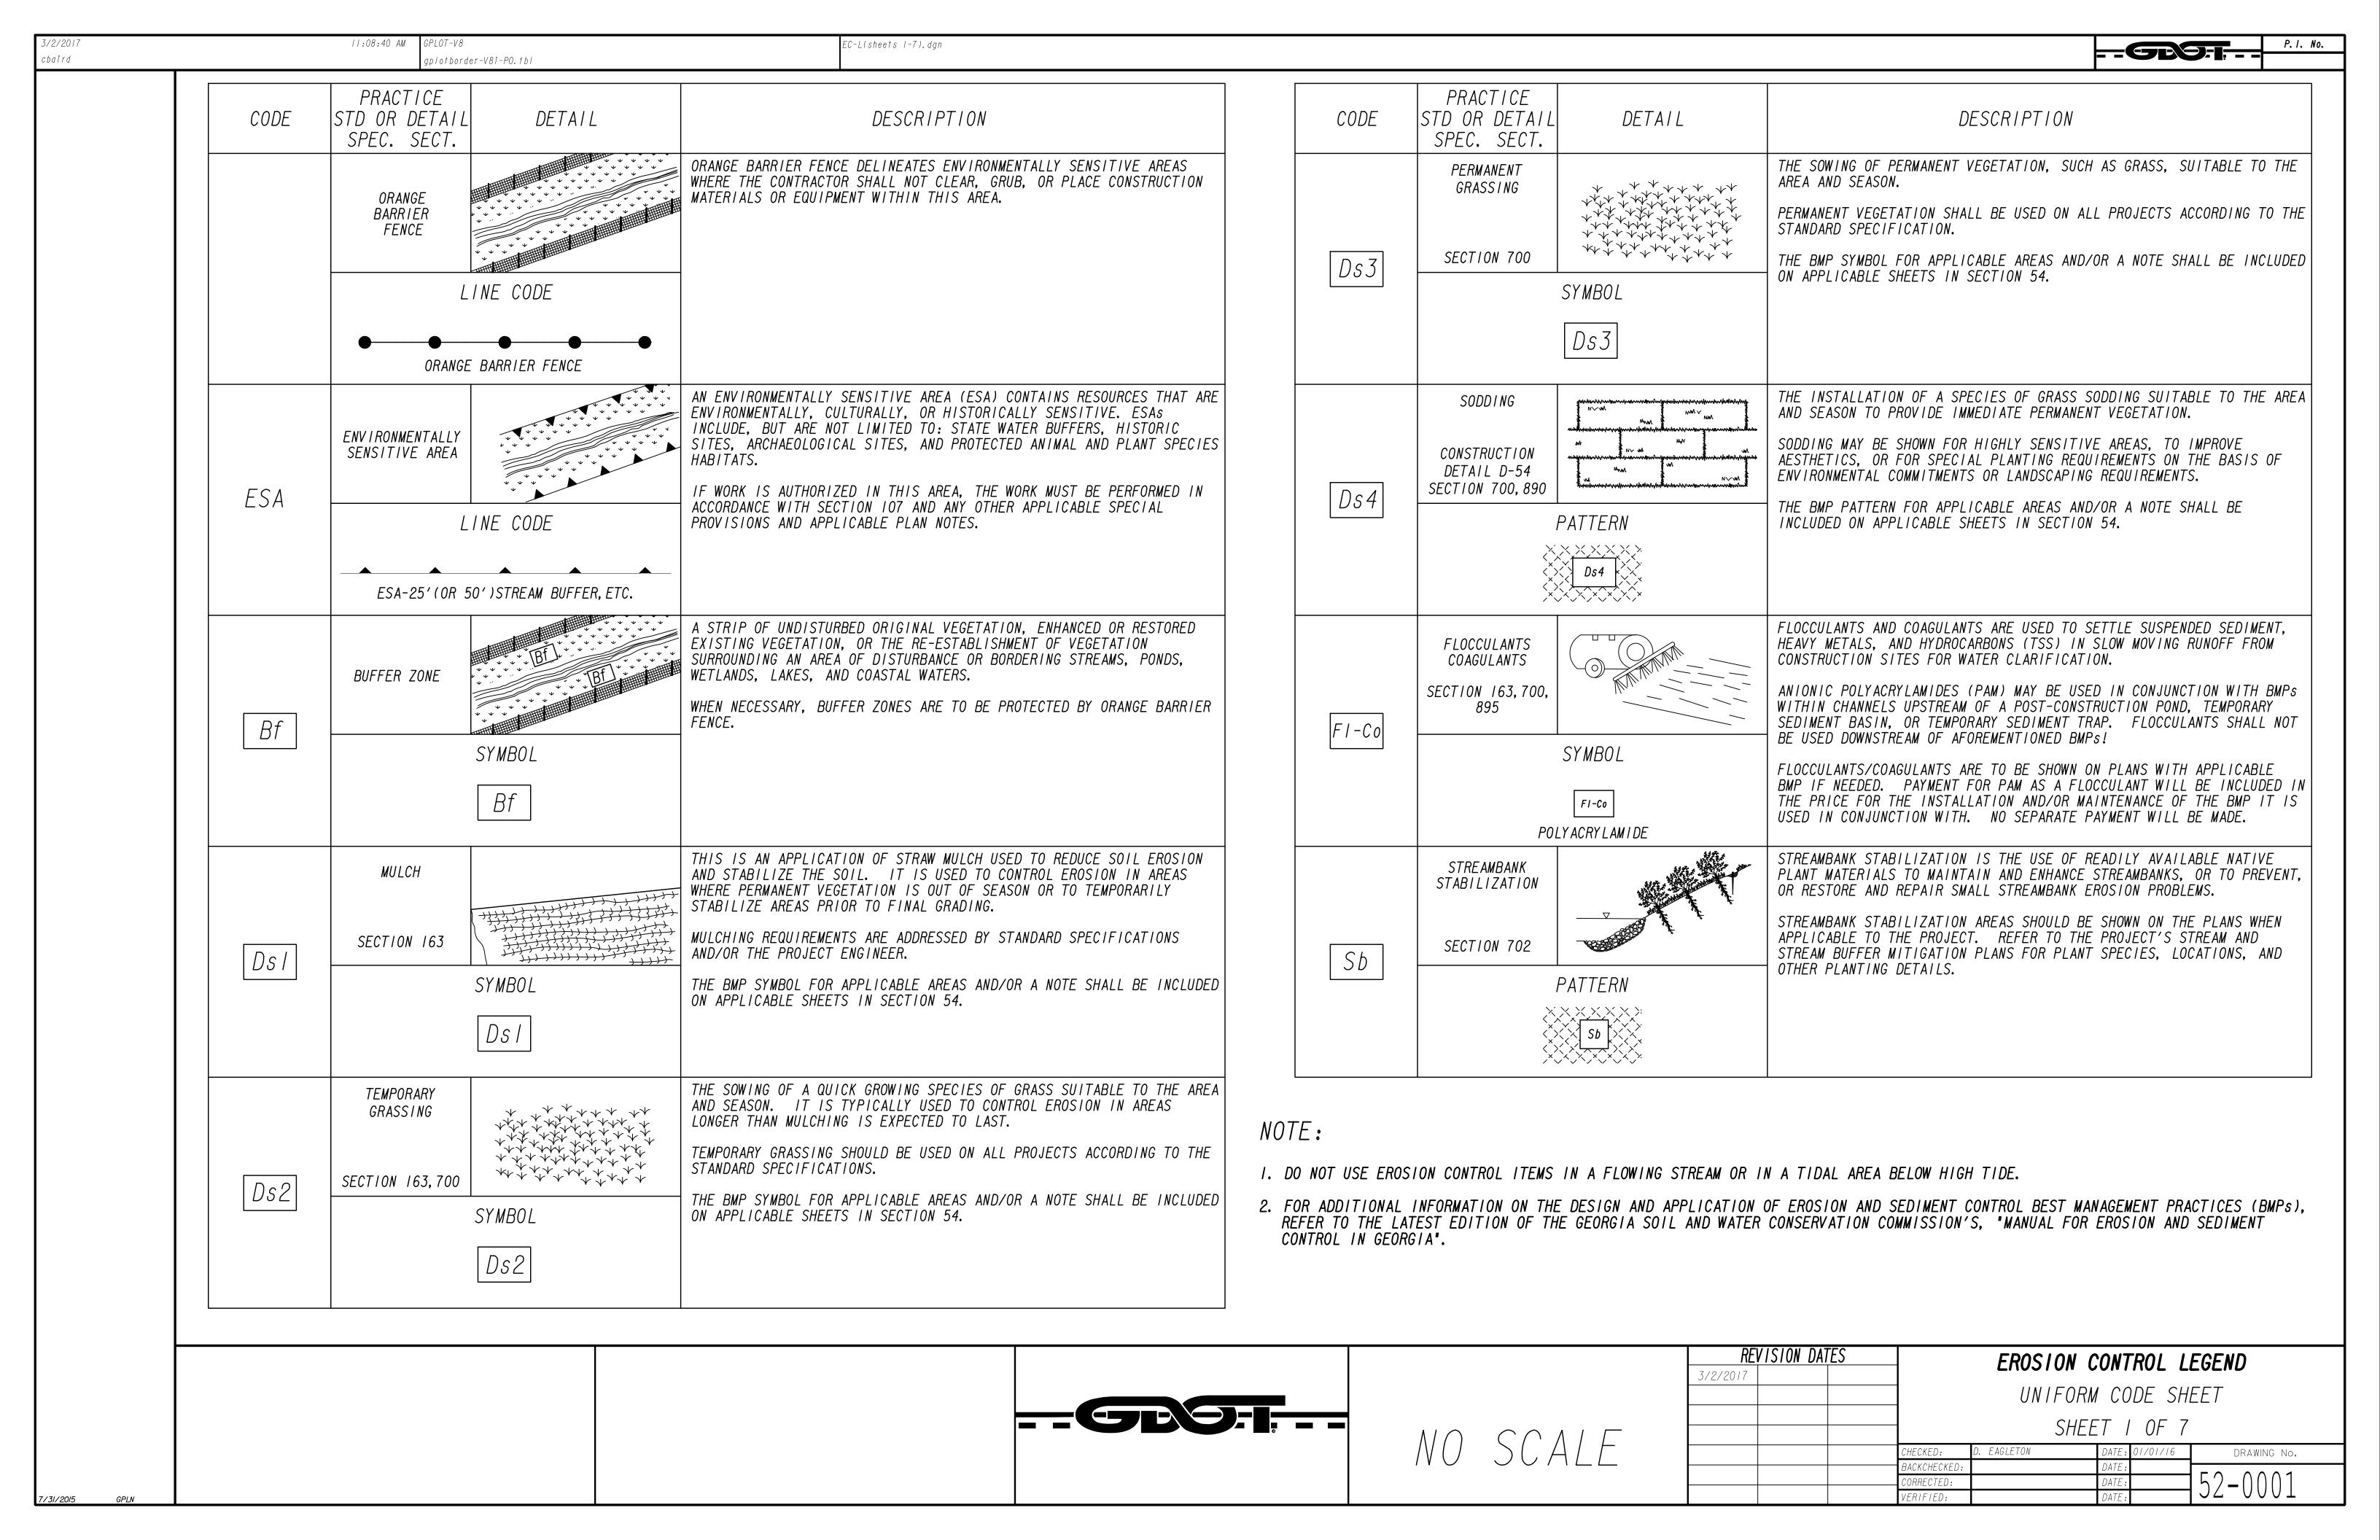



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COL	DE ST	PRACTICE D OR DETAIL PEC. SECT.	DETAIL	DESCRIPTION		CODE	PRACTICE STD OR DETAIL SPEC. SECT.	DETAIL		DESCRIPTION	
St	+	STORM DRAIN OUTLET PROTECTION GA. STD. 1125 & 2332	IBOL t	A PIPE OR BOX CULVERT OUTLET HEADWALL BLOCKS IS USED TO REDUCE VELOCITY AT TENTERING AN EXISTING STREAM OR PUBLICL IT IS USED ON THE OUTLET OF ALL BOX CUPIPES. MAY BE USED ON INLET FOR FLOWIT PIPES WHEN OUTLET VELOCITY OF THE 25-Y GREATER.	THE OUTLET OF A PIPE PRIOR TO Y MAINTAINED DRAINAGE SYSTEM. ILVERTS AND ON 48" AND LARGER ING STREAMS. USE ON SMALL						
St-1	OUT	STORM DRAIN LET PROTECTION (RIP-RAP)  CONSTRUCTION DETAIL D-55 SECTION 603  PATTERNAL OR	TERN  WELL-DEFINED CHANNEL	RIP-RAP OUTLET PROTECTION IS USED TO ROF A PIPE, CHANNEL, OR STRUCTURE PRIOR STREAM OR PUBLICLY MAINTAINED DRAINAGE OF RIP-RAP OUTLET PROTECTION SHALL BE BUT LARGER STORMS ARE RECOMMENDED.  TYPE-I RIP-RAP AT A DEPTH OF 36" AND PREFERRED FOR ALL d50 = 1.2 FEET. TIB" AND PLACED ON FILTER FABRIC MAY BE REFER TO THE LATEST EDITION OF THE "MACONTROL IN GEORGIA" FOR REQUIRED DESIGNIFORMATION TO BE INCLUDED IN THE PLAN</td <td>TO ENTERING AN EXISTING SYSTEM. THE MINIMUM DESIGN THE 25-YEAR STORM PEAK FLOW,  PLACED ON FILTER FABRIC IS SYPE-3 RIP-RAP AT A DEPTH OF E USED FOR d50 <!--= 0.7 FEET.  ANUAL FOR EROSION AND SEDIMENT ON DIMENSIONS AND OTHER</td--><td></td><td></td><td></td><td></td><td></td><td></td></td>	TO ENTERING AN EXISTING SYSTEM. THE MINIMUM DESIGN THE 25-YEAR STORM PEAK FLOW,  PLACED ON FILTER FABRIC IS SYPE-3 RIP-RAP AT A DEPTH OF E USED FOR d50 = 0.7 FEET.  ANUAL FOR EROSION AND SEDIMENT ON DIMENSIONS AND OTHER</td <td></td> <td></td> <td></td> <td></td> <td></td> <td></td>						
Su	SE (	SURFACE ROUGHENING TRRATED SLOPES CONSTRUCTION DETAIL S-7 SECTION 205  LINE	CODE	PROVIDING A ROUGH SOIL SURFACE WITH HOOPERATING A CLEATED DOZER ON THE SLOPE CREATING SERRATED SLOPES IN THE GRADIN BENCHES WILL REDUCE RUNOFF VELOCITY AN WATER.  IN MOST CASES THIS BMP IS NOT REQUIRED BUT REQUIRED TO BE COMPLETED BY THE COULT SERRATED SLOPES ARE SPECIFIED BY THE SHALL BE SHOWN ON THE PLANS WHERE SERRA	IN A VERTICAL DIRECTION.  IG PROCESS TO CONSTRUCT  ID INCREASE INFILTRATION OF  O TO BE SHOWN ON THE PLANS,  ONTRACTOR UNDER ALL PROJECTS.  HE SOIL SURVEY, THEN THIS BMP						
Tc-		DETAIL D-51 SECTION 170	WORK AREA  FLOATING  CODE	A FLOATING TURBIDITY CURTAIN IS USED TO MOVING IN WATER BY ALLOWING IT TO DROP WITHIN THE CONSTRUCTION AREA. IT IS TO CONSTRUCTION IS REQUIRED IN A LARGE BOURIVERS. IT SHOULD BE USED WHEN PERMIT INTO A STATE WATER, OR AS A SUPPLEMENT PERIMETER BMPs.  IT MAY ALSO BE REFERRED TO AS A FLOATING SILT CURTAIN.	POUT OF SUSPENSION AND REMAIN TYPICALLY USED WHERE DDY OF WATER SUCH AS LAKES AND D BY THE ENGINEER. TITED FILL IS BEING PLACED TO ADEQUATELY PLACED						
Tc-		DETAIL D-51 SECTION 170	WORK AREA  STAKED  CODE	A STAKED TURBIDITY CURTAIN IS USED TO MOVING IN WATER BY ALLOWING IT TO DROP WITHIN THE CONSTRUCTION AREA. IT IS TO INUNDATED AREAS. IT MAY BE USED TO PROPE REALIGNED OR RESTORED. IN THIS CASE, BOTTOM OF STREAMBED. THE HEIGHT SHOULD DIRECTED AND EXTEND 2 FEET ABOVE NORMAND BE USED AS DIRECTED BY THE ENGINEER.  THIS BMP IS ONLY TO BE USED WHEN PERMIT INTO A STATE WATER, OR AS A SUPPLEMENT PERIMETER BMPs.  IT MAY BE REFERRED TO AS A SILT BARRIE	POUT OF SUSPENSION AND REMAIN TYPICALLY USED IN SHALLOW ROTECT A SMALL STREAM BEING CURTAIN SHOULD EXTEND TO LD BE LIMITED TO 5 FEET UNLESS AL WATER ELEVATION. IT SHOULD TO ADEQUATELY PLACED	2. FOR ADDITIONAL	INFORMATION ON THE	DESIGN AND APPLICAT	OR IN A TIDAL AREA BEI ION OF EROSION AND SEL ATER CONSERVATION COMM		NAGEMENT PRACTICES (BMPs EROSION AND SEDIMENT
5 GPLN							NO SCA	3/2/20 	C.F. B.F.	UNIFORM	CONTROL LEGEND  CODE SHEET  T 7 OF 7  DATE: 01/01/16 DRAWING No.  DATE: 52-0007

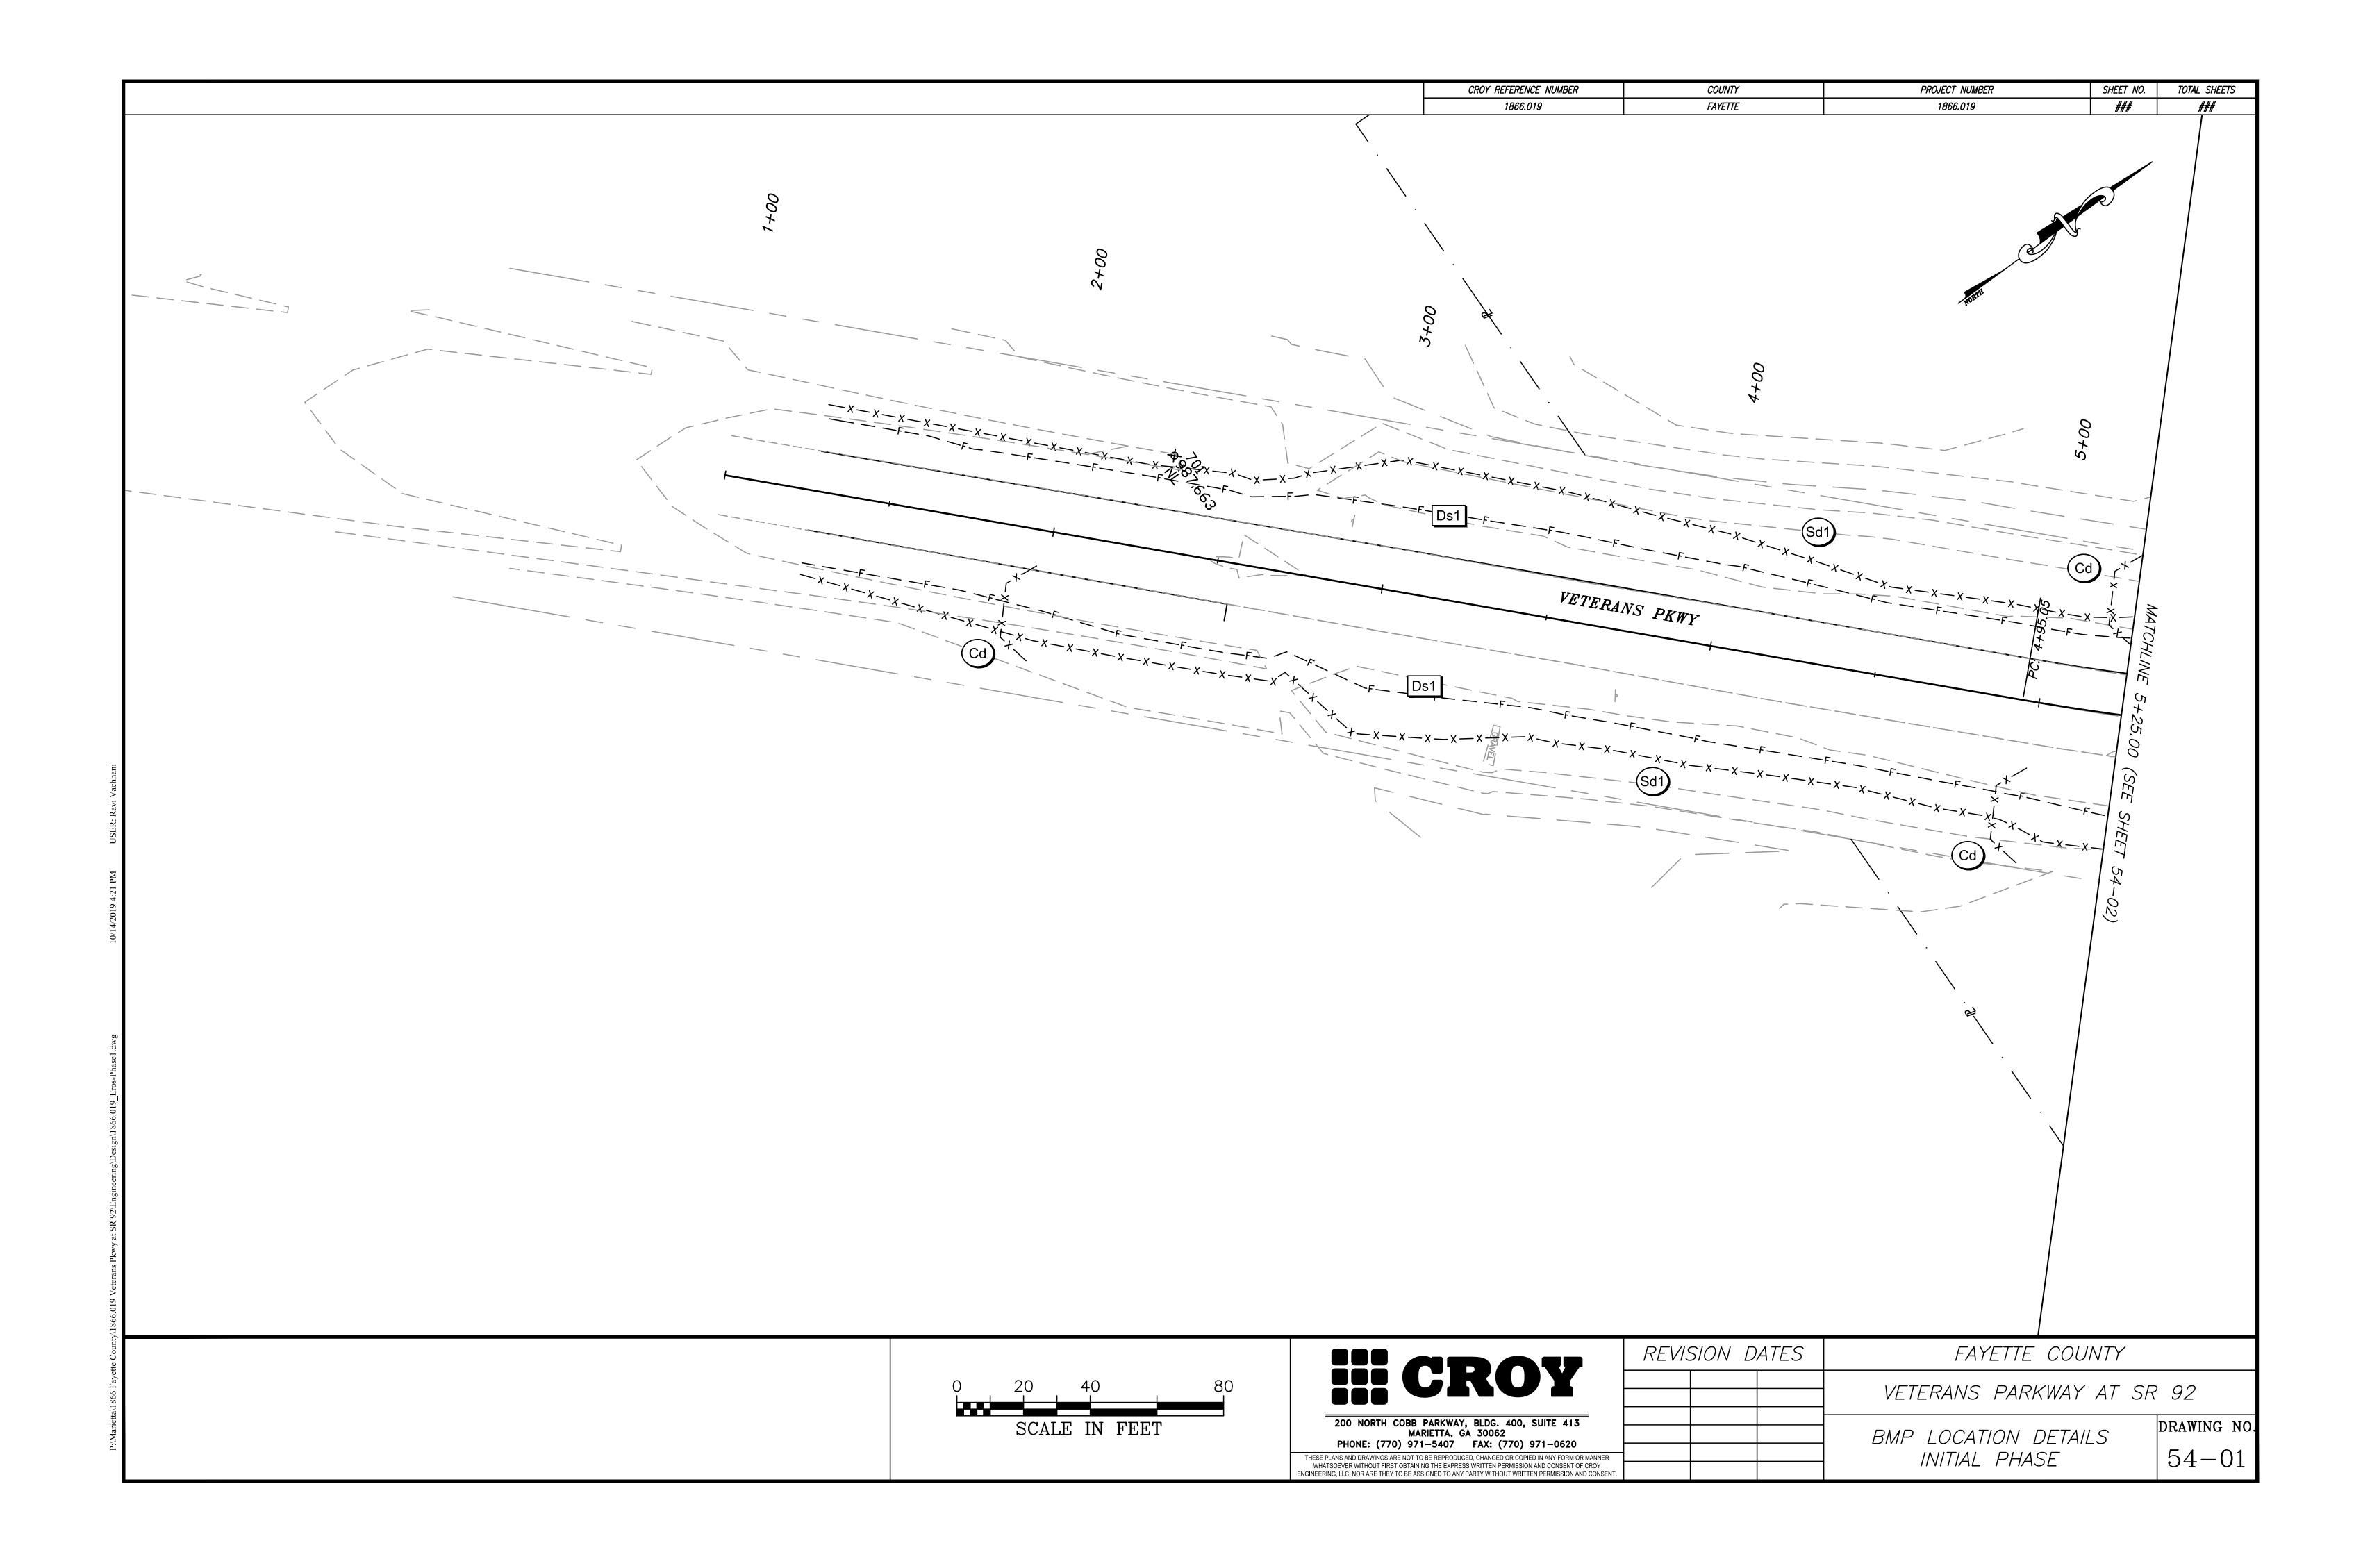


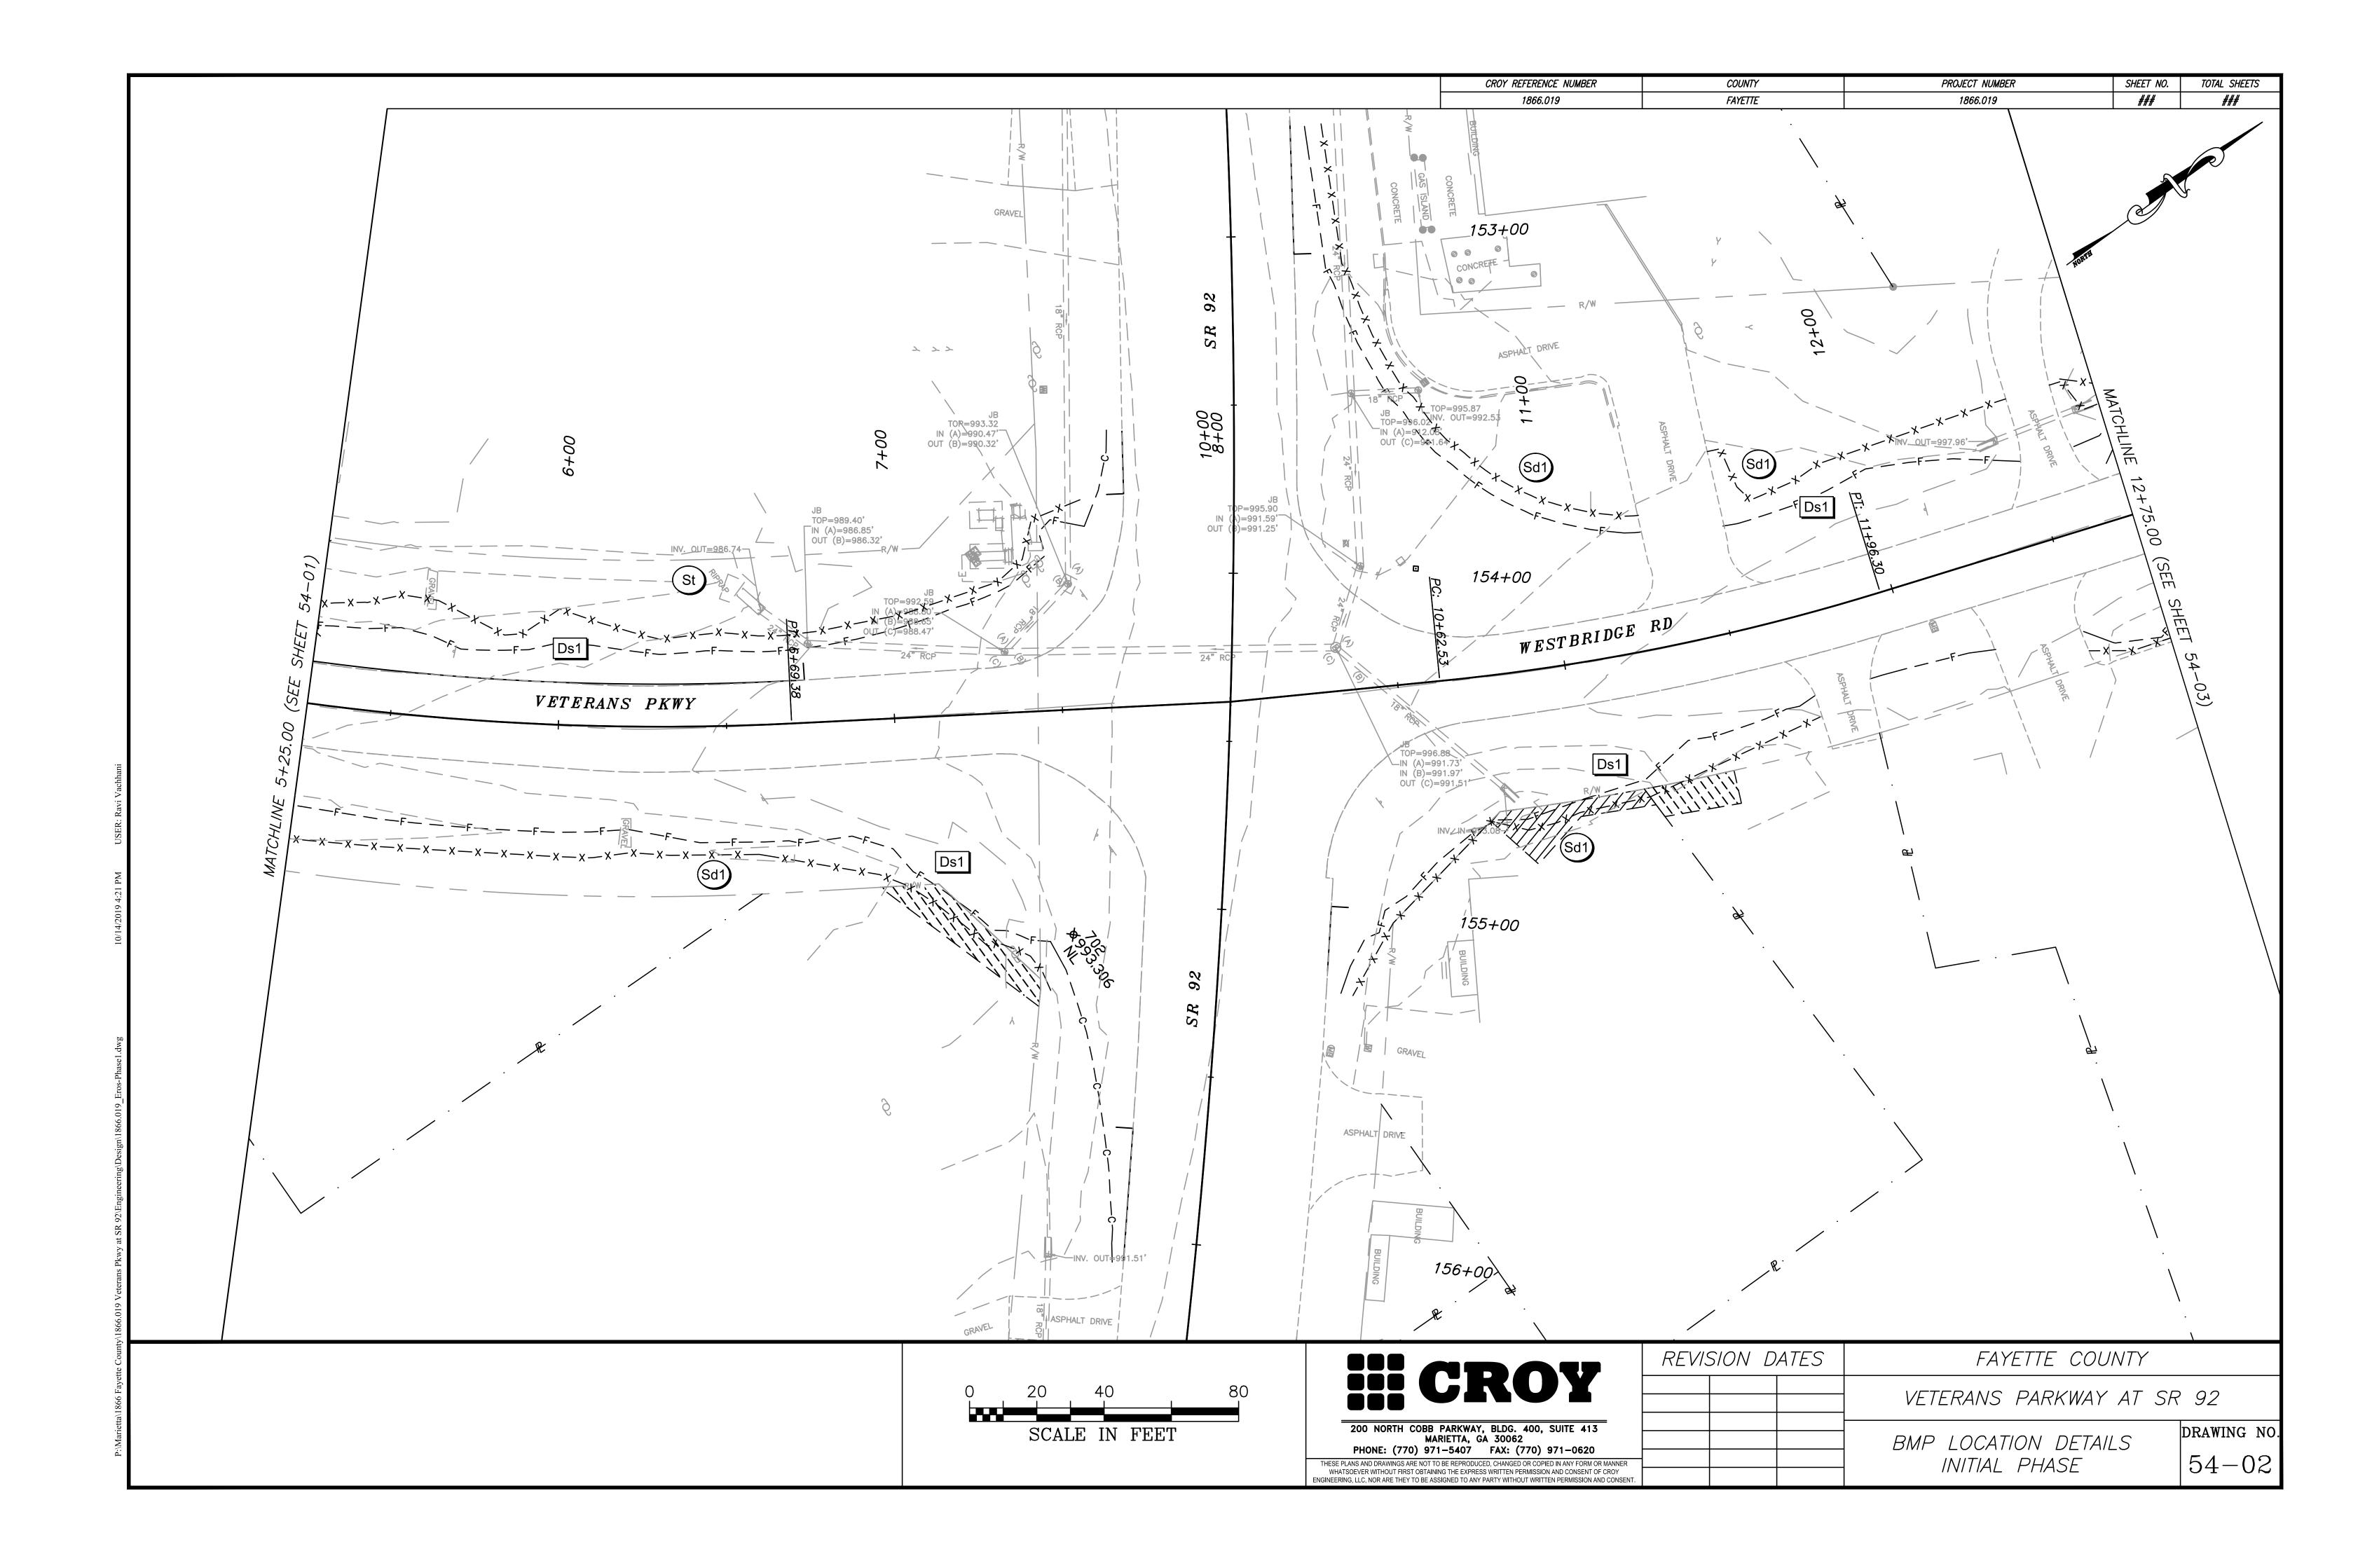


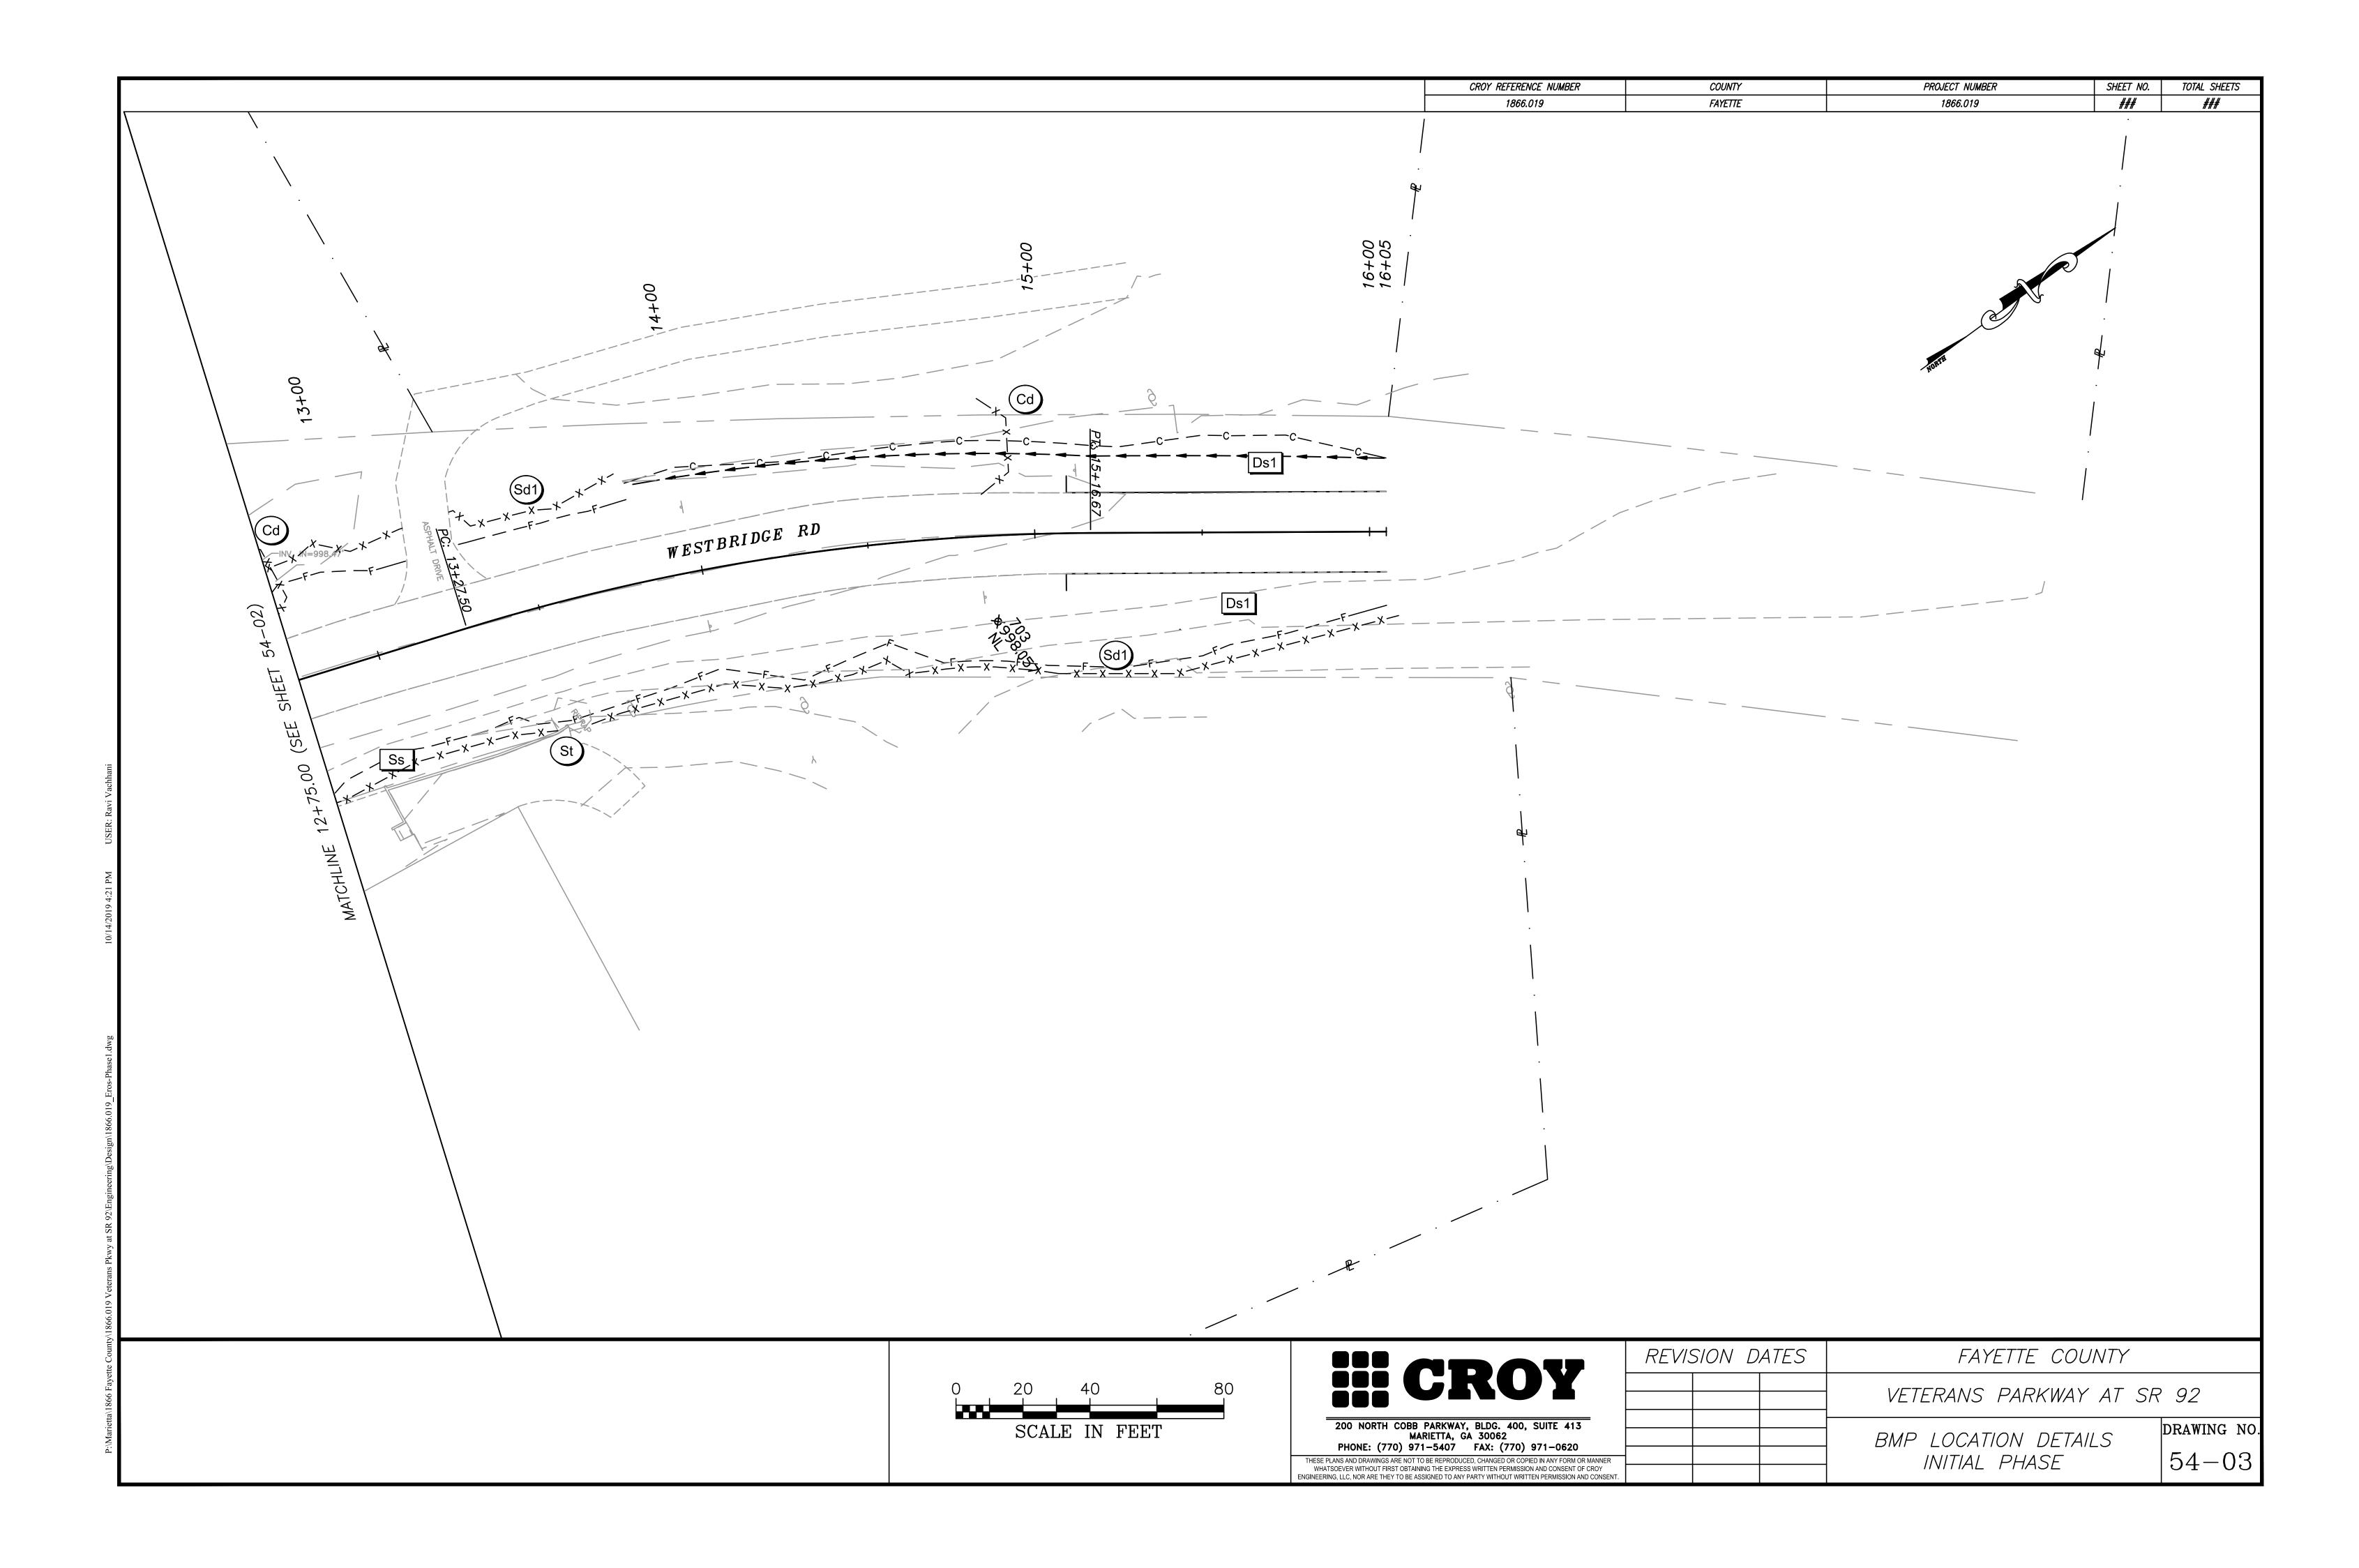


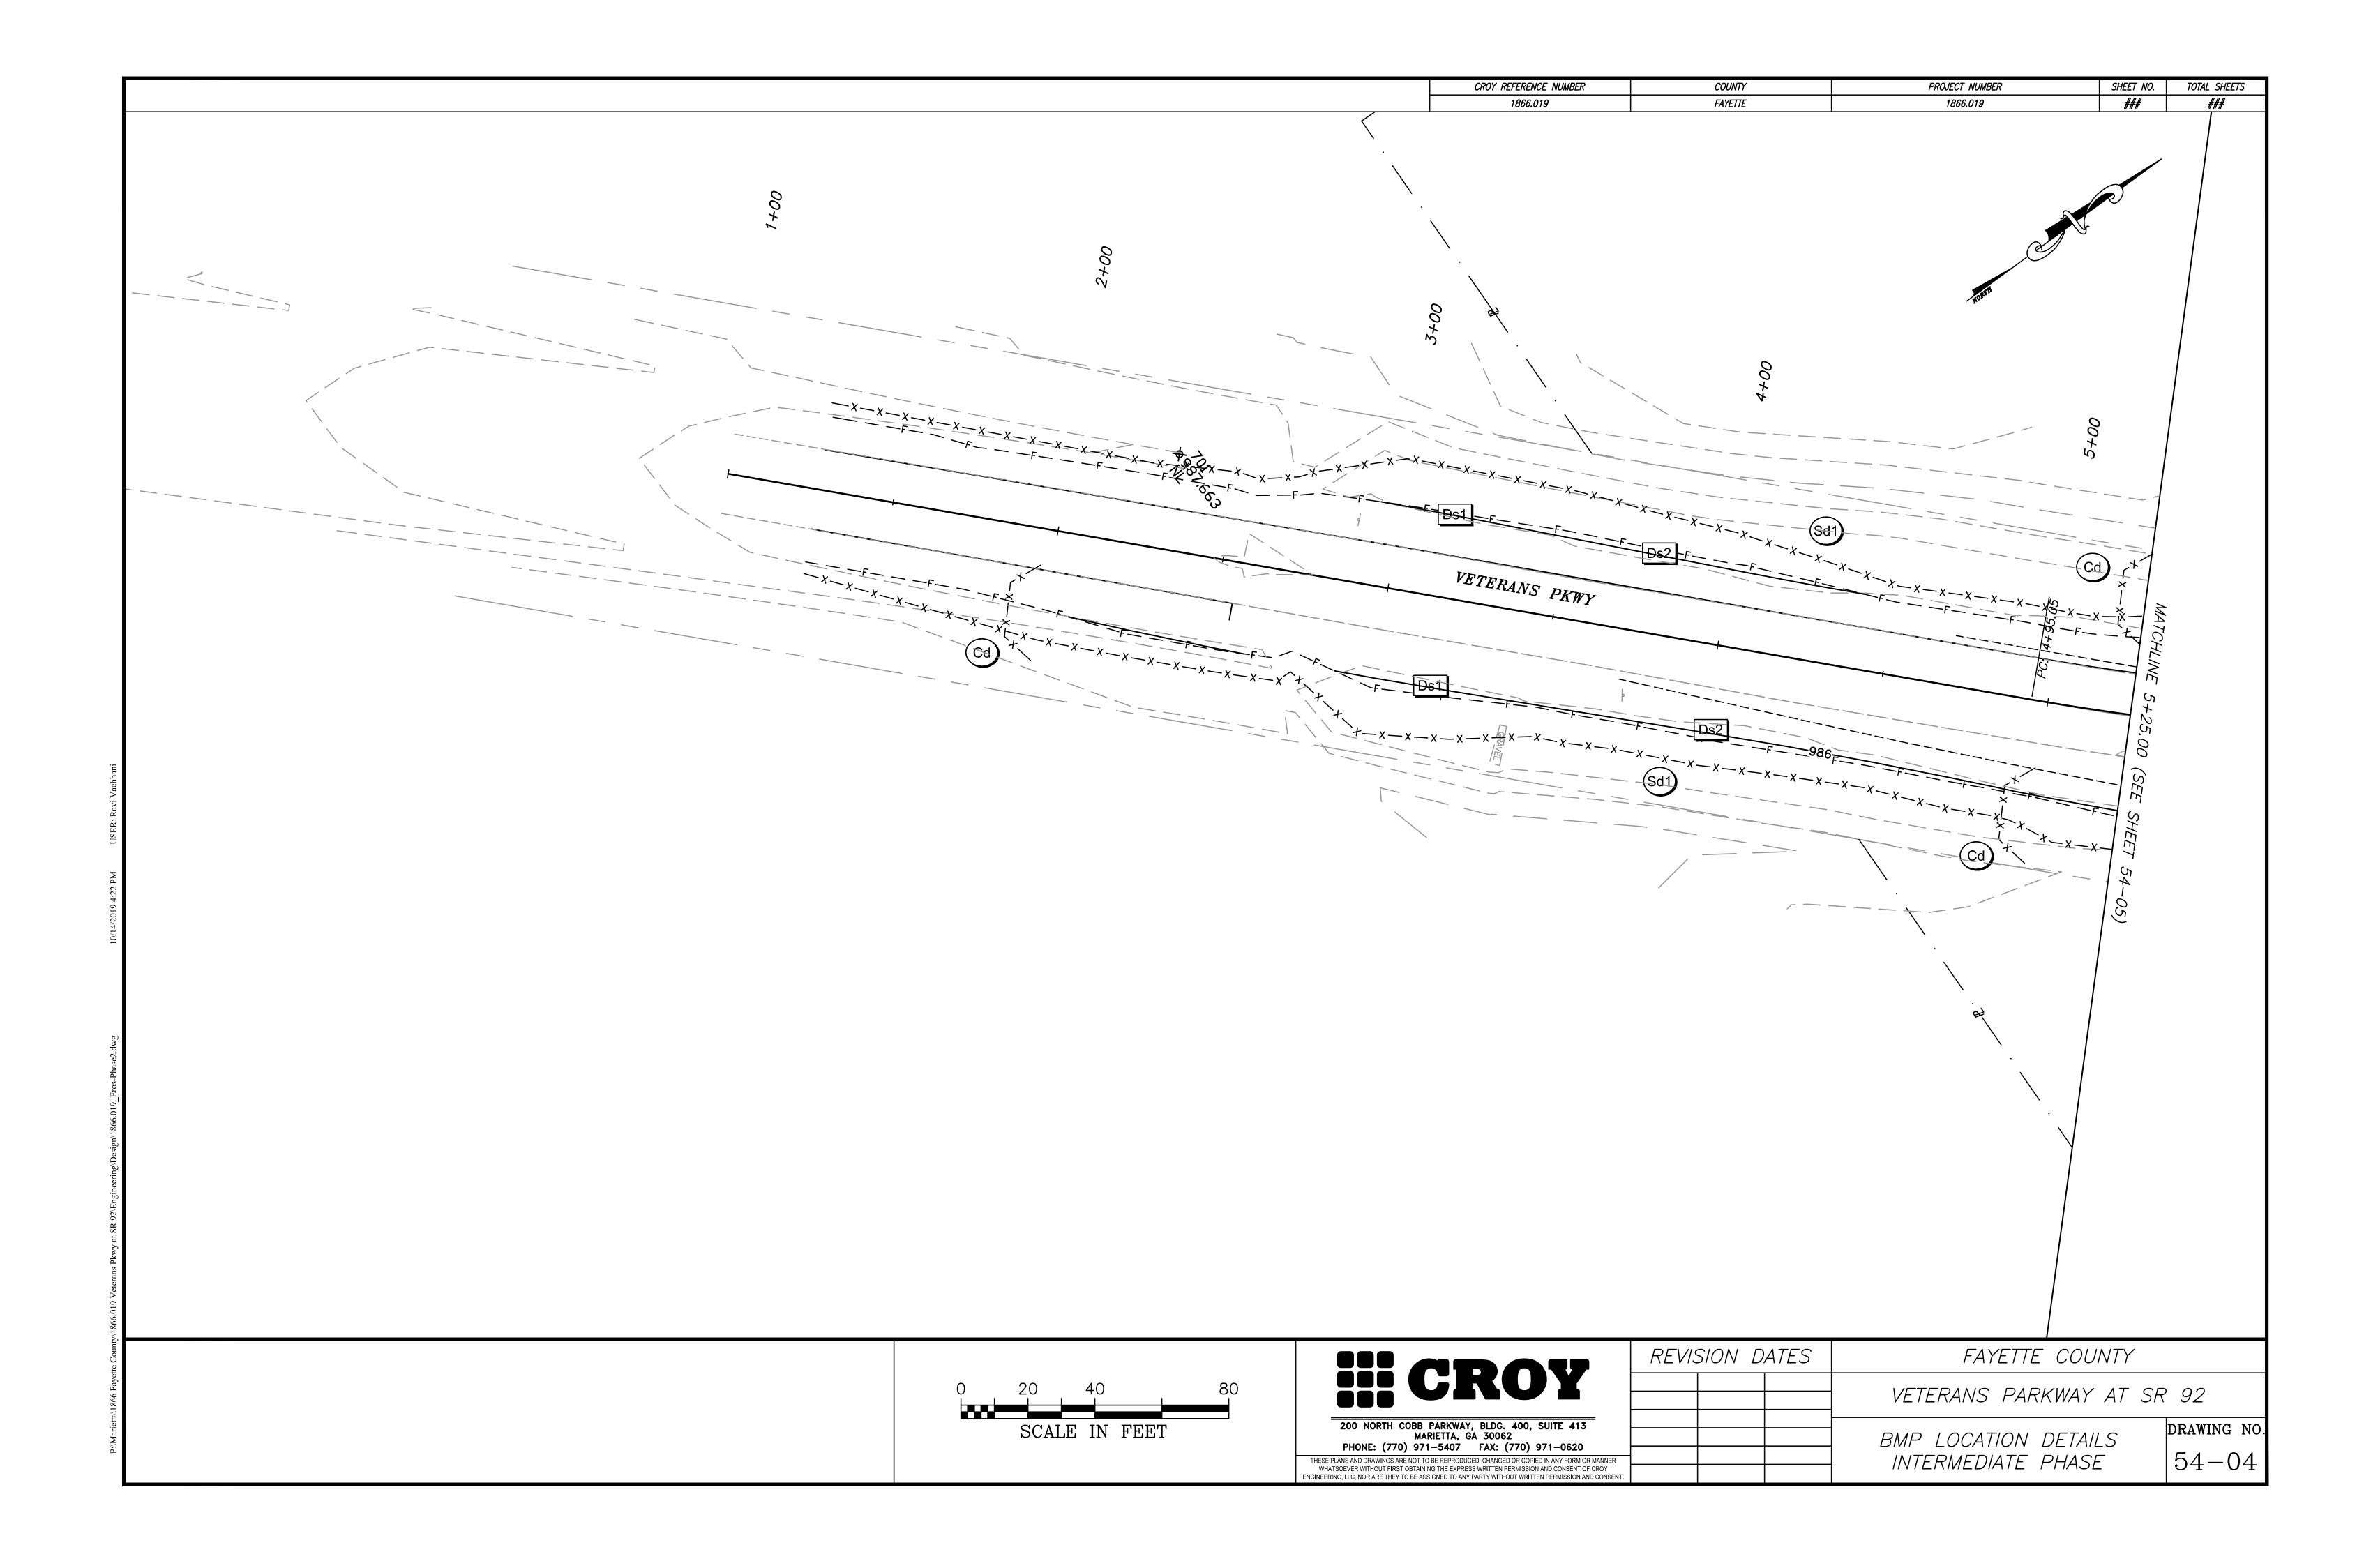


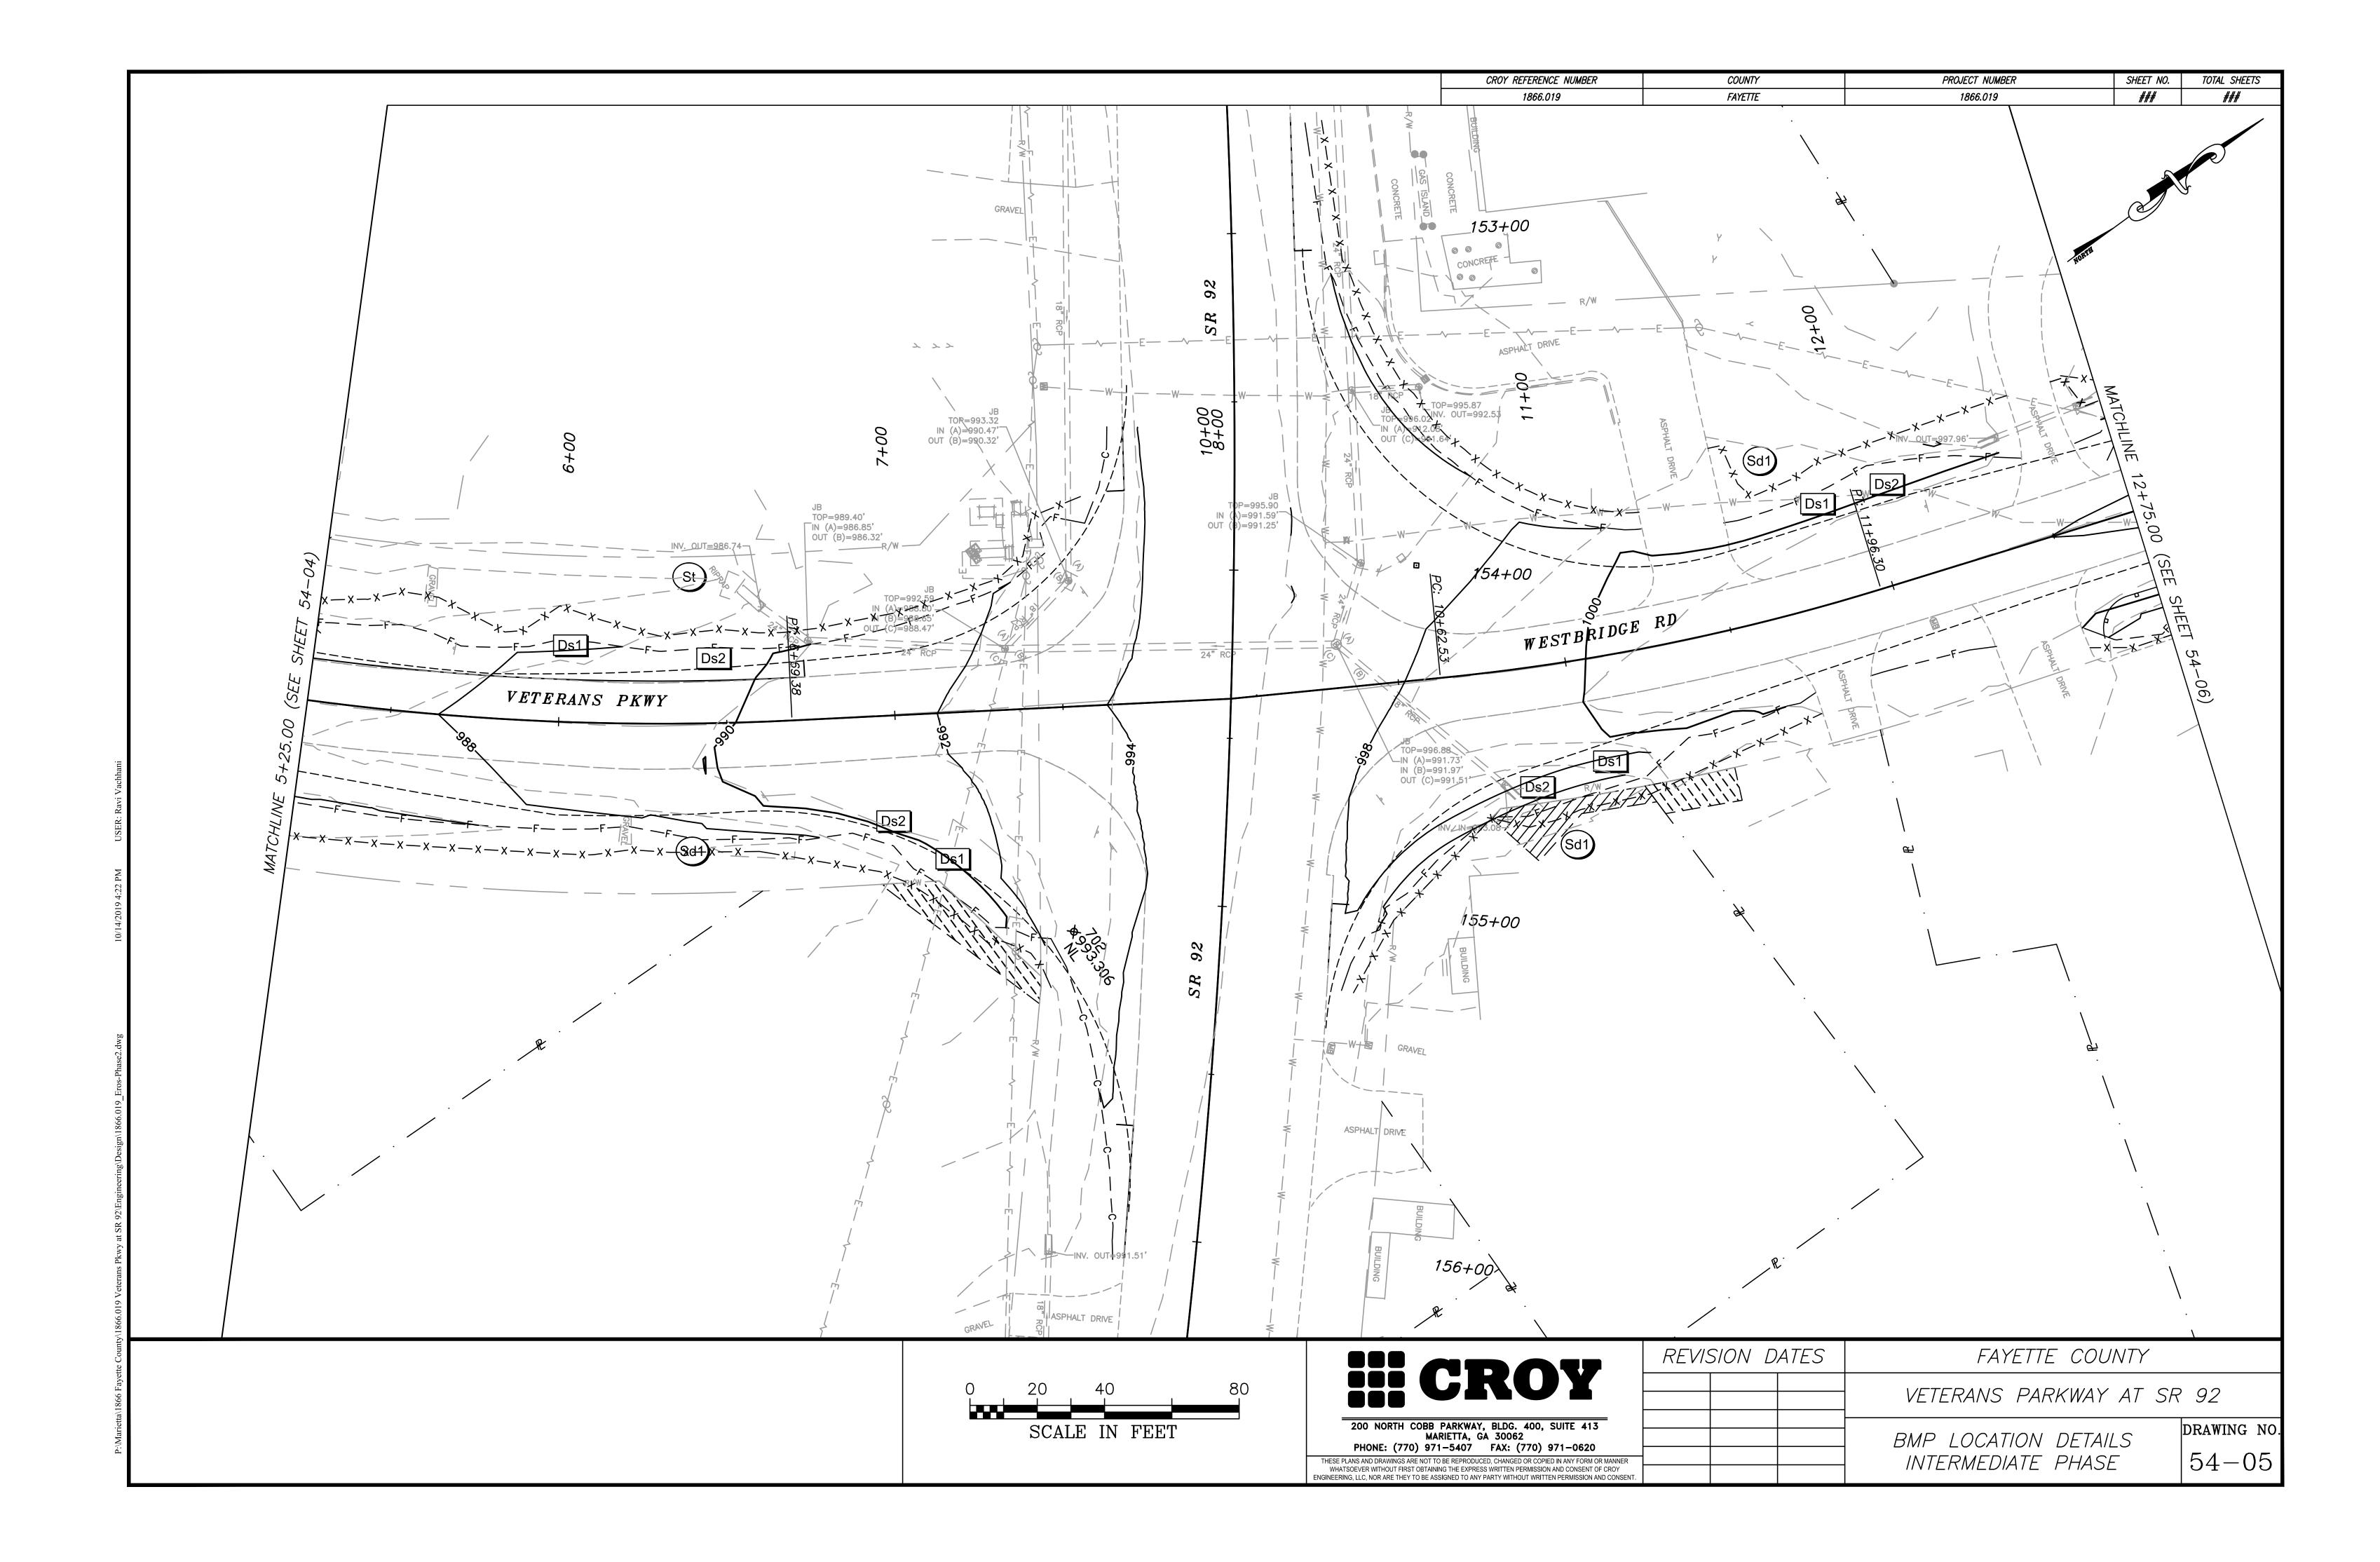

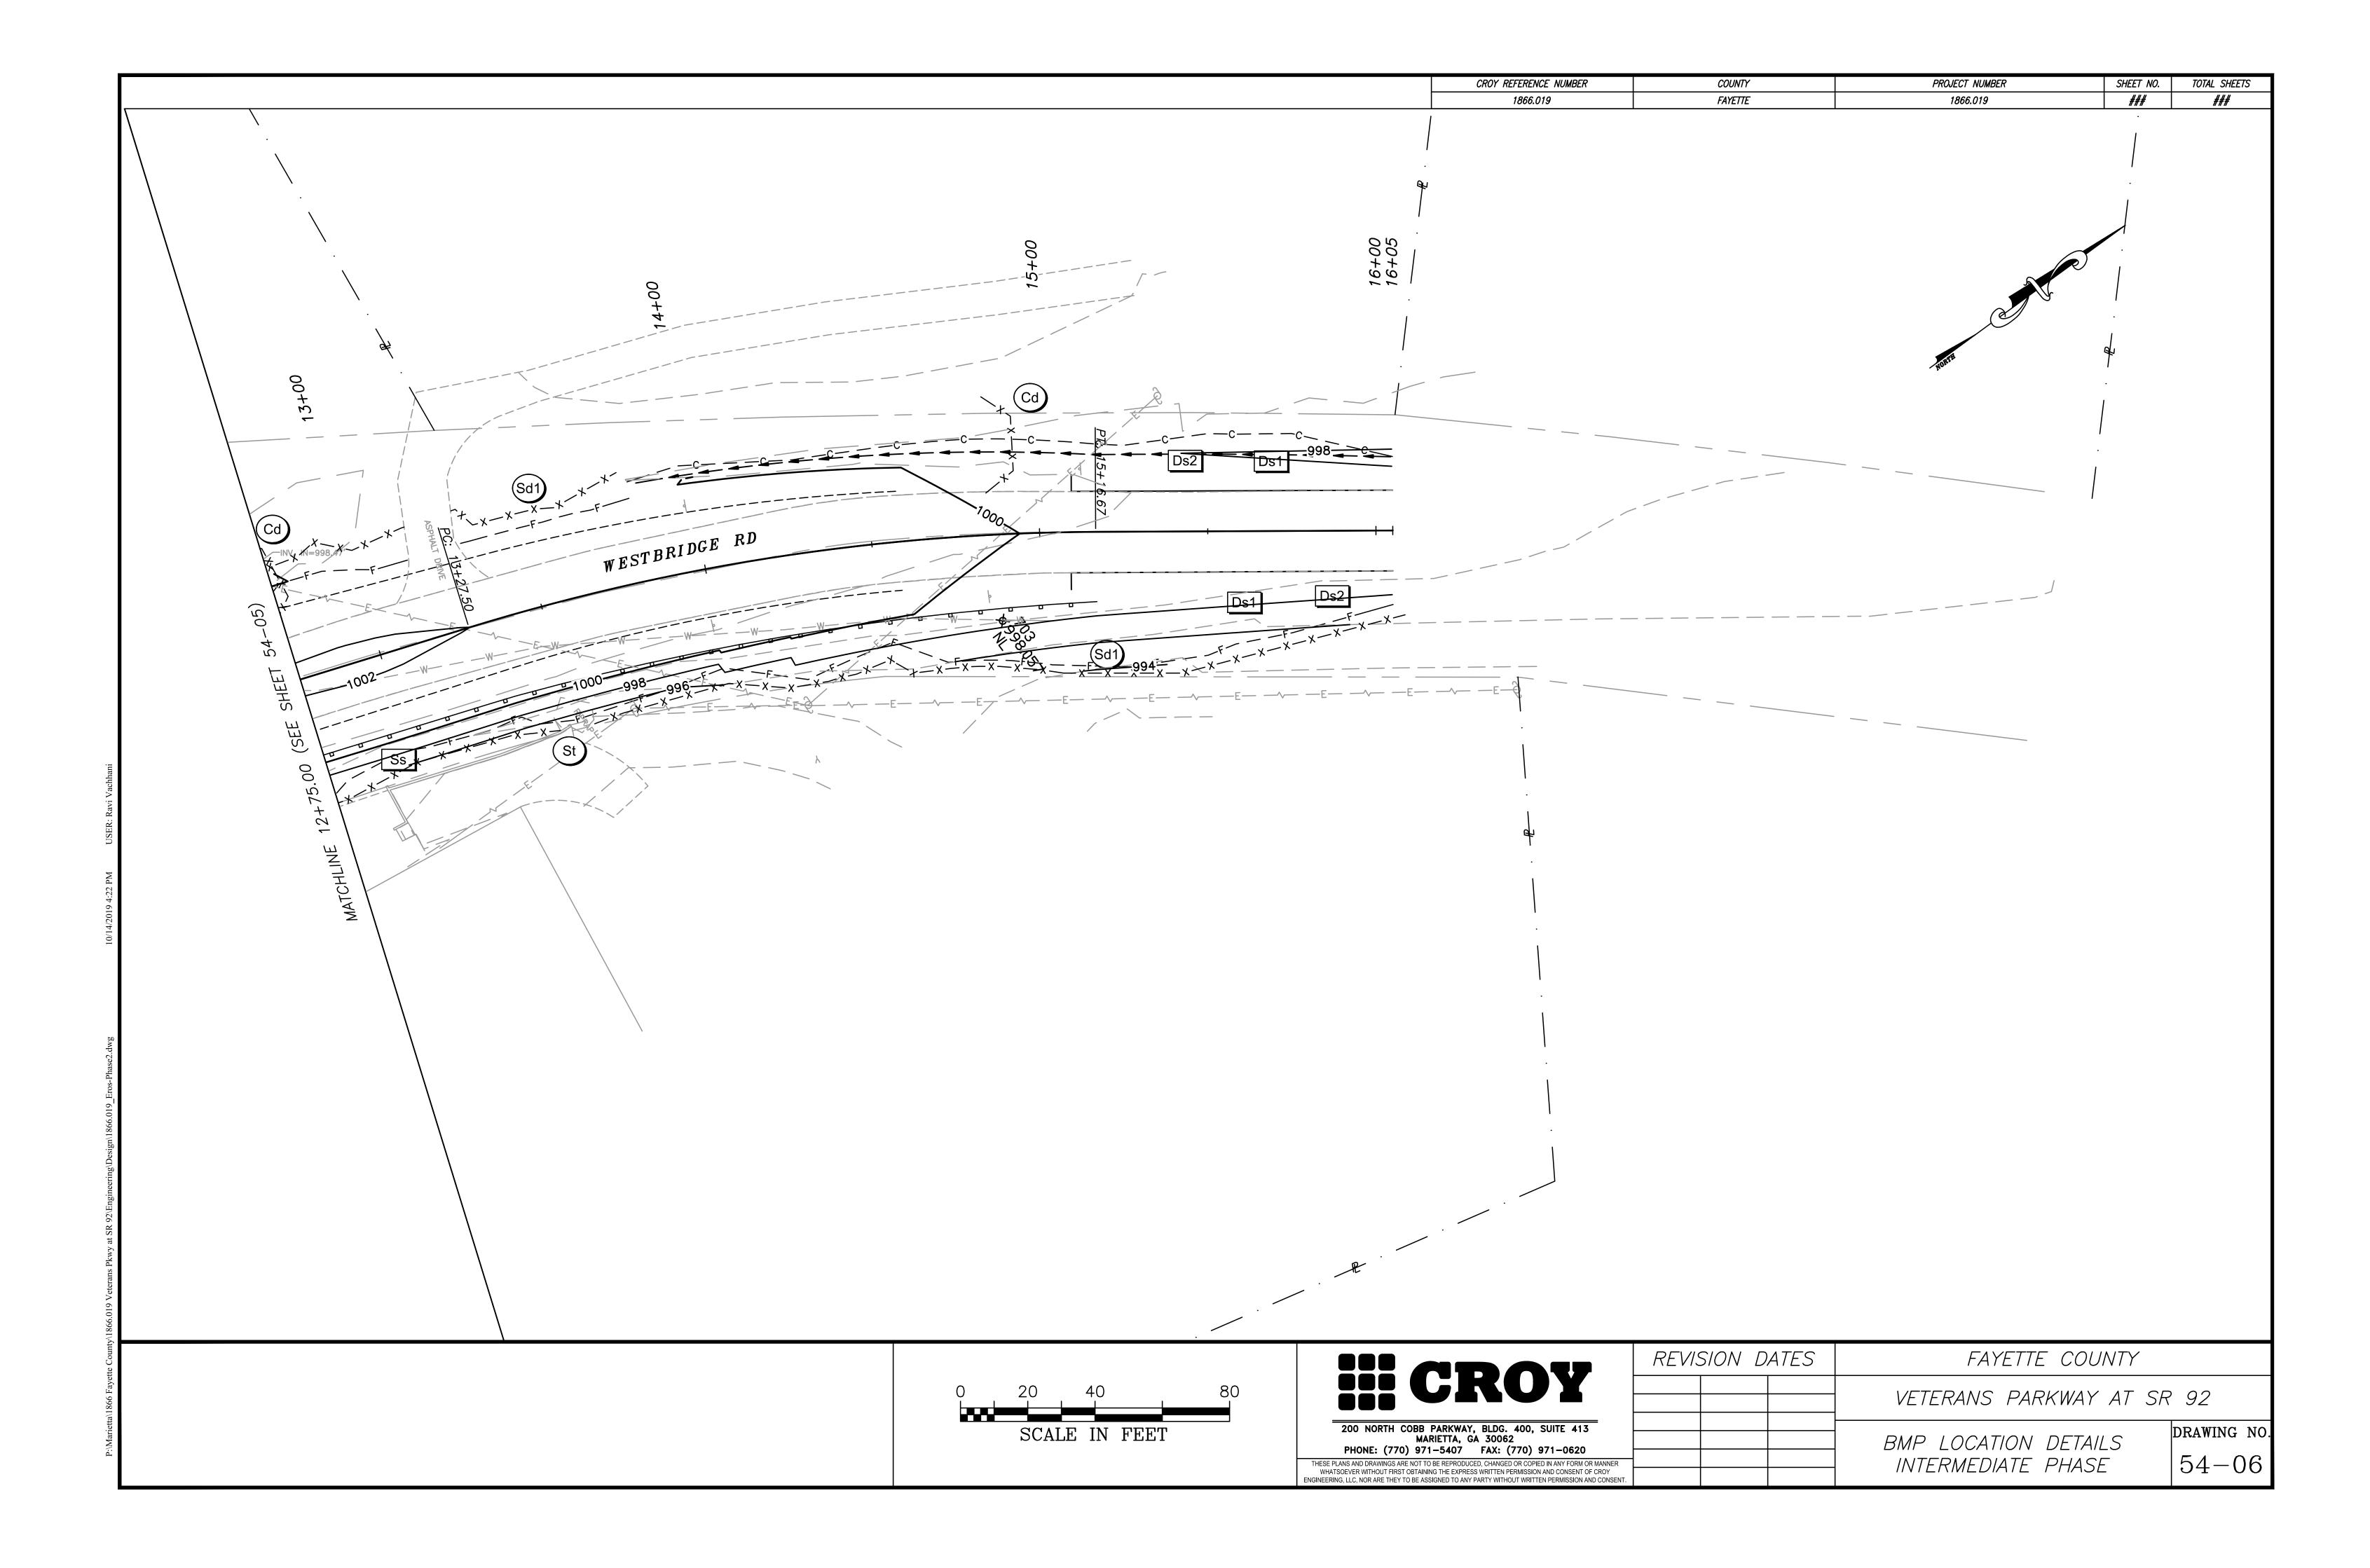

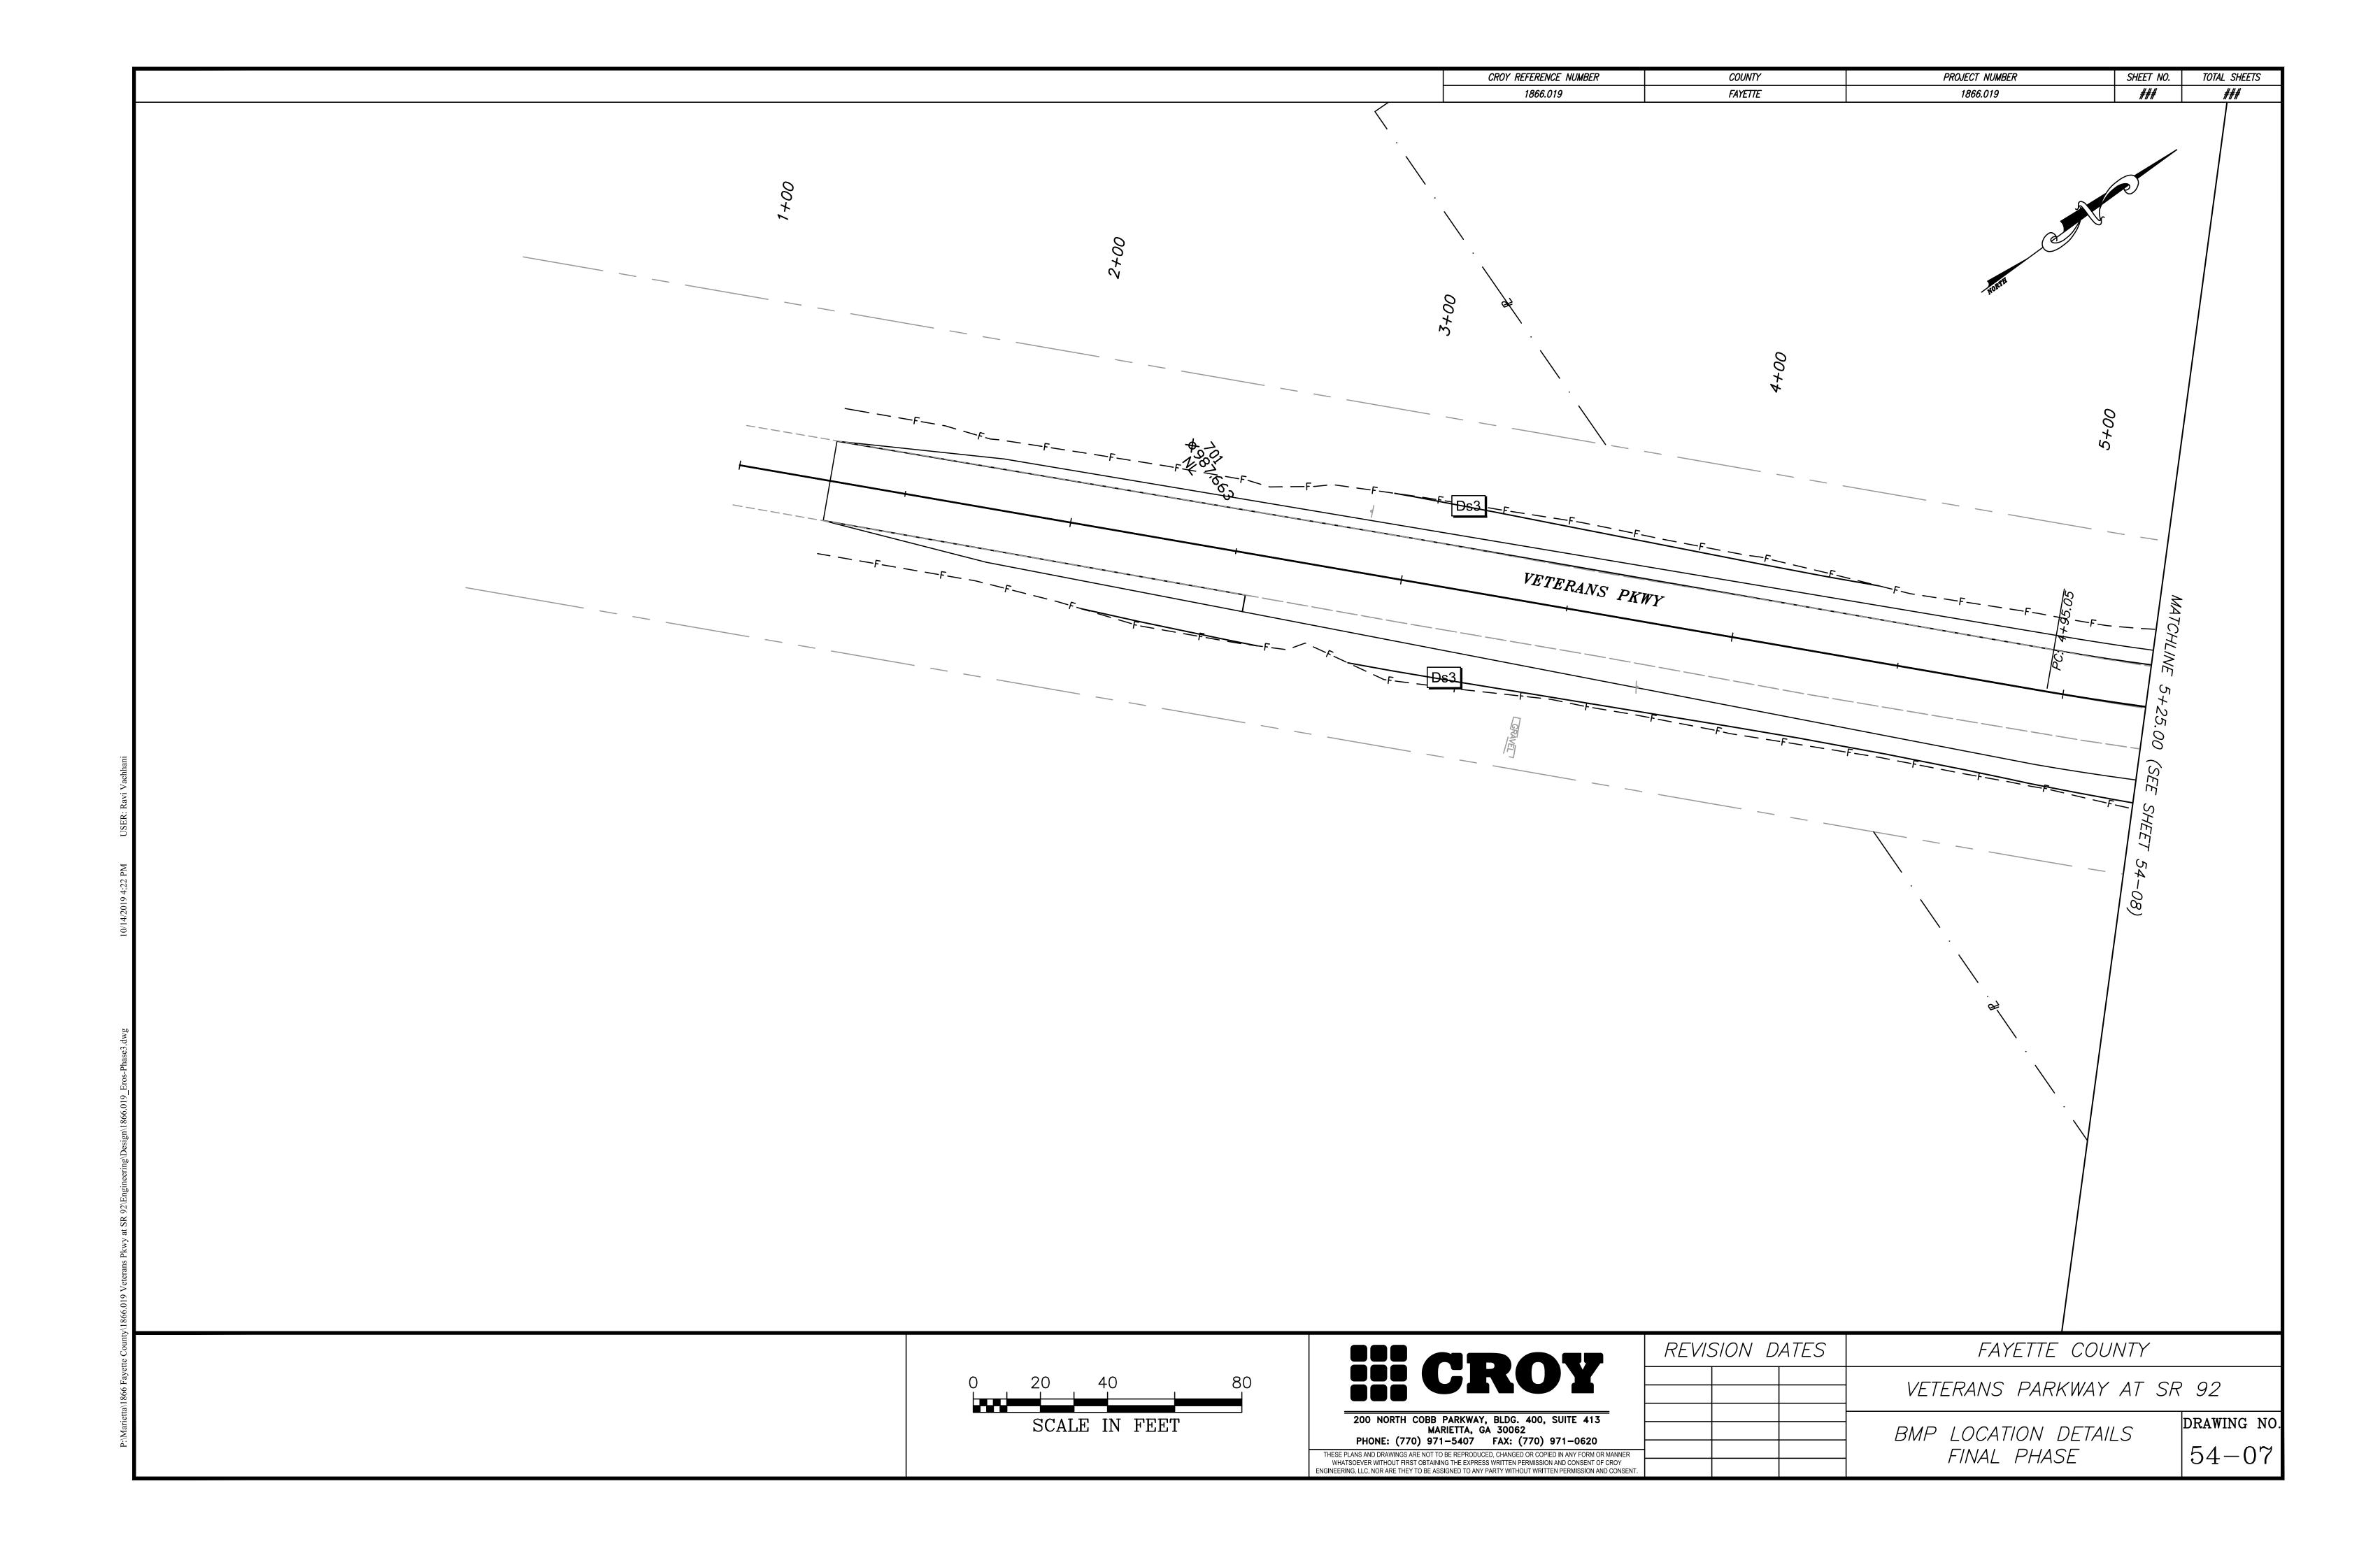

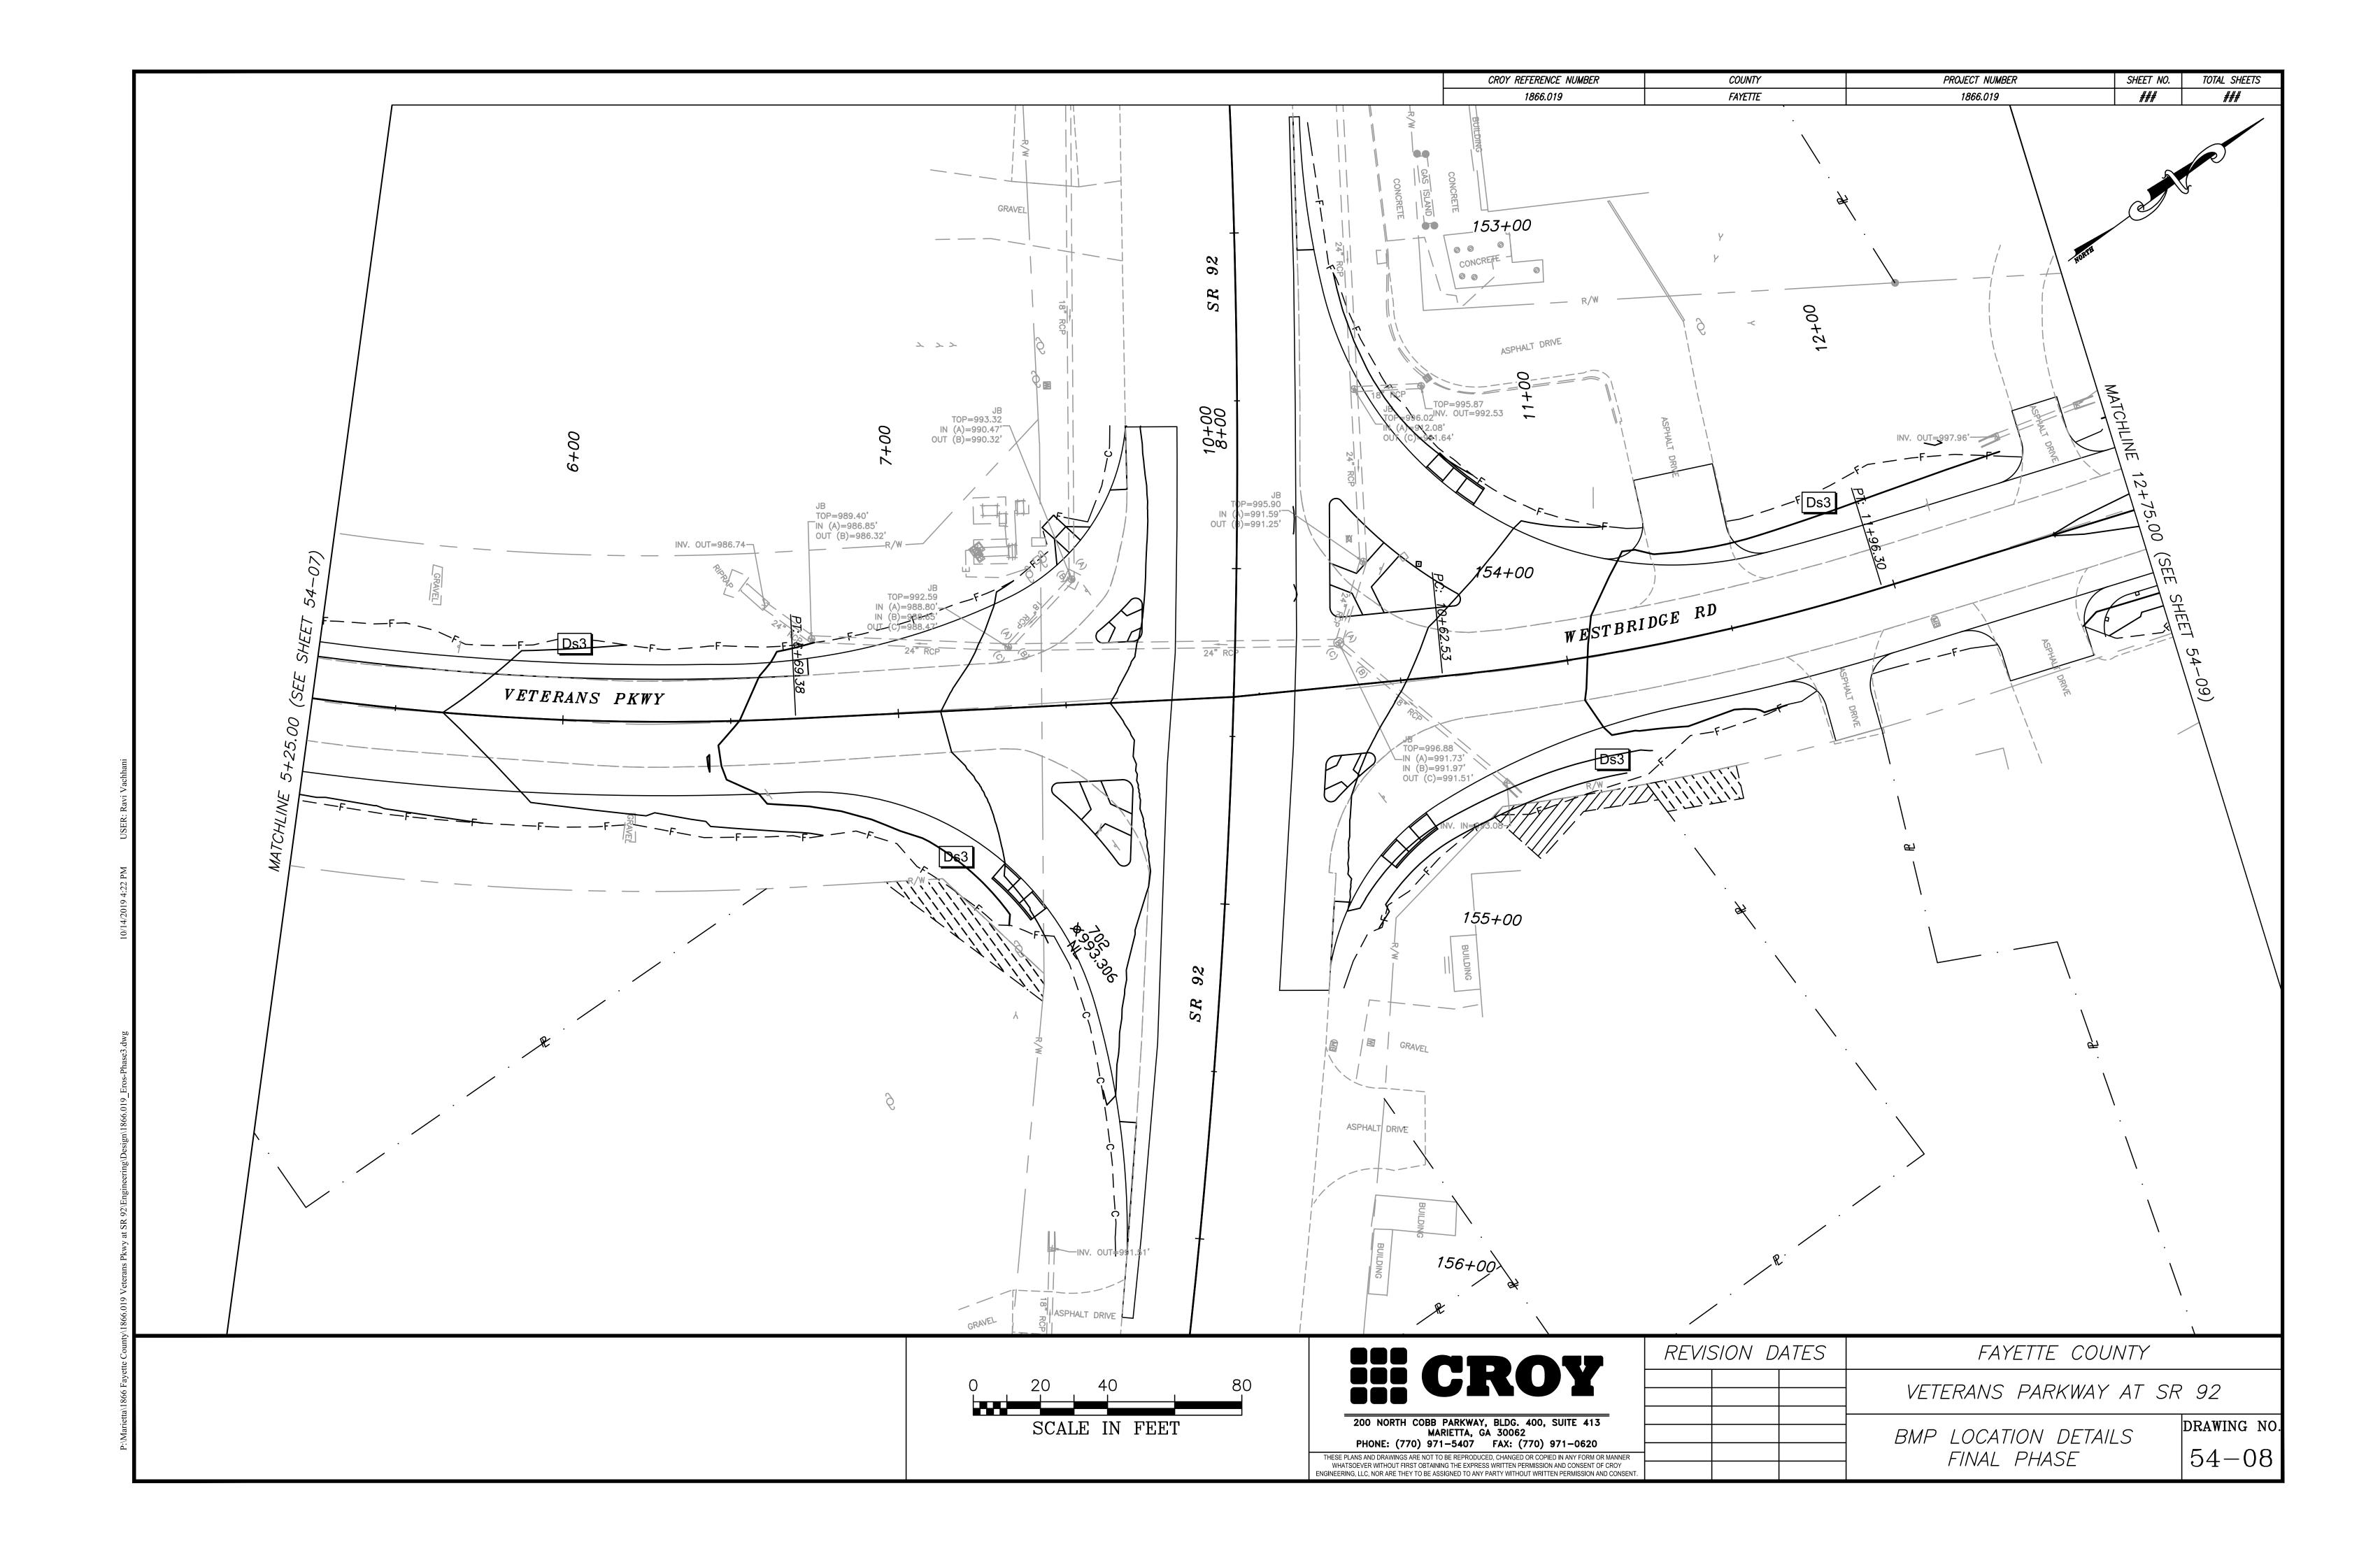

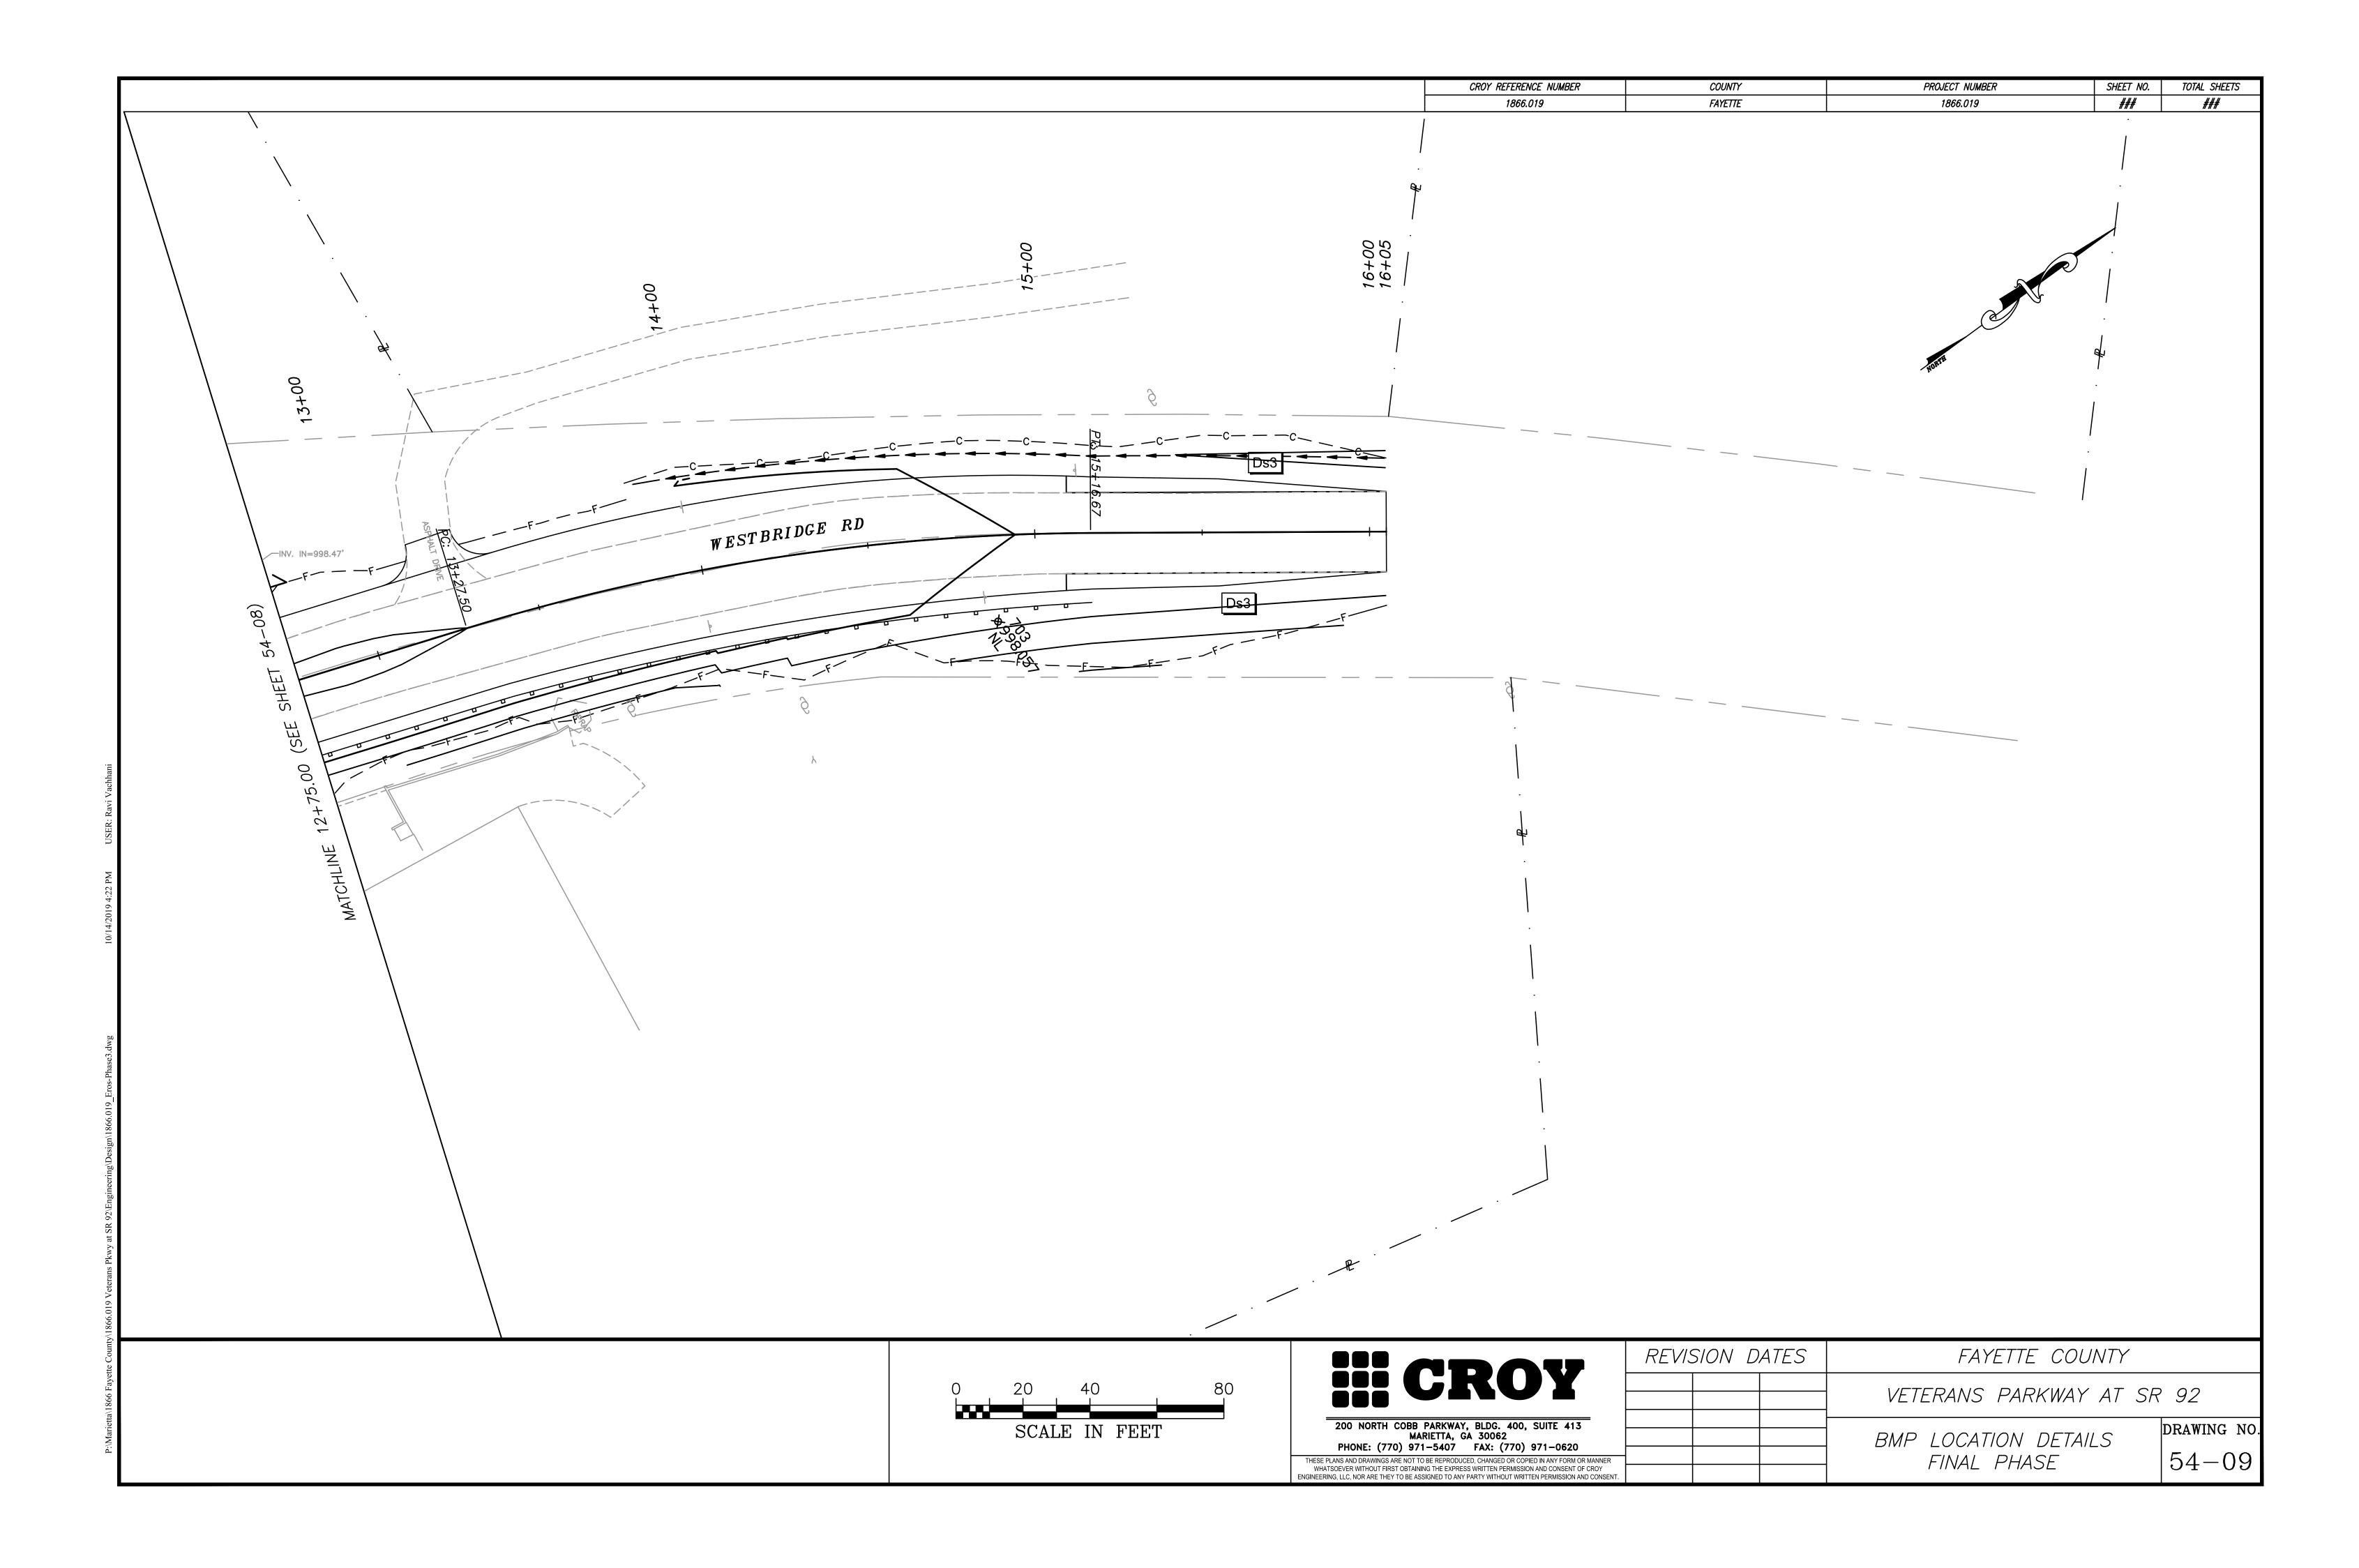

# Ds1 DISTURBED AREA STABILIZATION (WITH MULCHING ONLY)

**SPECIFICATIONS** 

#### **Mulching Without Seeding**

This standard applied to grades or cleared areas where seedings may not have a suitable growing season to produce an erosion retardant cover, but can be stabilized with a mulch cover.

### Site Preparation

1. Grade to permit the use of equipment for applying and anchoring mulch. 2. Install needed erosion control measures as required such as dikes, diversions, berms, terraces

and sediment barriers. 3. Loosen compact soil to a minimum depth of 3 inches.

#### **Mulching Materials**

Select one of the following materials and apply at the depth indicated:

- 1. Dry straw or hay shall be applied at a depth of 2 to 4 inches providing complete soil coverage. One advantage of this material is easy application.
- 2. Wood waste (chips, sawdust or bark) shall be applied at a depth of 2 to 3 inches. Organic material from the clearing stage of development should remain on site, be chipped, and applied as mulch. This method of mulching can greatly reduce erosion control costs.
- 3. Polyethylene film shall be secured over banks or stockpiled soil material for temporary protection This material can be salvaged and reused.

## When mulch is used without seeding, mulch shall be applied to provide full coverage of the exposed

1. Dry straw or hay mulch and wood chips shall be applied uniformly by hand or by mechanical

- 2. If the area will eventually be covered with perennial vegetation, 20-30 pounds of nitrogen per acre
- in addition to the normal amount shall be applied to offset the uptake of nitrogen caused by the decomposition of the organic mulches. 3. Apply polyethylene film on exposed areas.

shall be anchored immediately after application.

#### **Anchoring Mulch**

1. Straw or hay mulch can be pressed into the soil with a disk harrow with the disk set straight or with a special 'packer disk'. Disks may be smooth or serrated and should be 20 inches or more in diameter and 8 to 12 inches apart. The edges of the disk should be dull enough not to cut the mulch but to press it into the soil leaving much of it in an erect position. Straw or hay mulch

Straw or hay mulch spread with special blower-type equipment may be anchored. Tackifiers, binders and hydraulic mulch with tackifier specifically designed for taking straw can be substituted for emulsified asphalt. Please refer to specification **Tackifiers and binders**. Plastic mesh or netting with mesh no larger than one inch by one inch shall be installed according to manufacturer's specifications.

- 2. Netting of the appropriate size shall be used to anchor *wood waste*. Openings of the netting shall not be larger than the average size of the wood waste chips.
- 3. Polyethylene film shall be anchor trenched at the top as well as incrementally as necessary.

# Ds2 DISTURBED AREA STABILIZATION (WITH TEMPORARY SEEDING)

#### SPECIFICATIONS

# **Grading and Shaping**

Excessive water run-off shall be reduced by properly designed and installed erosion control practices such as closed drains, ditches, dikes, diversions, sediment barriers and others. No shaping or grading is required if slopes can be stabilized by hand-seeded vegetation or if hydraulic seeding equipment is to be used.

### Seedbed Preparation

When a hydraulic seeder is used, seedbed preparation is not required. When using conventional or hand-seeding, seedbed preparation is not required if the soil material is loose and not sealed by rainfall.

When soil has been sealed by rainfall or consists of smooth cut slopes, the soil shall be pitted, trenched or otherwise scarified to provide a place for seed to lodge and germinate.

#### Lime and Fertilizer

Agricultural lime is required unless soil tests indicate otherwise. Apply agricultural lime at determined by soil test for pH. Quick acting lime should be incorporated to modify pH during the germination period. Bio stimulants should also be considered when there is less than 3% organic matter in the soil. Graded areas require lime application. Soils must be tested to determine required amounts of fertilizer and amendments. Fertilizer should be applied before land preparation and incorporated with a disk, ripper, or chisel. On slopes too steep for, or inaccessible to equipment, fertilizer shall be hydraulically applied, preferably in the first pass with seed and some hydraulic mulch, then topped with the remaining required application rate.

Select a grass or grass-legume mixture suitable to the area and season of the year. Seed shall be applied uniformly by hand, cyclone seeder, drill, cultipacker-seeder, or hydraulic seeder (slurry including seed and fertilizer). Drill or cultipacker seeders should normally place seed one-quarter to one-half inch deep. Appropriate depth of planting is ten times the seed diameter. Soil should be "raked" lightly to cover seed with soil if seeded by hand. See table below.

Temporary vegetation can, in most cases, be established without the use of mulch provided there is little to no erosion potential. However, the use of mulch can often accelerate and enhance germination and vegetation establishment. Mulch without seeding should be considered for short term protection. Refer to Ds1 - Disturbed Area Stabilization (With Mulching Only).

During times of drought, water shall be applied at a rate not causing runoff and erosion. The soil shall be thoroughly wetted to a depth that will insure germination of the seed. Subsequent applications should be made when needed.

### PLANT, PLANTING RATES, AND PLANTING DATES FOR TEMPORARY COVER OR COMPANION CROPS

SPECIES		DCAST TES PER	PLANTING DATES FOR SOUTHERN PIEDMONT REGION						REMARKS						
	ACRE	1000 SQ. FT.	J		M		_							D	
BARLEY (Horduem vulgare) alone in mixture	144 lbs. 24 lbs.	3.3 lbs. 0.6 lb.	J	F	М	A	М	J	J	A	s	О	N	D	14,000 seed per pound. Winterhardy. Use on productive soils.
LESPEDEZA,ANNUAL (Lespedeza striata) alone in mixture	40 lbs. 10 lbs.	0.9 lb. 0.2 lb.	J	F	М	A	M	J	J	A	s	О	N	D	200,000 seed per pound. May volunteer for several years. Use inoculant EL.
LOVEGRASS, WEEPING (Horduem vulgare) alone in mixture	4 lbs. 2 lbs.	0.1 lb. 0.05 lb.	J	F	<u></u>	A	M	J	J	A	s	o	N	D	1,500,000 seed per pound. May last for several years. Mix with Sericea lespedeza.
MILLET, BROWNTOP (Panicum fascicalatum) alone in mixture	40 lbs. 10 lbs.	0.9 lb. 0.2 lb.	J	F	M	A	M	J	J	A	s	О	N	D	137,000 seed per pound. Quick dense cover. Will provide too much competition in mixtures if seeded at high rates.
MILLET, PEARL (Pennesetum glaucum) alone	50 lbs.	1.1 lb.	J	F	М	 A	M	J	J	A	s	o	N	D	88,000 seed per pound. Quick dense cover. May reach 5 feet in height. Not recommended for mixtures.
OATS (Avena sativa) alone in mixture	128 lbs. 32 lbs.	2.9 lbs. 0.7 lb.	J	F	M	A	M	J	J	A	S	О	N	D	13,000 seed per pound. Use on productive soils. Not as winterhardy as rye or barley.
RYE (Secale cereale) alone in mixture	168 lbs. 28 lbs.	3.9 lbs. 0.6 lb.	J	F	M	A	M	J	J	A	S	О	N	D	18,000 seed per pound. Quick cover. Drought tolerant and winterhardy.
RYEGRASS, ANNUAL (Lolium temulentum) alone	40 lbs.	0.9 lb.	J	F	М	A	М	J	J	A	s	О	N	D	227,000 seed per pound. Dense cover. Very competitive and is <u>not</u> to be used in mixtures.
SUDANGRASS (Sorghum Sudanese) alone	60 lbs.	1.4 lb.	J	F	М	A	M	J	J	A	s	О	N	D	55,000 seed per pound. Good on droughty sites. Not recommended for mixtures.
WHEAT (Triticum Aestivum) alone in mixture	180 lbs. 30 lbs.	4.1 lbs. 0.7 lb.	J	F	М	A	М	J	J	A	s	О	N	D	15,000 seed per pound.

Seedbed preparation may not be required where hydraulic seeding and fertilizing equipment is to be used (but is strongly recommended for any seeding process, when possible). When conventional seeding is to be used, seedbed preparation will be done as follows:

- 1. Tillage, at a minimum, shall adequately loosen the soil to a depth of 4 to 6 inches; alleviate compaction; incorporate lime and fertilizer; smooth and firm the soil; allow for the proper placement of seed, sprigs, or plants; and allow for the anchoring of straw or hay mulch if a disk is to be used.
- 2. Tillage may be done with any suitable equipment. Tillage should be done on the contour where feasible. 4. On slopes too steep for the safe operation of tillage equipment, the soil surface shall be pitted or trenched across the

amount of innoculant recommended by the manufacturer shall be used.

- slope with appropriate hand tools to provide two places 6 to 8 inches apart in which seed may lodge and germinate. hydraulic seeding may also be used. Individual Plants
- 5. Where individual plants are to be set, the soil shall be prepared by excavating holes, opening furrows, or dibble 6. For nursery stock plants, holes shall be large enough to accommodate roots without crowding.

. Where pine seedlings are to be planted, subsoil under the row 36 inches deep on the contour four to six months prior to planting. Subsoiling should be done when the soil is dry, preferably in August or September.

All legume seed shall be inoculated with appropriate nitrogen-fixing bacteria. the innoculant shall be a pure culture prepared specifically for the seed species and used within the dates on the container A mixing medium recommended by the manufacturer shall be used to bond the innoculant to the seed. for conventional seeding, use twice the amount of innoculant recommended by the manufacturer. For hydraulic seeding, four times the

All inoculated seed shall be protected from the sun and high temperatures and shall be planted the same day inoculated. No inoculated seed shall remain in the hydroseeder longer than one hour.

## Mix the seed (innoculated if needed), fertilizer, and wood cellulose or wood pulp fiber mulch with water and apply in a

suitable equipment.

plant shall be set in the hole.

slurry uniformly over the area to be treated. Apply within one hour after the mixture is made. Seeding will be done on a freshly prepared and firmed seedbed. For broadcast planting, use a culti-packer-seeder, drill, rotary seeder, other mechanical seeder, or hand seeding to distribute the seed uniformly over the area to be treated. Cover the seed lightly with 1/8 to 1/4 inch of soil for small seed and 1/2 to 1 inch for large seed when using a cultipacker or other

No-Till Seeding No-till seeding is permissible into annual cover crops when planting is done following maturity of the cover crop or if the temporary cover stand is sparse enough to allow adequate growth of the permanent (perennial) species. No-till seeding shall be done with appropriate no-till seeding equipment, the seed must be uniformly distributed and planted at the proper depth. Individual Plants Shrubs, vines and sprigs may be planted with appropriate planters or hand tools. pine trees shall be planted manually in the subsoil furrow. Each plant shall be set in a manner that will avoid crowding the roots. Nursery stock plants shall be planted at the same depth or slightly deeper than they grew at the nursery. The tips of vines and sprigs must be at or slightly above the ground surface Where individual holes are dug, fertilizer shall be placed in the bottom of the hole, two inches of soil shall be added and the

Mulch is required for all permanent vegetation applications. mulch applied to seeded areas shall achieve 75% to 100% soil cover. When selecting a mulch, design professionals should consider the mulch's functional longevity, vegetation establishment enhancement, and erosion control effectiveness. Select the mulching material from the following and apply as

- 1. Dry straw or dry hay of good quality and free of weed seeds can be used. dry straw shall be applied at the rate of 2 tons per acre. Dry hay shall be applied at a rate of 2 1/2 tons per acre. 2. Wood cellulose mulch or wood pulp fiber shall be used with hydraulic seeding. It shall be applied at the rate of 500
- pounds per acre. Dry straw or dry hay shall be applied (at the rate indicated above) after hydraulic seeding. 3. One thousand pounds of wood cellulose or wood pulp fiber, which includes a tackifier, shall be used with hydraulic seeding on slopes 3/4:1 or steeper. 4. Sericea Lespedeza hay containing mature seed shall be applied at a rate of three tons per acre.
- 5. Pine straw or pine bark shall be applied at a thickness of 3 inches for bedding purposes. other suitable materials in sufficient quantity may be used where ornamentals or other ground covers are planted. This is **NOT** appropriate for 6. When using temporary erosion control blankets or block sod, mulch is not required.
- 7. Bituminous treated roving may be applied on planted areas, slopes, in ditches or dry water- ways to prevent erosion. Bituminous treated roving shall be applied within 24 hours after an area has been planted. Application rates and materials must meet Georgia Department of Transportation specification dispersed when agitated in water. The fibers shall contain a dye to allow visual metering and aid in uniform application

#### Straw or hay mulch will be spread uniformly within 24 hours after seeding and/or planting the mulch may be spread by blower-type spreading equipment, other spreading equipment or by hand. Mulch shall be applied to cover 75% of the soil

Wood cellulose or wood fiber mulch shall be applied uniformly with hydraulic seeding equipment.

## Anchor straw or hay mulch immediately after application by one of the following methods:

specifications.

during seeding.

- 1. Hay and straw mulch shall be pressed into the soil immediately after the mulch is spread. A special "packer disk" or disk harrow with the disks set straight may be used. The disks may be smooth or serrated and should be 20 inches or more in diameter and
- 2. 8 to 12 inches apart. The edges of the disks shall be dull enough to press the mulch into the ground without cutting it, leaving much of it in an erect position. Mulch shall not be plowed into the soil. 3. Synthetic tackifiers, binders or hydraulic mulch specifically designed to tack straw, shall be applied in conjunction with or immediately after the mulch is spread. Synthetic tackifiers shall be mixed and applied according to manufacturer's

specifications. All tackifiers, binders or hydraulic mulch specifically designed to tack straw should be verified nontoxic

through EPA 2021.0 testing. Refer to **Tackifiers-Tac** 4. Rye or wheat can be included with fall and winter plantings to stabilize the mulch. They shall be applied at a rate of one-quarter to one-half bushel per acre. 5. Plastic mesh or netting with mesh no larger than one inch by one inch may be needed to anchor straw or hay mulch on unstable soils and concentrated flow areas. These materials shall be installed and anchored according to manufacturer's

## Mulch is used as a bedding material to conserve moisture and control weeds in nurseries, ornamental beds, around shrubs, and on bare areas on lawns.

4" TO 6" Grass Hay Pine Needles Wood Waste 4" TO 6"

# Irrigation will be applied at a rate that will not cause runoff.

Topdressing will be applied on all temporary and permanent (perennial) species planted alone or in mixtures with other species. Recommended rates of application are listed in table 6-5.1.

- Second Year and Maintenance Fertilization Second year fertilizer rates and maintenance fertilizer rates are listed in table 6-5.1.
- Lime Maintenance Application Apply one ton of agricultural lime every 4 to 6 years or as indicated by soil tests. Soil tests can be conducted to determine more accurate requirements, if desired.

# Mow Sericea Lespedeza only after frost to ensure that the seeds are mature. mow between November and march.

Bermudagrass, Bahia grass and Tall Fescue may be mowed as desired. Maintain at least 6 inches of top growth under any use and management. Moderate use of top growth is beneficial after establishment.

# Exclude traffic until the plants are well established. Because of the quail nesting season, mowing should not take place

# Ds3 DISTURBED AREA STABILIZATION (WITH PERMANENT VEGETATION)

PLANT, PLANTING RATES, AND PLANTING DATES FOR PERMANENT COVER

SPECIES	BROADCAST RATES PER			PLANTING DATES FOR SOUTHERN PIEDMONT REGION										REMARKS		
SI ECIES	PER ACRE	1000 SQ. FT.	J	F	PH M		М( М	J J	T I J	REG	GI S	ON O		D	KEWAKKS	
BAHIA, PENSACOLA Paspalum notatum) alone or w/ temp. cover with other perennials	60 lbs. 30 lbs.	1.4 lb. 0.7 lb.	J		M		M	J	J	A	S	0	N	D D	166,000 seed per pound. Low growing. Sod forming Slow to establish. Plant with a companion crop.	
BAHIA, WILMINGTON Paspalum notatum) alone or w/ temp. cover with other perennials	60 lbs. 30 lbs.	1.4 lb. 0.7 lb.	J	F	М		М	J	J	A	S	o	N	D	Will spread into bermuda pastures and lawns. Mis with Sericea lespedeza or weeping lovegrass.	
BERMUDA, COMMON Cynodon dactylon) alone with other perennials	10 lbs. 6 lbs.	0.2 lb. 0.1 lb.	J	F	М		М	J	J	A	S		N	D	1,787,000 seed per pound. Quick cover. Low growing and sod forming. Full sun. Good for athletic fields.	
BERMUDA, COMMON Cynodon dactylon) with temporary cover	10 lbs.	0.2 lb.													Plant with winter annuals.	
with other perennials	6 lbs.	0.1 lb.	J	F	M	A	M	J	J	A	S	o	N	D	Plant with tall fescue.	
BERMUDA SPRIGS Cynodon dactylon) Coastal, Common, or Tift 44	40 cu. ft.	0.9 cu. ft.	J	F	M	A	М	J	J	A	s	o	N	D	A cubic foot contains approximately 650 sprigs. A bushel contains 1.25 cubic feet or approximately 800 sprigs.	
CENTIPEDE Eremochloa ophiuroides)	Block s	od only	_	E	M		M	т.			c		N	D	Drought tolerant. Full sun or partial shade. Effective adjacent to concrete and in concentrated flow areas. Irrigation is needed until fully established. Do not plant near pastures Winterhardy as far north as Athens an	
CROWNVETECH Coronilla varia) with winter annuals or cool season grasses	15 lbs.	0.3 lb.	J J	F F	M		M	J J	J J	A		0	N	D D	Atlanta.  100,000 seed per pound. Dense growth Drought tolerant and fire resistant. Attractive rose, pink, and white blossoms spring to late fall. Mix with 30 pounds of Tall fescue or 15 pounds or rye. Inoculate seed with M inoculan	
FESCUE, TALL Festuca arundinacea) alone with other perennials	50 lbs. 30 lbs.	1.1 lb. 0.7 lb.	J	F	М			J	J	A	S	0	N	D	227,000 seed per pound. Use alone only on better sites. Not for droughty soils. Mix with perennial lespedezas o crownvetch. Apply topdressing in spring following fall plantings. Not fo heavy use areas or athletic fields.	
ESPEDEZA, SERICA Lespedeza cuneata) scarified unscarified seed-bearing hay	60 lbs. 75 lbs. 3 tons	1.4 lbs. 1.7 lbs. 138 lbs.	J	F	M	A	М	J	J	A	s	0	N	D	350,000 seed per pound. Widely adapted. Low maintenance. Mix with weeping lovegrass, common bermuda, bahia, or tall fescue. Takes 2 to 3 years to become fully established. Excellent on roadbanks. Inoculate seed with EL inoculant.	
ESPEDEZA Lespedeza virgata DC) or Lespedeza cuneata G. Don) scarified unscarified	60 lbs. 75 lbs.	1.4 lbs. 1.7 lbs.	J	F	M	<b>A</b>	М	J	J	A	S	0	N	D	300,000 seed per pound. Height of growth is 18 to 24 inches. Advantageous in urban areas. Spreading-type growth has bronze coloration. Mix with Weeping lovegrass, Common bermuda, bahia, tall fescue or winter annuals. Do not mix with Sericea lespedeza. Slow to develop solid stands. Inoculate seed with EL inoculate.	
ESPEDEZA, SHRUB Lespedeza bicolor) Lespedeza thumbergii) plants	3' 2	3'	J	F	M	A	М	J	J	A		0	N	D	Provide wildlife food and cover.	
OVEGRASS, WEEPING Eragrostis curvula) alone with other perennials	4 lbs. 2 lbs.	0.1 lb. 0.05 lb.	J	F	М	A	М	J	J	A	S	О	N	D	1,500,000 seed per pound. Quick cover. Drought tolerant. Grows well with Sericea lespedeza on roadbanks.	
ANICGRASS, ATLANTIC COASTAL Panicum amarum var. amarulum)	20 lbs.	0.5 lb.	J	F	М	A	М	J	J	A	S	o	N	D	Grows well on coastal sand dunes, borrow areas, and grave pits. Provides winter cover for wildlife. Mix with Sericea lespedeza except on sand dunes	
REED CANARY GRASS Phalaris arundinacea) alone with other perennials	50 lbs. 30 lbs.	1.1 lbs. 0.7 lb.	J	F	М	A	М	J	J	<b>■</b> A	S	0	N	D	Grows similar to tall fescue.	
SUNFLOWER, 'AZTEC' MAXIMILLIAM Helianthus maximiliani)	10 lbs.	0.2 lb.	J	F	М	A	М	J	J	A	s	o	N	D	227,000 seed per pound. Mix with weeping lovegras or other low-growing grasses or legumes.	

### FERTILIZER REQUIREMENTS

TYPE OF SPECIES	YEAR	ANALYSIS OR EQUIVALENT N-P-K	RATE	NITROGEN TOF DRESSING RATE
1. Cool season grasses	First	6-12-12	1500 lbs./ac.	50-100 lbs./ac.
	Second	6-12-12	1000 lbs./ac.	
	Maintenance	10-10-10	400 lbs./ac.	30 lbs./ac.
2. Cool season grasses	First	6-12-12	1500 lbs./ac.	0-50 lbs./ac.
and legumes	Second	0-10-10	1000 lbs./ac.	
-	Maintenance	0-10-10	400 lbs./ac.	
3. Ground covers	First	10-10-10	1300 lbs./ac.	
	Second	10-10-10	1300 lbs./ac.	
	Maintenance	10-10-10	1100 lbs./ac.	
4. Pine seedlings	First	20-10-5	one 21-gram pellet per seedling placed in the closing hole	
5. Shrub Lespedeza	First	0-10-10	700 lbs./ac.	
	Maintenance	0-10-10	700 lbs./ac.	
6. Temporary cover crops seeded alone	First	10-10-10	500 lbs./ac.	30 lbs./ac.
7. Warm season	First	6-12-12	1500 lbs./ac.	50-100 lbs./ac.
grasses	Second	6-12-12	800 lbs./ac.	50-100 lbs./ac.
-	Maintenance	10-10-10	400 lbs./ac.	30 lbs./ac.
8. Warm season	First	6-12-12	1500 lbs./ac.	50 lbs./ac.
grasses and legumes	Second	0-10-10	1000 lbs./ac.	
	Maintenance	0-10-10	400 lbs./ac.	

#### DURABLE SHRUBS AND GROUND COVERS FOR PERMANENT COVER


Common Name	Scientific Name	Mature Height	Plant Spacing	Comments
Albelia	Abelia grandiflora	3-4 ft.	5 ft.	Also a prostrate form 2 feet high. Sun, semi-shade. Semi-evergreen.
Carolina Yellow Jessamine Gelsemium sempervirens		low	3 ft.	Vine. Yellow, trumpet-like flowers. Hardy, one of best vines. Evergreen. Native to Georgia.
Carpet Blue	Ajuga reptans	2-4 in.	3 ft.	Needs good drainage, partial shade. Blue or white flowers. Evergreen.
Bearberry Cotoneaster	Cotoneaster dammeri	2-4 in.	5 ft.	White flowers, red fruit. Sun. Evergreen.
Ground Cover Cotoneaster	Cotoneaster salicifoluis 'Repens'	1-2 ft.	5 ft.	White flowers, red fruit. Sun. Evergreen.
Rock Cotoneaster	Cotoneaster horizontalis	1-2 ft.	5 ft.	Semi-evergreen. Sun.
Virginia Creeper	Parthenocissue quinquefolia	low	3 ft.	Red in fall. Vine. Deciduous. Native to Georgia.
Daylilly	Hemerocallis spp.	2-3 ft.	2 ft.	Many flower colors. Full sun. Very Hardy
English Ivy	Hedera helix	low	3 ft.	Shade only. Climbs.
Compacta Holly	Ilex crenata 'Compacta'	3-4 ft.	5 ft.	Sun, semi-shade.
Chinese Holly	Ilex cornuta 'Rotunda'	3-4 ft.	5 ft.	Very durable. Sun, semi-shade.
Dwarf Burford Holly	Ilex burfordii 'Nana'	5-8 ft.	8 ft.	
Dwarf Yaupon Holly	Ilex vomitoria 'Nana'	3-4 ft.	5 ft.	Very durable, sun, semi-shade.
Repandens Holly	Ilex crenata 'Repandens'	2-3 ft.	5 ft.	Sun, semi-shade.
Andorra Juniper	Juniperus horizontalis 'Plumosa'	2-3 ft.	5 ft.	Excellent for slopes. Sun.
Andorra Compacta Juniper	Juniperus horizontalis 'Plumosa compacta'	1-2 ft.	5 ft.	More compact than andora.
Blue Chip Juniper	Juniperus horizontalis 'Blue Chip'	8-10 in.	4 ft.	
Blue Rug Juniper	Juniperus horizontalis 'Wiltonii'	4-6 in.	3 ft.	Very low. Sun.
Parsons Juniper	Juniperus davurica 'Expansa' (Squamata Parsoni)	18-24 in.	5 ft.	One of the best, good winter cover.
Pfitzer Juniper	Juniperus chinensis 'Pfitzerana'	6-8 ft.	6 ft.	Needs room.
Prince of Wales Juniper	Juniperus horizontalis 'Prince of Wales'	8-10 in.	4 ft.	Feathery appearance.
Sargent Juniper	Juniperus chinensis 'Sargentii'	1-2 ft.	5 ft.	Full sun. Needs good drainage. Good winter color.
Shore Juniper	Juniperus conferta	2-3 ft.	5 ft.	Emerald Sea or Blue Pacific cultivars are good.
Liriope	Liriope muscari	8-10 in.	3 ft.	
Creeping Liriope	Liriope spicata	10-12 in.	1 ft.	Spreads by runners.
Big Leaf Periwinkle	Vinca major	12-15 in.	4 ft.	Lilac flowers in spring. Semi-shade.
Common Periwinkle	Vinca minor	5-6 in.	4 ft.	Lavender-blue flowers in spring. Semi-shade.
Cherokee Rose	Rosa laevigata	2 ft.	5 ft.	Rampant grower. Not for restricted space
Memoria Rose	Rosa weuchuriana	2 ft.	5 ft.	Rampant grower.
St. Johnswort	Hypericum calycenum	8-12 in.	3 ft.	Semi-shade.
Anthony Waterer Spirea	Spirea bumalda	3-4 ft.	5 ft.	Sun.
Thunberg Spirea	Spirea thinbergii	3-4 ft.	5 ft.	Sun.


200 NORTH COBB PARKWAY, BLDG. 400, SUITE 413 MARIETTA, GA 30062 PHONE: (770) 971-5407 FAX: (770) 971-0620 THESE PLANS AND DRAWINGS ARE NOT TO BE REPRODUCED. CHANGED OR COPIED IN ANY FORM OR MANNER WHATSOEVER WITHOUT FIRST OBTAINING THE EXPRESS WRITTEN PERMISSION AND CONSENT OF CROY


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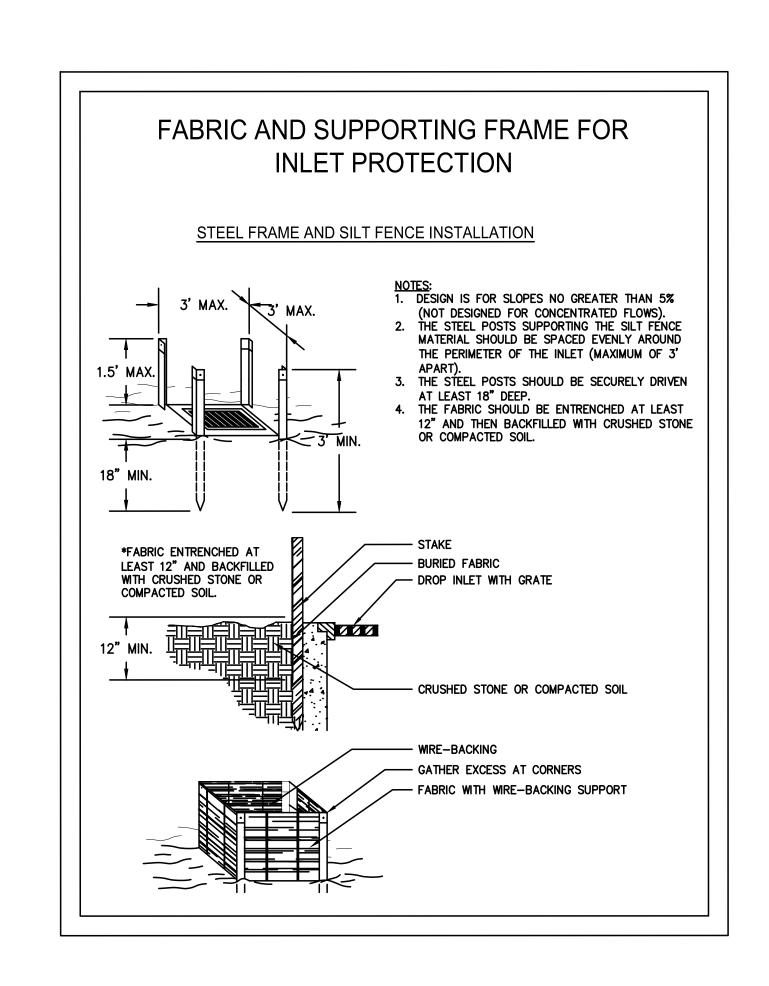
REVIS	ION D.	ATES	FAYETTE COUNTY
			VETERANS PARKWAY AT SR 92
			ESPCP CONSTRUCTION DETAILS 56-01






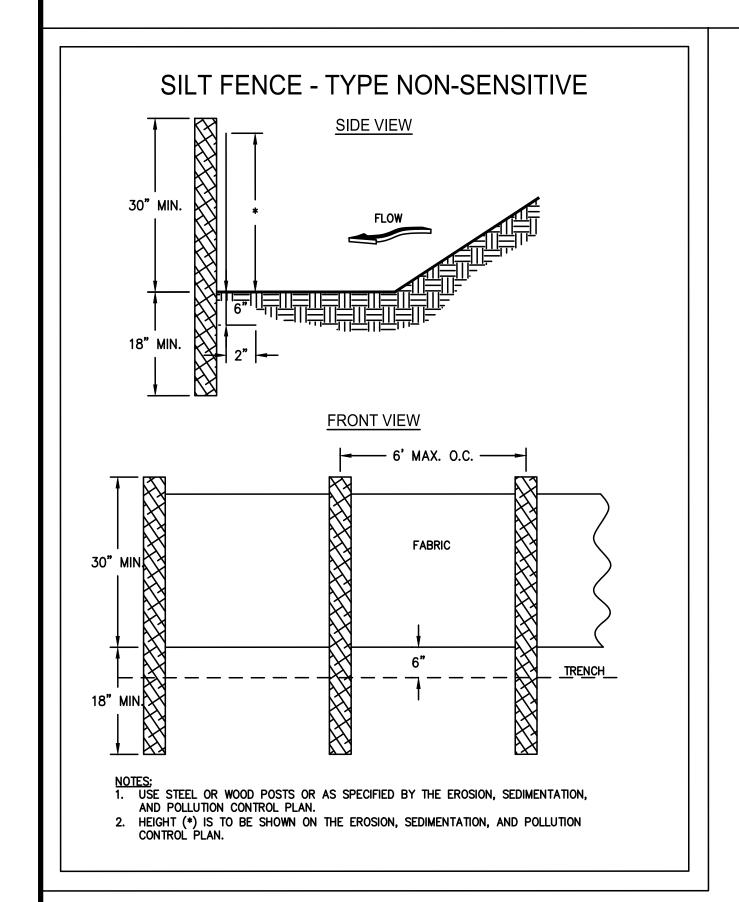

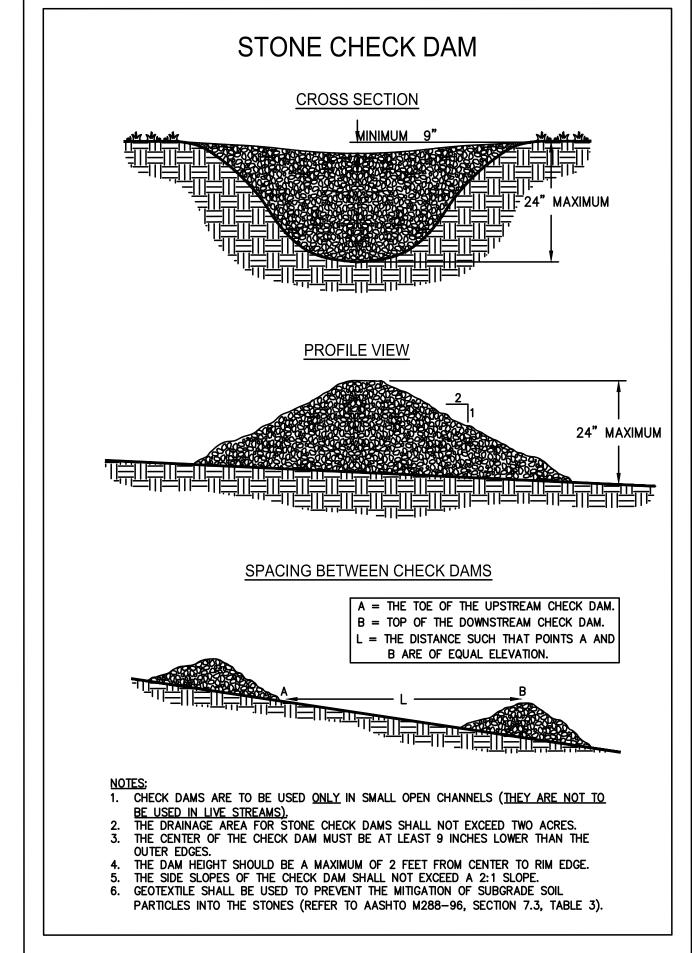

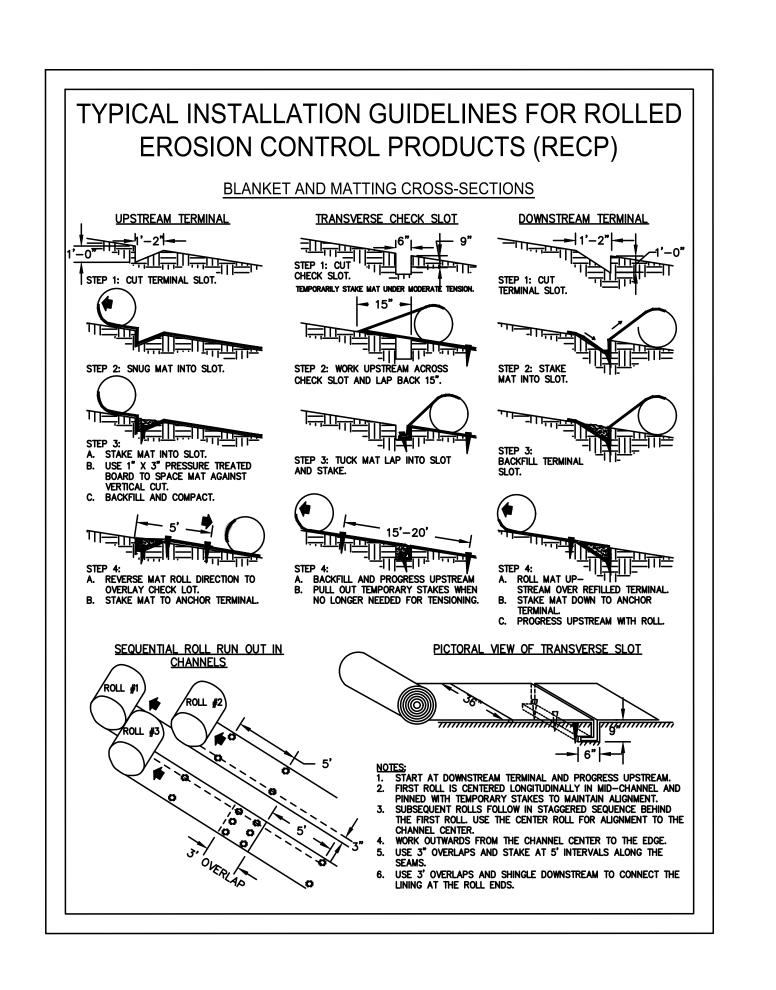

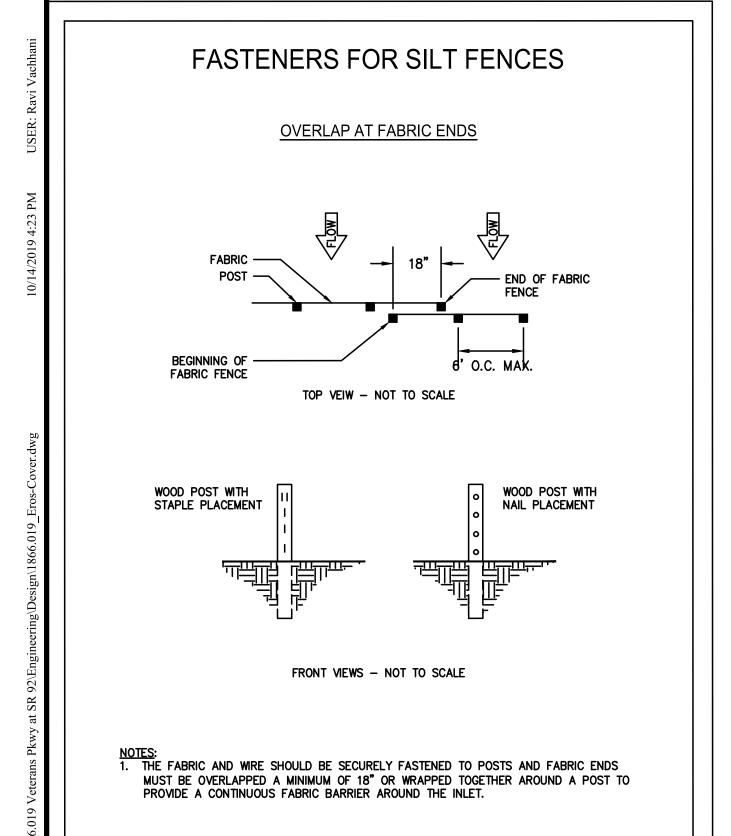



	REVIS	SION D	ATES	FAYETTE COUNTY					
iii CROY				VETERANS PARKWAY AT SR 92	92				
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200 NORTH COBB PARKWAY, BLDG. 400, SUITE 413  MARIETTA, GA 30062  PHONE: (770) 971-5407 FAX: (770) 971-0620				DRAWING	N				
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ENGINEERING, LLC, NOR ARE THEY TO BE ASSIGNED TO ANY PARTY WITHOUT WRITTEN PERMISSION AND CONSENT.									

PROJECT NO. 1866.019

STATE OR COUNTY LINE

CITY LIMIT LINE.

LAND LOT LINE.

PROPERTY LINE.

SURVEY OR BASE LINE.

EXISTING.

REQUIRED.

LIMIT OF ACCESS.

REQD R/W & LIMIT OF ACCESS.

REQD R/W & LIMIT OF ACCESS.

RAILROAD.

POWER LINE.

TELEPHONE LINE.

POWER POLES.

PROJECT NUMBER

1866.019

*FAYETTE* 

SHEET NO. TOTAL SHEETS

###

NOT TO SCALE

THIS PROJECT HAS BEEN PREPARED

USING THE HORIZONTAL GEORGIA

COORDINATE SYSTEM OF 1984 (NAD

1983)/94 WEST ZONE, AND THE NORTH

AMERICAN VERTICAL DATUM (NAVD) OF 1988.

FUNCTIONAL CLASS: MINOR ARTERIAL

THIS PROJECT IS 100 % IN FAYETTE COUNTY IN CONG. DIST. NO. 13TH.

LAND LOTS: 256 LAND DISTRICT: 13 GMD: ###

NOTE

ALL REFERENCES IN THIS DOCUMENT, WHICH INCLUDES ALL PAPERS, WRITINGS, DOCUMENTS, DRAWINGS, OR PHOTOGRAPHS USED, OR TO BE USED IN CONNECTION

PROJECT LOCATION

WITH THIS DOCUMENT, TO "STATE HIGHWAY DEPARTMENT OF GEORGIA", "STATE HIGHWAY DEPARTMENT", GEORGIA STATE HIGHWAY DEPARTMENT", "HIGHWAY DEPARTMENT", OR "DEPARTMENT" WHEN THE CONTEXT THEREOF MEANS THE STATE HIGHWAY DEPARTMENT OF GEORGIA, AND SHALL BE DEEMED TO MEAN THE DEPARTMENT OF TRANSPORTATION.

NOTE:

PROJECT TO BE CONSTUCTED AS PER GEORGIA DEPARTMENT OF TRANSPORTATION STANDARD SPECIFICATIONS, 2013 EDITION, AS APPROVED BY THE FEDERAL HIGHWAY ADMINISTRATION AND MODIFIED BY CONTRACT DOCUMENTS.

THE DATA, TOGETHER WITH ALL OTHER INFORMATION SHOWN ON THESE PLANS OR IN ANYWAY INDICATED THEREBY, WHETHER BY DRAWINGS OR NOTES, OR IN ANY OTHER MANNER, ARE BASED UPON FIELD INVESTIGATIONS AND ARE BELIEVED TO BE INDICATIVE OF ACTUAL CONDITIONS. HOWEVER, THE SAME ARE SHOWN AS INFORMATION ONLY, ARE NOT GUARANTEED, AND DO NOT BIND THE DEPARTMENT OF TRANSPORTATION IN ANY WAY. THE ATTENTION OF BIDDER IS SPECIFICALLY DIRECTED TO SUBSECTIONS 102.04, 102.05, AND 104.03 OF THE SPECIFICATIONS.

iii CROY

200 NORTH COBB PARKWAY, BLDG. 400, SUITE 413
MARIETTA, GA 30062
PHONE: (770) 971-5407 FAX: (770) 971-0620

MILES 0.25 0.00 0.25 0.00 0.25

LENGTH OF PROJECT

NET LENGTH OF ROADWAY

NET LENGTH OF BRIDGES

NET LENGTH OF PROJECT

NET LENGTH OF EXCEPTIONS

GROSS LENGTH OF PROJECT

80 160 320 SCALE IN FEET PLANS PREPARED BY: CHRIS RIDEOUT, P.E.

DESIGN

PLANS COMPLETED: 07/26/2019

REVISIONS	
09/05/2019	CHANGED PARCEL 002 EASEMENT
	DRAWING No.

60-00

