
CIVIL CONSTRUCTION DOCUMENTS FOR

FAYETTE COUNTY DOWNING COURT - CULVERT REPLACEMENT

LAND LOT 169, 5TH DISTRICT, FAYETTE COUNTY, GA.
NOVEMBER 30, 2022
100% DESIGN SUBMITTAL
COUNTY PROJECT NUMBER: 19SBQ



95% DESIGN

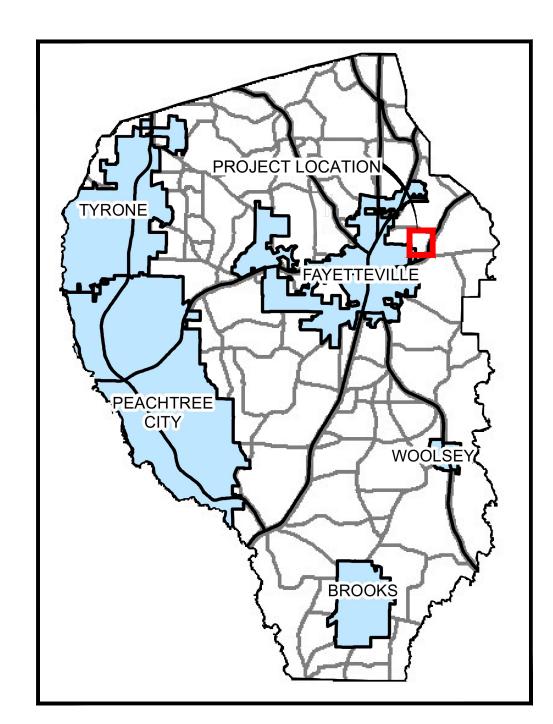

VICINITY MAP
SCALE: NTS

В

NA

		UTILITY NOTIFICATION/RELOCATION CHECKBOX		I
UTILITY COMPANY	PLAN PHASE	CONTACT	DATE NOTIFIED	UTILITY RESPONSE
	35% DESIGN	MFLOYD@SOUTHERNCO.COM	12/9/2021	NO RESPONSE
SOUTHERN COMPANY	65% DESIGN	WCBRITTI@SOUTHERNCO.COM	3/11/2022	NO RESPONSE
COMI 7 II VI	95% DESIGN	X2KSTEPH@SOUTHERNCO.COM	7/27/2022	NO RESPONSE
FAYETTE COUNTY	35% DESIGN		12/9/2021	NO RESPONSE
WATER SYSTEM	65% DESIGN	JAMES ROSSER (JROSSER@FAYETTECOUNTYGA.GOV)	3/11/2022	NO RESPONSE
(FCWS)	95% DESIGN		2/28/2023	RELOCATION
	35% DESIGN	REGINALD ARNEY (REGINALD_ARNEY@COMCAST.COM)	12/9/2021	NO RESPONSE
COMCAST	65% DESIGN		3/11/2022	NO RESPONSE
	95% DESIGN		7/27/2022	NO RESPONSE
	35% DESIGN		12/9/2021	NO RESPONSE
COWETA-FAYETTE EMC	65% DESIGN	STEVE JONES (STJONES@UTILITY.ORG)	3/11/2022	NO RESPONSE
LIVIO	95% DESIGN		7/27/2022	NO RESPONSE
	35% DESIGN		12/9/2021	NO RESPONSE
ATT	65% DESIGN	ANDRE WALTON AW9750@ATT.COM	3/11/2022	NO RESPONSE
	95% DESIGN	7.0000711.00W	7/27/2022	NO RESPONSE
	35% DESIGN		12/9/2021	NO RESPONSE
ZAYO	65% DESIGN	ZAYOGEORGIARELOCATIONS@COBBFENDLEY.COM	5/31/2022	NO FACILITIES LETTER RECEIVED
	050/ DE01011			

CLIENT INFO	ORMATION
OWNER CONTACT (24-HR): PHIL MALLON PHONE (770) 313-9855 publicworks@FayetteCountyGA.GOV	CLIENT INFORMATION: FAYETTE COUNTY ENVIRONMENTAL MANAGEMENT 140 STONEWALL AVE. W., SUITE 203, FAYETTEVILLE, GA. 30214
CIVIL DESI	GN TEAM
PROJECT MANAGER: DAVID MORGAN, P.E. MorganD@pondco.com CIVIL ENGINEER: DAVID MORGAN, P.E.	POND AND COMPANY 3500 PARKWAY LANE SUITE 500 PEACHTREE CORNERS, GA 30092 PHONE (678) 336-7740 FAX (678) 336-7744 WEB: www.pondco.com

IT IS THE OWNER'S/DEVELOPER'S RESPONSIBILITY TO BE IN COMPLIANCE WITH APPLICABLE NATIONAL POLLUTION DISCHARGE ELIMINATION SYSTEM (NPDES) PERMIT AND CLEAN WATER ACT REQUIREMENTS.

PROJECT DESCRIPTION:

THE PROJECT CONSISTS OF REMOVING THE EXISTING DETERIORATED 30-INCH DIAMETER CMP CULVERT. THE CULVERT IS TO BE REPLACED WITH A 40 LINEAR FOOT 30-INCH DIAMETER RCP CULVERT.

PROJECT INFORMATION:

DISTURBED AREA: 0.08 ACRES

IMPERVIOUS SURFACE AREA: 0.01 ACRES

REFERENCE DATUM:

HORIZONTAL: NAD 1983 (2011) - STATE PLANE COORDINATE SYSTEM

OF GEORGIA - WEST ZONE.

VERTICAL: NAVD 1988.

PROJECT SPECIFICATION:

THE CONTRACTOR SHALL REFER TO AND USE THE SUPPLIED COUNTY PROJECT SPECIFICATIONS. FOR OTHER APPLICABLE STANDARDS OR SPECIFICATIONS, CONTRACTOR TO USE THE CURRENT GDOT APPROVED STANDARD SPECIFICATION CONSTRUCTION OF TRANSPORTATION SYSTEM DOCUMENT FOR THIS PROJECT.

CIVIL INDEX						
SHEET NUMBER	SHEET TITLE					
G-001	CIVIL COVER SHEET					
C-001	LEGEND AND ABBREVIATIONS					
C-002	CIVIL GENERAL NOTES					
V-001	TOPOGRAPHIC SURVEY					
CD101	CIVIL SITE DEMOLITION PLAN					
CG101	SITE AND GRADING PLAN					
CG201	CULVERT PROFILE					
CE001	EROSION AND SEDIMENT CONTROL NOTES					
CE002	EROSION AND SEDIMENT CONTROL NOTES					
CE003	EROSION AND SEDIMENT CONTROL NOTES					
CE101	EROSION AND SEDIMENT CONTROL PLAN INITIAL PHASE					
CE201	EROSION AND SEDIMENT CONTROL PLAN FINAL PHASE					
CE501	EROSION AND SEDIMENT CONTROL DETAILS					
CE502	EROSION AND SEDIMENT CONTROL DETAILS					
CE503	EROSION AND SEDIMENT CONTROL DETAILS					
C-501	CONSTRUCTION DETAILS					

3500 Parkway Lane
Suite 500
Peachtree Corners
Georgia 30092
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EOR/AOR SEAL

GEORGISTER

No. 27428

PROFESSIONAL

FAYETTE COUNTY

PROJECT NAME

DOWNING

COURT CULVERT REPLACEMENT

FAYETTE COUNTY, GA

DRAWING ISSUE

2/12/2022

0% DESIGN PLANS

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DESIGNED BY: MDW

DRAWN BY: MDW

CHECKED BY: DMM/MDM

SUBMITTED BY: DMM

DATE: SEPTEMBER 1, 2022

PROJECT#

SHEET TITLE

CIVIL COVER SHEET

SHEET NUMBER

G-001

SHEET 1 OF 16

ORIGINAL SHEET SIZE:
22" X 34"

LATL

LAV

LATERAL

LAVATORY

CIVIL LEGEND

3

PROPOSED ITEM DESCRIPTION $_{\perp}$ 267.54 **SPOT ELEVATION** CONSTRUCTION LIMITS DOMESTIC WATER FIRE WATER **VALVE** FIRE HYDRANT SANITARY SEWER ——SS———SS—— $(\hat{\mathbb{S}})$ SANITARY SEWER MANHOLE

STORM DRAIN

DROP INLET

HEADWALL

FENCE

PROPOSED CONTOUR MAJOR PROPOSED CONTOUR MINOR

SANITARY SEWER CLEANOUT



NORTH ARROW

TREE PROTECTION FENCE

UNKNOWN UTILITY

EXISTING ELECTRICAL OVERHEAD

EXISTING COMMUNICATION LINE OVERHEAD

GUARD RAIL




BENCHMARK


HATCHING LEGEND



ASPHALT PAVEMENT SURFACE

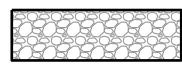


HEAVY DUTY GRAVEL

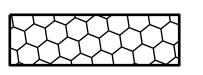

RIP RAP

REFERENCE SYMBOLS

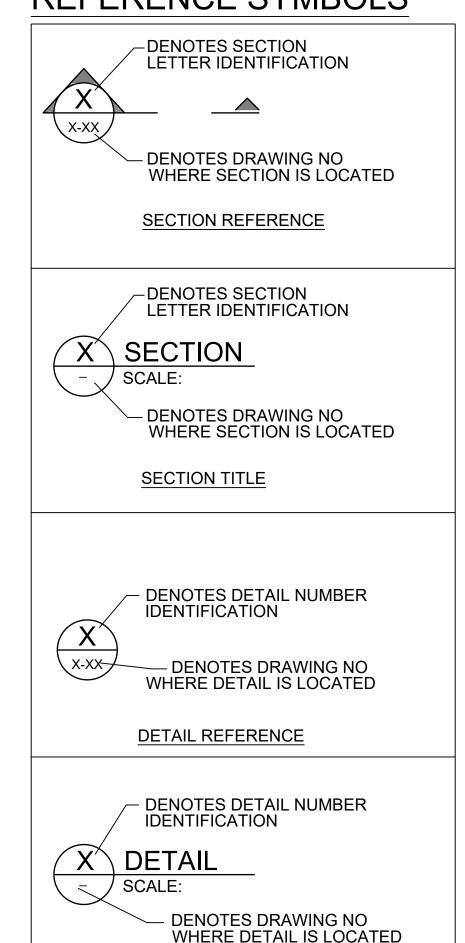

NOTE:

NOT ALL ABBREVIATIONS SHOWN WILL BE USED ON THIS PROJECT.

DETAIL TITLE

SHEET NAMING CONVENTION

C-001 2 DIGIT DESCIPLINE DESIGNATOR (IF ONLY ONE LETTER IS USED, THE SECOND LETTER IS REPLACED WITH A DASH "-" AS A PLACEHOLDER)** -1 DIGIT SHEET TYPE DESIGNATOR 0 - GENERAL 1 - PLANS 2 - PROFILES 3 - SECTIONS 4 - ENLARGED PLANS

L 2 DIGIT SEQUENTIAL # (01-99) (FIRST DIGIT INDICATES PLAN TYPE. SECOND DIGIT INDICATES FLOOR)

PROJECT CONTACTS:

6 - SCHEDULES AND DIAGRAMS

9 - 3D VIEWS (ISO, PERSPECTIVES,

5 - DETAILS

PHOTOS)

7 - USER DEFINED

8 - USER DEFINED

CIVIL ENGINEER FOR THIS PROJECT IS: POND & COMPANY 3500 PARKWAY LANE, SUITE 500 PEACHTREE CORNERS, GA 30092 P: (678) 336.7740 CONTACT: DAVID MORGAN, P.E.

SURVEYOR FOR THIS PROJECT IS: GEOSURVEY, LTD. 1660 BARNES MILL ROAD MARIETTA, GA 30062 P: (770) 795.9900 CONTACT: BRADLEY D. CASH

3500 Parkway Land Suite 500 Peachtree Corners Georgia 30092

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CLIENT INFORMATION

FAYETTE COUNTY

140 STONEWALL AVE W, STE 203 FAYETTEVILLE, GA. 30214

PROJECT NAME

DOWNING COURT **CULVERT** REPLACEMENT

FAYETTE COUNTY, GA

DRAWING ISSUE

MDW **DESIGNED BY:** DRAWN BY: DMM/MDM CHECKED BY: SUBMITTED BY: DATE: SEPTEMBER 1, 2022 1210495 PROJECT#

SHEET TITLE

LEGEND AND **ABBREVIATIONS**

SHEET NUMBER

C-001

SHEET 2 OF 16

- 2. ALL LABOR, MATERIALS, AND METHODS OF CONSTRUCTION SHALL BE IN STRICT ACCORDANCE WITH THE MINIMUM ENGINEERING AND CONSTRUCTION STANDARDS ADOPTED BY GEORGIA DEPARTMENT OF TRANSPORTATION STANDARDS AND SPECIFICATIONS AND FAYETTE COUNTY STANDARDS. WHERE CONFLICTS OR OMISSIONS EXIST. FAYETTE COUNTY STANDARDS SHALL DICTATE. SUBSTITUTIONS AND DEVIATION FROM PLANS AND SPECIFICATIONS SHALL BE PERMITTED ONLY WHEN WRITTEN APPROVAL HAS BEEN ISSUED BY THE ENGINEER.
- 3. SHOP DRAWINGS OF ALL MATERIALS BEING USED SHALL BE SUBMITTED TO THE ENGINEER FOR APPROVAL PRIOR TO
- 4. ALL MATERIALS AND CONSTRUCTION TO BE IN ACCORDANCE WITH THE GEORGIA DEPARTMENT OF TRANSPORTATION STANDARDS AND SPECIFICATIONS AND FAYETTE COUNTY DEVELOPMENT REGULATIONS, LATEST EDITION, UNLESS OTHERWISE WAIVED.
- 5. IT WILL BE THE RESPONSIBILITY OF THE CONTRACTOR TO ENSURE THAT ALL REQUIRED PERMITS ARE OBTAINED AND IN HAND BEFORE BEGINNING ANY CONSTRUCTION. NO CONSTRUCTION OR FABRICATION OF ANY ITEM SHALL BEGIN UNTIL THE CONTRACTOR HAS RECEIVED ALL PLANS AND ANY OTHER DOCUMENTATION FROM ALL OF THE PERMITTING AND ANY OTHER REGULATORY AUTHORITIES. ANY PENALTIES, STOP WORK ORDERS OR ADDITIONAL WORK RESULTING FROM THE CONTRACTOR BEING IN VIOLATION OF THE REQUIREMENTS ABOVE, SHALL BE FULLY BORNE BY THE CONTRACTOR.
- THE LOCATION OF ALL EXISTING UTILITIES AND STORM DRAINAGE SHOWN ON THE PLANS HAVE BEEN DETERMINED FROM THE BEST INFORMATION AVAILABLE AND ARE GIVEN FOR THE CONVENIENCE OF THE CONTRACTOR. THE ENGINEER ASSUMES NO RESPONSIBILITY FOR INACCURACY. PRIOR TO THE START OF ANY CONSTRUCTION ACTIVITY IT SHALL BE THE CONTRACTOR'S RESPONSIBILITY TO NOTIFY THE VARIOUS UTILITIES AND TO MAKE THE NECESSARY ARRANGEMENTS FOR ANY RELOCATION OF THESE UTILITIES WITH THE OWNER OF THE UTILITY. THE CONTRACTOR SHALL EXERCISE CAUTION WHEN CROSSING UNDERGROUND UTILITIES, WHETHER SHOWN ON THE PLAN OR LOCATED BY THE UTILITY COMPANY. ALL UTILITIES WHICH INTERFERE WITH THE PROPOSED CONSTRUCTION SHALL BE BROUGHT TO THE ATTENTION OF THE ENGINEER FIRST. ANY FEES ASSOCIATED WITH UTILITY RELOCATIONS SHALL BE BORNE IN ACCORDANCE WITH RESPECTIVE UTILITY COMPANY STANDARDS. IT IS REQUESTED UTILITY COMPANIES MOVE THEIR PARTICULAR UTILITIES. ANY DELAY OR INCONVENIENCE CAUSED TO THE CONTRACTOR BY THE RELOCATION OF THE VARIOUS UTILITIES SHALL BE INCIDENTAL TO THE CONTRACT AND NO EXTRA COMPENSATION WILL BE ALLOWED. DIAL 811 BEFORE DIGGING OR CALL 800-282-7411.
- 7. THE CONTRACTOR SHALL SCHEDULE A PRE-CONSTRUCTION MEETING TO BE HELD BETWEEN FAYETTE COUNTY, UTILITIES, ENGINEER OF RECORD. CONTRACTOR AND ANY SUBCONTRACTOR PRIOR TO COMMENCEMENT OF CONSTRUCTION.
- THE SEQUENCE OF CONSTRUCTION SHALL BE SUCH THAT ALL UNDERGROUND INSTALLATIONS OF EVERY KIND, INCLUDING LANDSCAPE SPRINKLERS, SHALL BE PLACED BENEATH THE PAVEMENT AND ITS EDGES PRIOR TO THE CONSTRUCTION OF THE PAVEMENT. THE PAVEMENT SHALL NOT BE CUT WITHOUT PRIOR APPROVAL OF THE ENGINEER.
- 9. THE CONTRACTOR SHALL NOTIFY THE ENGINEER AT LEAST 48 HOURS PRIOR TO BEGINNING CONSTRUCTION AND AT LEAST 48 HOURS HOURS BEFORE REQUIRED INSPECTION ON EACH AND EVERY PHASE OF WORK. THE CONTRACTOR SHALL NOTIFY THE ENGINEER A MINIMUM OF 48 HOURS NOTICE PRIOR TO ANY SCHEDULED TESTING. NO PRESSURE TESTING, OR FINAL TESTING WILL BE ACCEPTED UNLESS WITNESSED BY THE ENGINEER'S REPRESENTATIVE. THE CONTRACTOR IS REQUIRED TO NOTIFY 48 HOURS TO FAYETTE COUNTY FOR PROOF ROLL, OF GAB PLACEMENT
- 10. ALL CONTRACTORS, FAYETTE COUNTY REPRESENTATIVES, AND UTILITY COMPANIES ARE RESPONSIBLE FOR THEIR RESPECTIVE SURVEYING AND LAYOUT FROM BENCHMARK PROVIDED ON CONSTRUCTION PLANS. ANY SURVEY MONUMENTATION DISTURBED DURING CONSTRUCTION SHALL BE REPLACED UPON COMPLETION OF THE WORK BY A
- 11. THE CONTRACTOR SHALL BE RESPONSIBLE FOR PREVENTING ANY CONSTRUCTION ACTIVITIES FROM TAKING PLACE OUTSIDE OF THE LIMITS OF CONSTRUCTION SHOWN ON THE PLANS. ANY ON-SITE OR OFFSITE AREAS DISTURBED SHALL BE RESTORED TO ORIGINAL CONDITION OR BETTER.
- 12. THE CONTRACTOR SHALL MAINTAIN A CURRENT SET OF CONSTRUCTION PLANS AND ALL PERMITS ON THE JOB SITE DURING ALL PHASES OF CONSTRUCTION. THE CONTRACTOR SHALL PROVIDE TWO (2) SETS OF RECORD DRAWINGS TO THE ENGINEER OF RECORD WITHIN TWO (2) WEEKS AFTER CONSTRUCTION HAS BEEN COMPLETED ON EACH PHASE
- 13. TOPOGRAPHIC INFORMATION SHOWN ON THESE PLANS WAS TAKEN FROM SURVEY PROVIDED BY: GEOSURVEY, LTD., DATED: 10-14-2021.
- 14. ANY CONSTRUCTION BEYOND THE RIGHT-OF-WAY AND/OR ESTABLISHED EASEMENT LINES, ONTO ADJACENT PROPERTY, REQUIRES ADJACENT PROPERTY OWNER PERMISSION AND NECESSARY EASEMENTS PRIOR TO PERFORMING ANY WORK. THE CONTRACTOR IS TO VERIFY SUCH EASEMENTS AND PERMISSIONS PRIOR TO DISTURBING ANY OFF-SITE PROPERTY.
- 15. IT IS THE CONTRACTOR'S RESPONSIBILITY TO DETERMINE EXISTING SITE CONDITIONS OF SOIL PRIOR TO N.T.P. CONSTRUCTION TO DETERMINE IF ANY OFF SITE MATERIALS WILL NEED TO BE IMPORTED TO ACHIEVE THE GRADES
- 16. CLEAR AREAS INDICATED SHALL BE COMPLETELY CLEAR OF ALL TIMBER, BRUSH, STUMPS, ROOTS, GRASS, WEEDS, RUBBISH, AND ALL OTHER DEBRIS AND OBSTRUCTIONS RESTING ON OR PROTRUDING THROUGH THE SURFACE OF THE GROUND.
- 17. PRIOR TO BID PREPARATION, THE CONTRACTOR MUST BECOME FAMILIAR WITH THE OVERALL SITE CONDITIONS AND PERFORM ADDITIONAL INVESTIGATIONS AS DETERMINED NECESSARY TO UNDERSTAND THE LIMIT AND DEPTH OF EXPECTED ORGANIC SILT PEAT AREAS, PRESENCE OF ROCK, ADEQUACY OF EXISTING MATERIALS AS FILL, DEWATERING REQUIREMENTS, CLEAN FILL REQUIRED FROM OFFSITE, AND MATERIALS TO BE DISPOSED OF OFFSITE, ALL OF WHICH WILL AFFECT THE PRICING. ANY DELAY, INCONVENIENCE, OR EXPENSE CAUSED TO THE CONTRACTOR DUE TO INADEQUATE INVESTIGATION OF EXISTING CONDITIONS SHALL BE INCIDENTAL TO THE CONTRACT, AND NO EXTRA COMPENSATION WILL BE ALLOWED. THE MATERIALS ANTICIPATED TO BE ENCOUNTERED DURING CONSTRUCTION MAY REQUIRE DRYING PRIOR TO USE AS BACKFILL. AND THE CONTRACTOR MAY HAVE TO IMPORT MATERIALS. AT NO EXTRA COST, FROM OFFSITE TO MEET THE REQUIREMENTS FOR COMPACTION AND PROPER FILL.
- 18. NEITHER OWNER NOR ENGINEER ASSUMES ANY RESPONSIBILITY FOR ERRORS OR MISINTERPRETATIONS RESULTING FROM USE OF INCOMPLETE SETS OF BIDDING DOCUMENTS.

DEMOLITION NOTES

В

- THE CONTRACTOR SHALL OBTAIN NECESSARY PERMITS AND LICENSES FOR PERFORMING THE DEMOLITION WORK AND SHALL FURNISH A COPY OF THESE ITEMS TO THE ENGINEER PRIOR TO COMMENCING THE WORK. THE CONTRACTOR SHALL COMPLY WITH THE REQUIREMENTS OF THE PERMITS.
- 2. THE CONTRACTOR SHALL NOTIFY ALL UTILITY COMPANIES OR LOCAL AUTHORITIES FURNISHING GAS, WATER, ELECTRICAL, TELEPHONE. OR SEWER SERVICE SO THEY CAN REMOVE. RELOCATE. DISCONNECT. CAP OR PLUG THEIR EQUIPMENT IN ORDER TO FACILITATE DEMOLITION. DIAL 811 BEFORE DIGGING OR CALL 800-282-7411.
- 3. THE CONTRACTOR IS RESPONSIBLE FOR THE PROTECTION OF ALL TREES, STRUCTURES, AND UTILITIES NOT MARKED FOR REMOVAL OR DEMOLITION AND SHALL PROMPTLY REPAIR ANY DAMAGE AS DIRECTED BY THE ENGINEER AT NO COST TO THE
- 4. THE CONTRACTOR SHALL REMOVE PAVING MARKED FOR DEMOLITION WHICH INCLUDES ALL ASPHALT, CONCRETE, BASE, AND RETAINING WALLS (INCLUDING THE FOOTERS).
- THE CONTRACTOR SHALL REMOVE TREES MARKED FOR REMOVAL WHICH INCLUDES THE ROOTS ASSOCIATED WITH THE TREE. TREES NOT MARKED FOR REMOVAL SHALL BE PROTECTED IN ACCORDANCE WITH THE FAYETTE COUNTY
- THE CONTRACTOR SHALL REMOVE UNSALVAGEABLE MATERIALS AND YARD WASTE FROM THE SITE IMMEDIATELY AND DISPOSE OF IN ACCORDANCE WITH APPLICABLE FEDERAL, STATE, AND LOCAL REGULATIONS
- THE CONTRACTOR SHALL SAW-CUT A SMOOTH STRAIGHT EDGE ON ANY PAVEMENT PROPOSED FOR DEMOLITION PRIOR TO ITS REMOVAL. PRIOR TO CONNECTING PROPOSED PAVEMENT TO EXISTING PAVEMENT, THE CONTRACTOR SHALL ENSURE THAT THE EDGE OF THE EXISTING PAVEMENT IS STRAIGHT AND UNIFORM.
- 8. THE DEMOLITION SHALL BE PHASED TO PROVIDE AT LEAST ONE 12 FOOT LANE OF TRAFFIC AT ALL TIMES.
- CONTRACTOR TO FOLLOW ALL APPLICABLE OSHA STANDARDS FOR ALL EXCAVATIONS.

FAYETTE COUNTY WATER SYSTEM NOTES:

- ALL CONSTRUCTION TO BE IN STRICT ACCORDANCE WITH FAYETTE COUNTY WATER SYSTEM SPECIFICATIONS.
- 2. ALL MATERIALS SHALL CONFORM TO FAYETTE COUNTY DEVELOPMENT SPECIFICATIONS. THE CONTRACTOR SHALL PROVIDE FAYETTE COUNTY WATER SYSTEM SUBMITTALS ON ALL PIPE AND MATERIALS USED FOR APPROVAL. ANY WORK DONE BY THE CONTRACTOR SHALL BE AT HIS OWN RISK UNTIL REVIEW AND APPROVAL OF THESE SUBMITTALS ARE COMPLETE.
- 3. THE CONTRACTOR SHALL NOTIFY THE FAYETTE COUNTY WATER SYSTEM 48 HOURS PRIOR TO CONSTRUCTION TO SCHEDULE A PRE-CONSTRUCTION CONFERENCE.
- 4. THE CONTRACTOR SHALL SCHEDULE AN INSPECTION BY THE FAYETTE COUNTY WATER SYSTEM BEFORE ANY WORK IS HIDDEN FROM VIEW.
- 5. THE CONTRACTOR IS RESPONSIBLE FOR NOTIFYING ALL UTILITIES BEFORE CONSTRUCTION AND VERIFYING THE LOCATION
- 6. IT SHALL BE THE CONTRACTOR'S RESPONSIBILITY TO NOTIFY AND COORDINATE HIS WORK WITH EXISTING UTILITIES WHICH CONFLICT WITH HIS WORK. CONTRACTOR SHALL MAINTAIN SUCH UTILITIES SHOWN OR NOT SHOWN ON THIS PLAN.
- 7. ALL VALVE BOXES ARE TO HAVE COLLARS AND MARKERS AS REQUIRED BY THE FAYETTE COUNTY WATER SYSTEM DEPARTMENT.
- 8. WATER LINES SHALL HAVE A MINIMUM COVER OF 4 FEET FROM FINISHED GRADE.
- 9. MINIMUM HORIZONTAL DISTANCE BETWEEN WATER LINES AND SEWER SHALL BE 10 FEET AND VERTICAL DISTANCE MINIMUM OF 2 FEET.
- 10. ALL OTHER UNDERGROUND UTILITIES OR STRUCTURES SHALL BE A MINIMUM HORIZONTAL AND VERTICAL DISTANCE OF 2 FEET FROM WATER LINES.
- 11. WATER LINES SHALL BE LOCATED 7'-0" FROM THE BACK OF THE CURB OR PER AS APPROVED UTILITY PLACEMENT DETAIL.
- 12. ALL WATER SERVICES SHALL BE MARKED WITH A SAWED "W" NOTCH PAINTED BLUE ON THE CURB.
- 13. ALL WATER MAIN CROSSING UNDER PAVEMENT SHALL BE DIP IN STEEL CASING AS PER FAYETTE COUNTY WATER SYSTEM
- 14. ALL VALVES AND FITTINGS ARE TO BE RESTRAINED WITH APPROPRIATE TYPE AND NUMBER OF EBBA IRON OR UNIFLANGE RESTRAINT SYSTEM APPURTENANCES APPROVED BY THE FAYETTE COUNTY WATER SYSTEM PRIOR TO CONSTRUCTION. ANY CONCRETE BLOCKING THAT IS ALLOWED SHALL BE INSTALLED TO UNDISTURBED EARTH.
- 15. ALL SERVICE LINES CROSSING UNDER PAVEMENT OR IN FRONT OF LOTS SHALL BE ENCASED IN 2" CONDUIT MATERIAL APPROVED BY FAYETTE COUNTY WATER SYSTEM.

ESPC NOTES

- 1. AMENDMENTS/REVISIONS TO THE ES&PC PLAN WHICH HAVE A SIGNIFICANT EFFECT ON BMPS WITH A HYDRAULIC COMPONENT MUST BE CERTIFIED BY THE DESIGN PROFESSIONAL.
- 2. WASTE MATERIALS SHALL NOT BE DISCHARGED TO WATERS OF THE STATE, EXCEPT AS AUTHORIZED BY A SECTION 404
- PERMIT. 3. ALL BUFFERS AND TREE SAVE AREAS SHALL BE CLEARLY IDENTIFIED WITH FLAGGING AND/OR FENCING PRIOR TO
- COMMENCEMENT OF ANY LAND DISTURBANCE. 4. SEDIMENT STORAGE MAINTENANCE INDICATORS MUST BE INSTALLED IN SEDIMENT STORAGE STRUCTURES, INDICATING THE
- 5. INSPECT AND DOCUMENT THE CONDITION OF RUNOFF CONTROLS EVERY 7 DAYS, OR EVERY 14 DAYS AND WITHIN 24 HOURS
- AFTER EACH RAIN OF 0.5 INCH OR MORE.
- 6. PERMITEE SHALL SUBMIT A SIGNED NOTICE OF TERMINATION (NOT) FORM TO THE GEORGIA DIVISION OF WATER AFTER THE SITE HAS BEEN FINALLY STABILIZED.
- 7. 67 CY/AC SEDIMENT STORAGE SUBSTANTIALLY HANDLED BY SILT FENCE. THE LINEAR NATURE OF THIS PROJECT COUPLED WITH LIMITED WORK AREA (ESPECIALLY ADJACENT TO STATE WATER) DOES NOT PROVIDE OPPORTUNITY FOR INSTALLATION OF PERMANENT BMPS TO PREVENT POLLUTANTS FROM DISCHARGING THE SITE WITHOUT FURTHER ENCROACHMENT INTO ADJACENT PRIVATE PROPERTY. DURING CONSTRUCTION, SILT FENCE WILL BE USED TO PREVENT POLLUTANTS FROM DISCHARGING THE SITE. AFTER CONSTRUCTION IS COMPLETE ALL AREAS WILL BE STABILIZED.
- SOIL STOCKPILES MUST BE LOCATED AWAY FROM STREAMS, PONDS, SWALES AND CATCH BASINS. STOCKPILES MUST BE SEEDED, MULCHED, AND ADEQUATELY CONTAINED THROUGH THE USE OF SILT FENCE
- 9. SEDIMENT-LADEN WATER ENCOUNTERED DURING TRENCHING, BORING, OR OTHER EXCAVATION ACTIVITIES MUST BE PUMPED TO A SEDIMENT TRAPPING OR FILTERING DEVICE AND CLEANED BEFORE BEING DISCHARGED. DISCHARGES TO STORM DRAINS, DITCHES, OR WATER BODIES MUST BE COVERED UNDER A EPD PERMIT.
- 10. ALL BARE SOIL AREAS NOT SUBJECT TO ACTIVE CLEARING, EXCAVATION, GRADING, OR FILL ACTIVITIES MUST BE STABILIZED WITH TEMPORARY OR PERMANENT SEEDING OR MULCHING WITHIN 14 DAYS.
- 11. GOOD HOUSEKEEPING PRACTICES MUST BE APPLIED TO PREVENT CONTAMINATED RUNOFF OR OTHER IMPACTS FROM PAINT OR CONCRETE WASTES, FUELS AND OILS, TRASH AND LITTER, OR OTHER MATERIALS. 12. SILT FENCES, DITCH CHECKS, NON-PERMANET SEDIMENT TRAPS, AND OTHER TEMPORARY CONTROLS MUST BE REMOVED
- AFTER VEGETATION IN UPGRADIENT AREAS IS ESTABLISHED AND DITCHES ARE STABLE. 13. GOOD HOUSEKEEPING MEASURES FOR MATERIALS STORAGE AND HANDLING, VEHICLE FUELING AND MAINTENANCE, SPILL
- FREE OF CONTAMINANTS. 14. ALL BMPS SELECTED SHALL BE INSTALLED, OPERATED, AND MAINTAINED ACCORDING TO GSWCC FIELD MANUAL, GEORGIA

RESPONSE AND CLEANUP, AND WASTE MANAGEMENT MUST BE FOLLOWED TO ENSURE THAT RUNOFF FROM THE SITE IS

- DIVISION OF WATER GUIDELINES, MANUFACTURER'S REQUIREMENTS, OR STANDARD INDUSTRY PRACTICE, AS APPROPRIATE.
- 15. APPROVED PLANS AND NPDES DAILY LOG MUST BE ONSITE AT ALL TIMES.

EARTHWORK, GRADING, STABILIZATION, PAVING AND DRAINAGE NOTES

- 1. COMPACT ALL UTILITY TRENCHES WITHIN ROADWAYS TO 98% OF THE MODIFIED PROCTOR MAXIMUM DENSITY (AASHTO T -180) AND TO 95% WITHIN OTHER AREAS.
- 2. ALL ORGANIC SOILS AS DETERMINED WITHIN UTILITY TRENCHES SHALL BE REMOVED AND REPLACED WITH SUITABLE MATERIAL AND COMPACTED TO NO LESS THAN 98% OF THE MODIFIED PROCTOR MAXIMUM DENSITY (AASHTO T - 180).
- STABILIZED SUBGRADE TO MEET SPECIFIED REQUIREMENTS.
- 4. ASPHALTIC CONCRETE TO GDOT STANDARD SPECIFICATION (LATEST EDITION) SECTION 916.1 AND FAYETTE COUNTY, WHICHEVER IS GREATER.
- 5. ALL PAVEMENT MARKINGS SHALL BE THERMOPLASTIC.
- ALL CONCRETE FLUMES, WALKS, AND CURBS SHALL BE CONSTRUCTED WITH 3000 PSI CONCRETE.
- 7. ALL ON-SITE AREAS DISTURBED BY THE CONSTRUCTION SHALL BE STABILIZED USING MEASURES THAT MATCH THE EXISTING VEGETATIVE CONDITIONS OF THE SITE. CONTRACTOR IS RESPONSIBLE FOR IRRIGATION OF PERMANENT GRASSING.
- 8. THE REINFORCED CONCRETE PIPE SHALL BE CLASS III WITH WALL THICKNESS "B" CONFORMING TO ASTM C 76 OR AWWA 302 -74 AND GASKETS SHALL BE IN ACCORDANCE WITH ASTM C - 443 OR ASTM D - 412.
- 9. ALL PIPE CALL OUTS ARE MEASURED CENTER LINE TO CENTER LINE FOR MANHOLES AND INLETS AND FROM THE END OF THE PIPE FOR MITERED END SECTIONS.
- 10. ALL DEWATERING COSTS ASSOCIATED WITH THE INSTALLATION AND CONSTRUCTION OF THE UNDERGROUND UTILITIES; STORM WATER PIPES AND MANHOLES; SANITARY SEWER MAINS, FORCE MAINS, MANHOLES, AND LIFT STATIONS; AND STORM WATER MANAGEMENT SYSTEMS SHALL BE INCLUDED AS PART OF THE CONSTRUCTION BID COSTS. THE CONTRACTOR SHALL SUBMIT FOR WATER USE PERMITS IF REQUIRED FOR DEWATERING ACTIVITIES.
- 11. ALL PIPES SHALL HAVE 3 FEET MINIMUM COVER UNLESS OTHERWISE SPECIFIED IN PLANS, CONTRACTOR SHALL TAKE CARE TO PROVIDE PROPER GRADE ELEVATIONS AND ALIGNMENTS.
- 12. THE CONTRACTOR MUST INSTALL AND MAINTAIN GRASS OR SOD ON EXPOSED SLOPES WITHIN 48 HOURS OF COMPLETED FINAL GRADES, AS NOTED ON PLANS, AND AT ANY OTHER TIME AS NECESSARY TO PREVENT EROSION, SEDIMENTATION OR TURBID DISCHARGES TO ANY DOWNSTREAM WATER BODY, WETLAND, OR OFF-SITE PROPERTY. SODDING ON SLOPES 3:1 AND STEEPER SHALL BE STAKED.
- 13. THE CONTRACTOR SHALL TAKE ALL MEASURES NECESSARY TO CONTROL TURBIDITY AND SEDIMENT INCLUDING, BUT NOT LIMITED TO, THE INSTALLATION OF TURBIDITY BARRIERS AND SILT FENCES AT ALL LOCATIONS WHERE THE POSSIBILITY OF TRANSFERRING SUSPENDED SOLIDS INTO THE RECEIVING WATER BODY EXISTS DUE TO THE PROPOSED WORK. TURBIDITY AND SEDIMENT BARRIERS MUST BE MAINTAINED AT ALL LOCATIONS UNTIL CONSTRUCTION IS COMPLETED AND DISTURBED SOIL AREAS ARE STABILIZED. THE CONTRACTOR SHALL ALSO BE RESPONSIBLE FOR REMOVING THE BARRIERS.
- 14. EXISTING RUNOFF CURVE NUMBER FOR THE PROJECT: 67. PROPOSED RUNOFF CURVE NUMBER FOR THE PROJECT: 67.
- 15. ALL CONCRETE STRUCTURES SHOWN ARE PRE-CAST FROM AN APPROVED VENDOR. CAST-IN-PLACE METHODS MAY BE USED FOR STRUCTURE COMPONENTS WHERE APPLICABLE FOR APPROVAL.

OTHER UTILITY INFORMATION

- THE CONTRACTOR SHALL NOTIFY UTILITY COMPANIES WHICH MAY HAVE THEIR UTILITIES WITHIN THE CONSTRUCTION AREAS TO LOCATE THEIR FACILITIES IN THE FIELD FORTY-EIGHT (48) HOURS PRIOR TO BEGINNING CONSTRUCTION. DIAL 811 BEFORE DIGGING OR CALL 800-282-7411.
- 2. DUCTILE IRON PIPE SHALL BE ENCASED IN POLYETHYLENE TWENTY-FIVE (25) FEET ON EACH SIDE OF ANY PERPENDICULAR CROSSING OF METALLIC GAS MAINS OR ANY OTHER CATHODICALLY PROTECTED PIPELINE AND FOR LOCATIONS PARALLEL TO AND WITHIN TEN FEET OF METALLIC GAS MAINS OR OTHER CATHODICALLY PROTECTED PIPE AND THROUGH THE AREA OF INFLUENCE OF CATHODIC PROTECTION ANODE BED.

SPILL CONTROL NOTES:

- IN ADDITION TO THE GOOD HOUSEKEEPING AND MATERIAL MANAGEMENT PRACTICES DISCUSSED IN THE PREVIOUS NOTES OF THIS PLAN, THE FOLLOWING PRACTICES WILL BE FOLLOWED FOR SPILL PREVENTION AND CLEANUP:
- a. MANUFACTURERS' RECOMMENDED METHODS FOR SPILL CLEANUP WILL BE CLEARLY POSTED AND SITE PERSONNEL WILL BE MADE AWARE OF THE PROCEDURES AND THE LOCATION OF THE INFORMATION AND CLEANUP SUPPLIES.
- b. ALL SPILLS WILL BE CLEANED UP IMMEDIATELY AFTER DISCOVERY.
- c. SPILLS OF TOXIC OR HAZARDOUS MATERIAL WILL BE REPORTED TO THE APPROPRIATE STATE OR LOCAL GOVERNMENT AGENCY, REGARDLESS OF SIZE.
- d. THE SPILL PREVENTION PLAN WILL BE ADJUSTED TO INCLUDE MEASURES TO PREVENT THIS TYPE OF SPILL FROM REOCCURRING AND HOW TO CLEAN UP THE SPILL IF THERE IS ANOTHER ONE. A DESCRIPTION OF THE SPILL, WHAT CAUSED IT, AND THE CLEANUP MEASURES WILL ALSO BE INCLUDED.
- e. THE SITE SUPERINTENDENT RESPONSIBLE FOR THE DAY-TO-DAY SITE OPERATIONS WILL BE THE SPILL PREVENTION AND CLEANUP COORDINATOR.
- 2. PETROLEUM BASED PRODUCTS CONTAINERS FOR PRODUCTS SUCH AS FUELS, LUBRICANTS, AND TARS WILL BE INSPECTED DAILY FOR LEAKS AND SPILLS. THIS INCLUDES ON-SITE VEHICLE AND MACHINERY DAILY INSPECTIONS AND REGULAR PREVENTATIVE MAINTENANCE OF SUCH EQUIPMENT. EQUIPMENT MAINTENANCE AREAS WILL BE LOCATED AWAY FROM STATE WATERS, NATURAL DRAINS AND STORM WATER DRAINAGE INLETS. IN ADDITION, TEMPORARY FUELING TANKS SHALL HAVE A SECONDARY CONTAINMENT LINER TO PREVENT/MINIMIZE SITE CONTAMINATION. DISCHARGE OF OILS, FUELS AND LUBRICANTS IS PROHIBITED. PROPER DISPOSAL METHODS WILL INCLUDE IN A SUITABLE CONTAINER AND DISPOSAL AS REQUIRED BY LOCAL AND STATE REGULATIONS.

TRAFFIC CONTROL NOTES

- 1. THE CONTRACTOR SHALL SUBMIT A TEMPORARY TRAFFIC CONTROL PLAN TO THE COUNTY FOR APPROVAL PRIOR TO
- COMMENCEMENT OF CONSTRUCTION ACTIVITIES.

FOOT LANE FOR TRAFFIC AT ALL TIMES.

- ALL REQUIRED TRAFFIC SIGNAGE MUST MEET MUTCD STANDARDS.
- ALL REQUIRED TRAFFIC STRIPING MUST MEET MUTCD AND GDOT PLAN SPECIFICATIONS AND MUST BE THERMO-PLASTIC.
- ALL STRIPING LAYOUTS MUST BE APPROVED BY THE COUNTY TRAFFIC ENGINEER PRIOR TO FINAL APPLICATION. CONTRACTOR TO COORDINATE LANE CLOSURES WITH FAYETTE COUNTY AND ENGINEER. PROVIDE AT LEAST ONE 12



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Georgia 30092

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CLIENT INFORMATION

FAYETTE COUNTY

140 STONEWALL AVE W, STE 203 FAYETTEVILLE, GA. 30214

PROJECT NAME

DOWNING REPLACEMEN^{*}

FAYETTE COUNTY, GA

DRAWING ISSUE


DESIGNED BY: DRAWN BY: CHECKED BY: DMM/MDM SUBMITTED BY: DATE: SEPTEMBER 1, 2022 PROJECT# 1210495

SHEET TITLE

CIVIL GENERAL NOTES

SHEET NUMBER

SHEET 3 OF 16

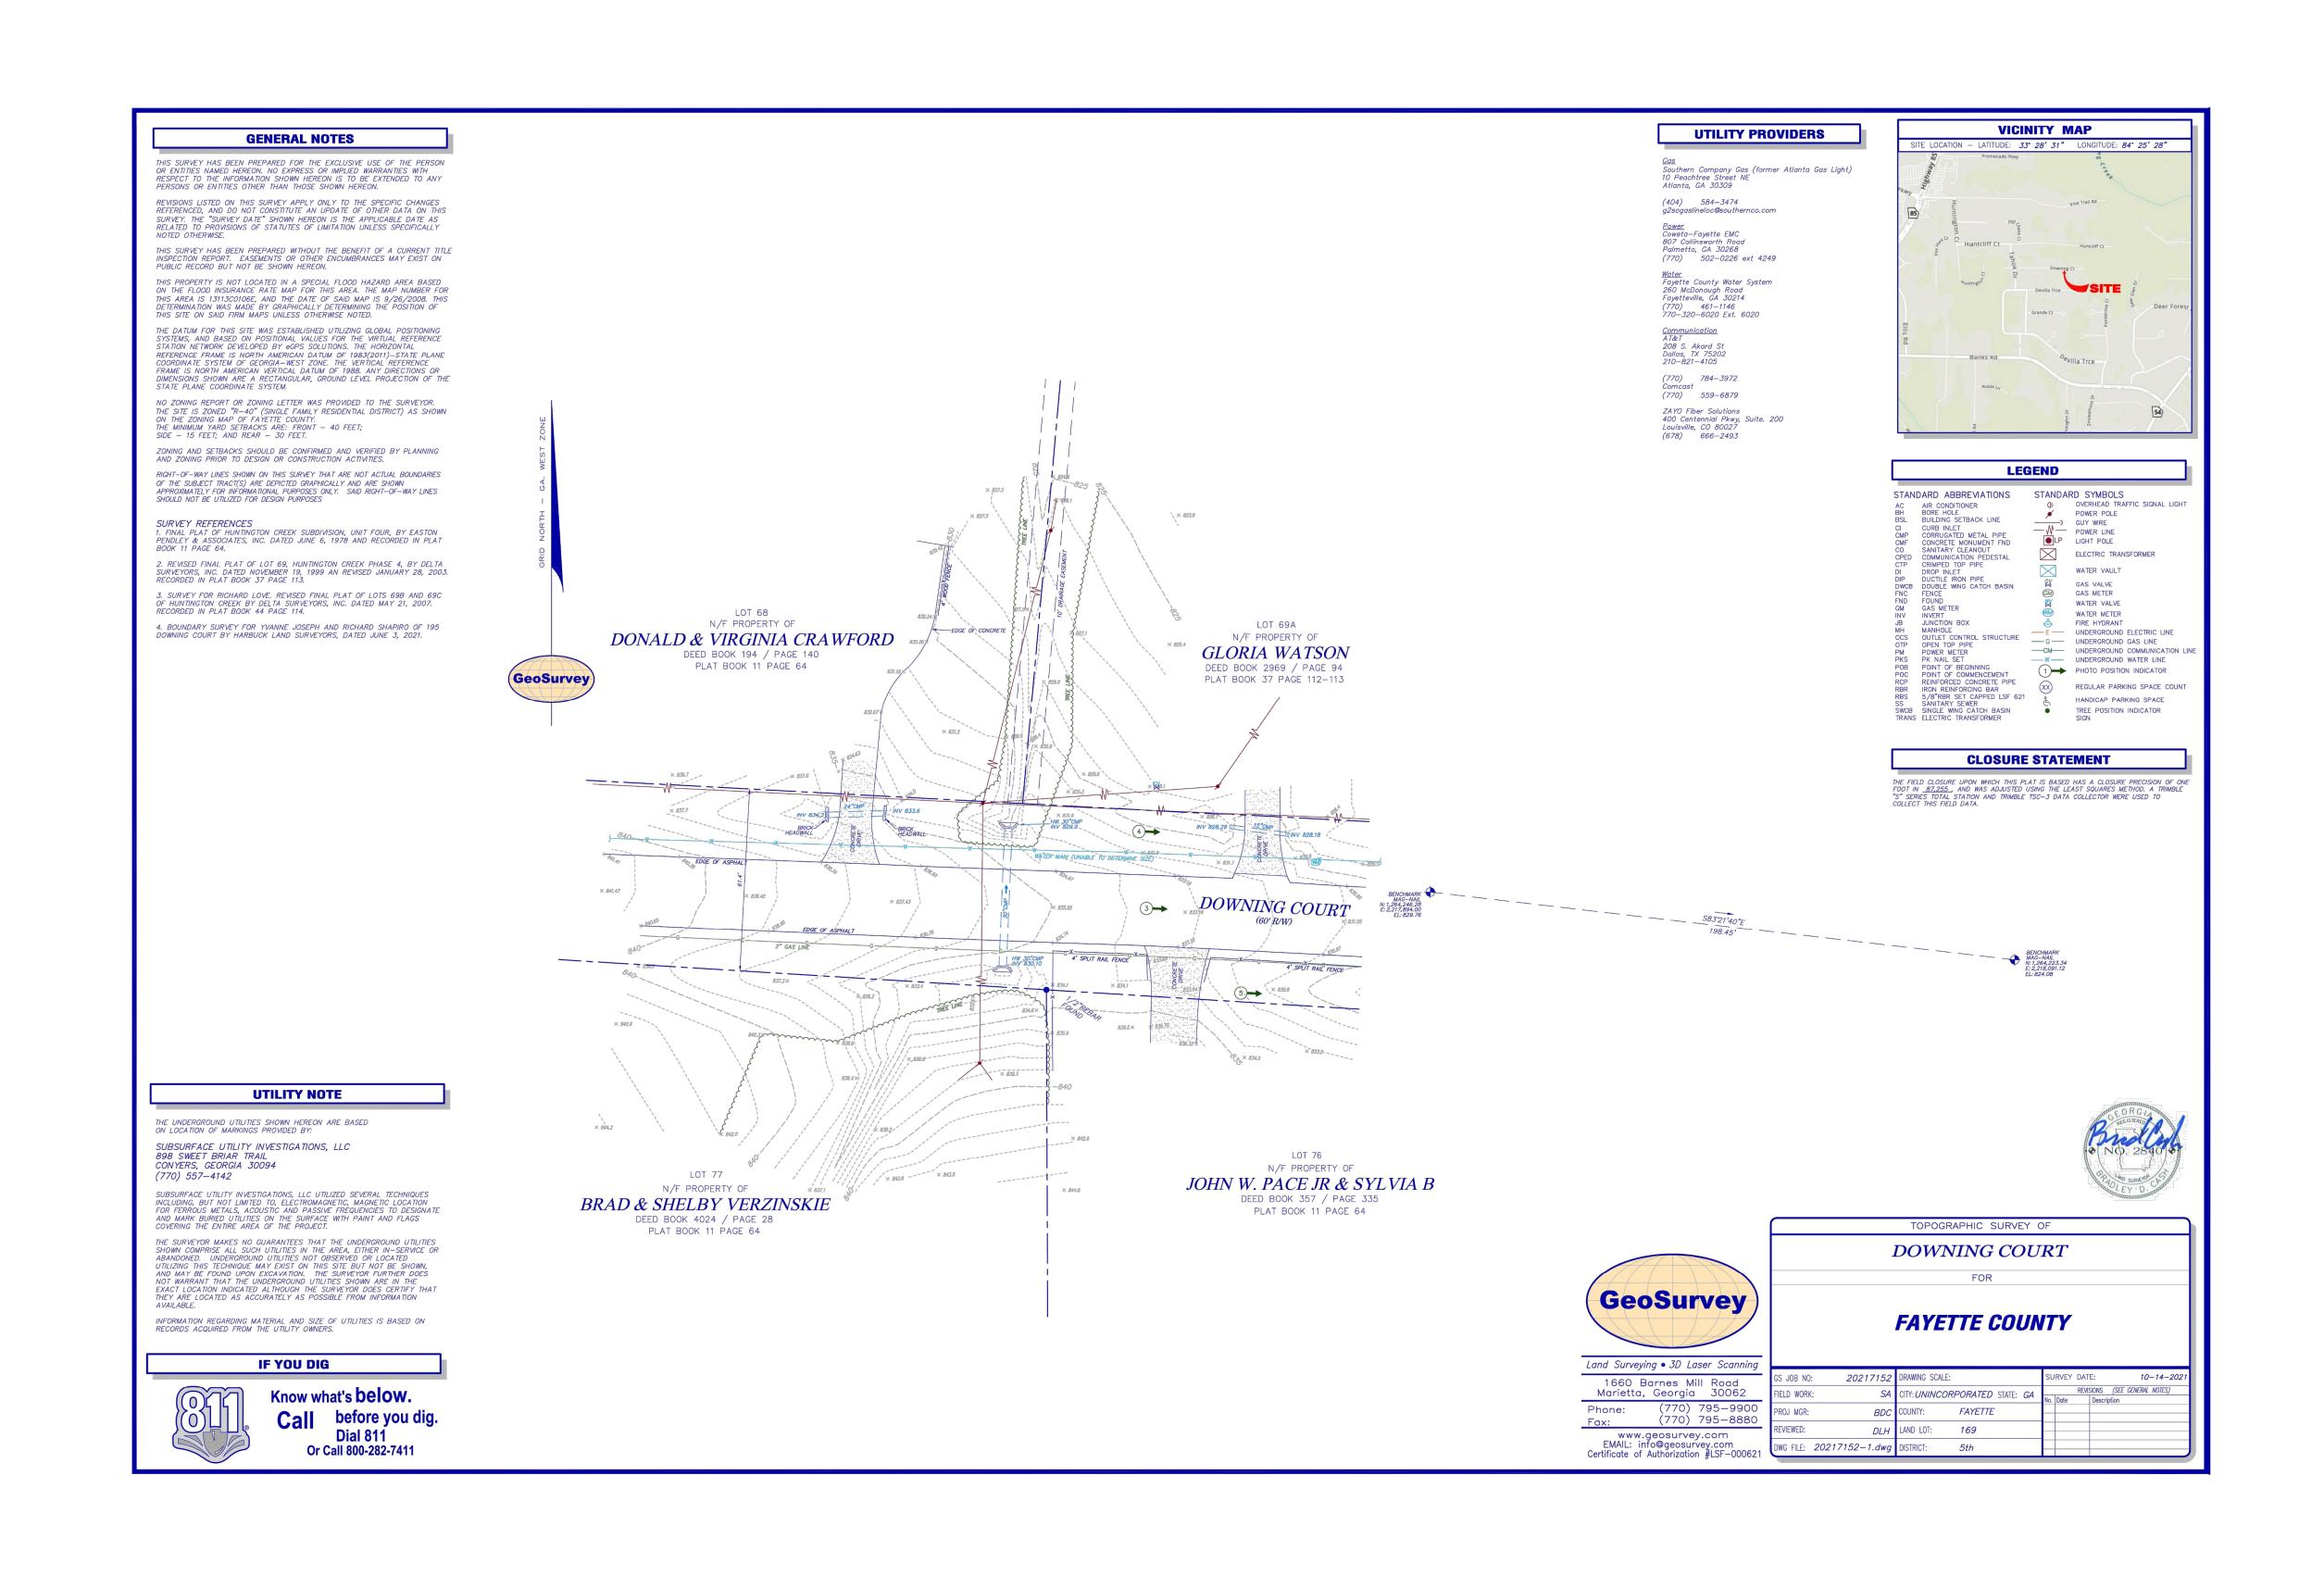

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CLIENT INFORMATION

FAYETTE COUNTY

140 STONEWALL AVE W, STE 203 FAYETTEVILLE, GA. 30214

PROJECT NAME

DOWNING COURT **CULVERT** REPLACEMENT

FAYETTE COUNTY, GA

DRAWING ISSUE

MDW DESIGNED BY: MDW DRAWN BY: CHECKED BY: DMM/MDM SUBMITTED BY: DATE: SEPTEMBER 1, 2022

SHEET TITLE

1210495

TOPOGRAPHIC SURVEY

PROJECT#

SHEET NUMBER

SHEET 4 OF 16

ORIGINAL SHEET SIZE: 22" X 34"


100% DESIGN. ISSUED FOR CONSTRUCTION

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TOPOGRAPHIC SURVEY





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Georgia 30092
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CLIENT INFORMATION

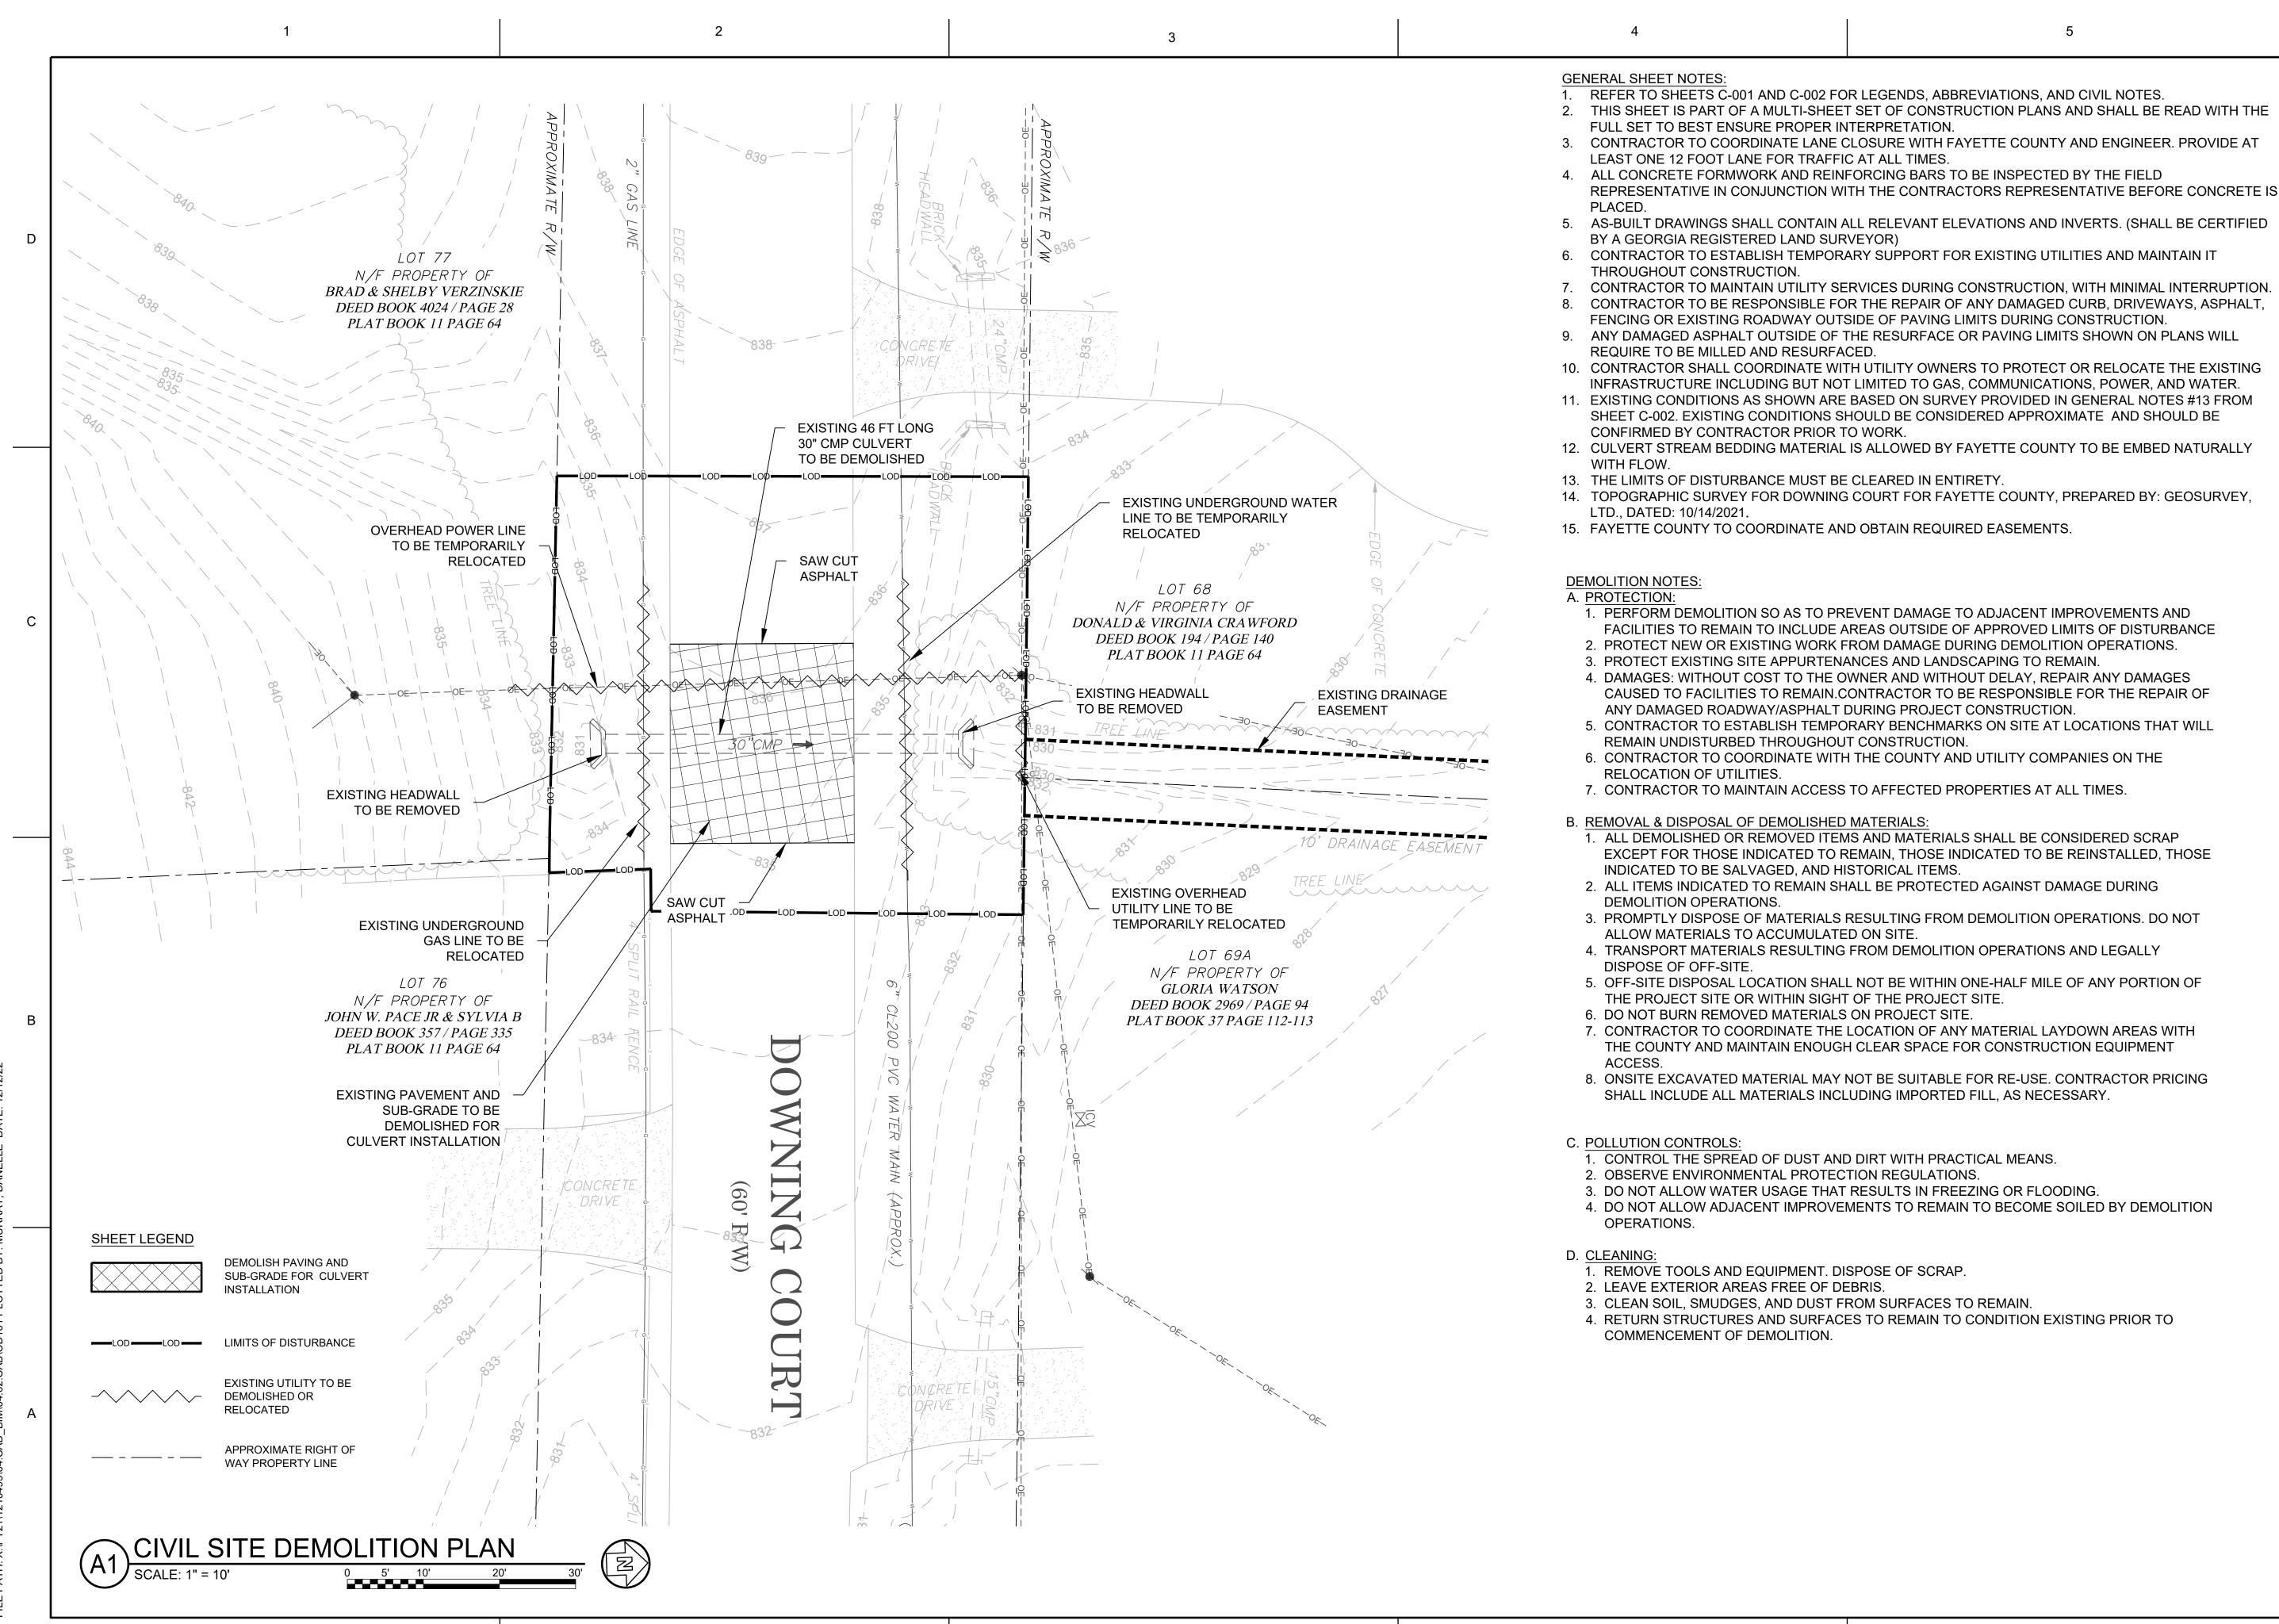FAYETTE COUNTY

140 STONEWALL AVE W, STE 203 FAYETTEVILLE, GA. 30214

PROJECT NAME

DOWNING COURT CULVERT REPLACEMENT

FAYETTE COUNTY, GA

DRAWING ISSUE

1/12/2022 DATE

% DESIGN PLANS

DESIGNED BY: MDW
DRAWN BY: MDW
CHECKED BY: DMM/MDM
SUBMITTED BY: DMM
DATE: SEPTEMBER 1, 2022
PROJECT# 1210495

SHEET TITLE

CIVIL SITE DEMOLITION PLAN

SHEET NUMBER

CD101

SHEET 5 OF 16

22" X 34"

ORIGINAL SHEET SIZE:

GENERAL SHEET NOTES

- 1. REFER TO SHEETS C-001 AND C-002 FOR LEGENDS, ABBREVIATIONS, AND CIVIL NOTE
- 2. THIS SHEET IS PART OF A MULTI-SHEET SET OF CONSTRUCTION PLANS AND SHALL BE READ WITH THE FULL SET TO BEST ENSURE PROPER INTERPRETATION.
- 3. CONTRACTOR TO COORDINATE LANE CLOSURE WITH FAYETTE COUNTY AND ENGINEER. PROVIDE AT LEAST ONE 12 FOOT LANE FOR TRAFFIC AT ALL TIMES. CONFORM TO THE MANUAL ON UNIFORM TRAFFIC CONTROL DEVICE (MUTCD) AND GDOT STANDARDS.
- 4. ALL CONCRETE FORMWORK AND REINFORCING BARS TO BE INSPECTED BY ENGINEER'S OR OWNER'S FIELD REPRESENTATIVE IN CONJUNCTION WITH THE CONTRACTOR'S REPRESENTATIVE BEFORE CONCRETE IS PLACED.
- 5. AS-BUILT DRAWINGS SHALL CONTAIN ALL RELEVANT ELEVATIONS AND INVERTS. (ALL AS-BUILT DRAWINGS SHOULD BE CERTIFIED BY A GEORGIA REGISTERED LAND SURVEYOR).
- 6. CONTRACTOR TO ESTABLISH TEMPORARY SUPPORT FOR EXISTING UTILITIES AND MAINTAIN IT THROUGHOUT CONSTRUCTION.
- 7. CONTRACTOR TO BE RESPONSIBLE FOR THE REPAIR OF ANY DAMAGED CURB, FENCE, OR DRIVEWAYS DURING CONSTRUCTION.
- 8. CONTRACTOR TO BE RESPONSIBLE FOR THE REPAIR OF ANY DAMAGED ROADWAY/ASPHALT DURING PROJECT CONSTRUCTION, AS WELL AS REPLACEMENT AND RELOCATION OF MAILBOXES.
- 9. IF PRECAST STRUCTURE IS USED IN PLACE OF A CAST-IN-PLACE STRUCTURE, THE STRUCTURE SHOP DRAWINGS ARE TO BE APPROVED BY ENGINEER FOR OWNER.

GRADING NOTES:

- 1. ROAD TO BE GRADED FROM CROWN TO EDGE OF ASPHALT AT 1/4" PER 1'
- MAXIMUM SLOPES ALLOWED WITHIN FAYETTE COUNTY RIGHT-OF-WAY SHALL BE 3:1. PROVIDE GENTLER SLOPES WHERE POSSIBLE.

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CLIENT INFORMATION

FAYETTE COUNTY

140 STONEWALL AVE W, STE 203 FAYETTEVILLE, GA. 30214

PROJECT NAME

DOWNING
COURT
CULVERT
REPLACEMENT

FAYETTE COUNTY, GA

DRAWING ISSUE

/2022

ESIGN PLANS

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DESIGNED BY: MDW
DRAWN BY: MDW
CHECKED BY: DMM/MDM
SUBMITTED BY: DMM
DATE: SEPTEMBER 1, 2022
PROJECT # 1210495

SHEET TITLE

SITE AND GRADING PLAN

SHEET NUMBER

CG101

1 3

845 PROPOSED $-\Psi$ downing court -**ROAD TO MATCH** ELEV. = 835.8 **EXISTING GRADE** CULVERT COVER BELOW ASPHALT = 2.42' EXISTING GRADE PROPOSED -— PROPOSED GRADE **HEADWALL AND** WING WALLS PROPOSED HEADWALL 四 835 AND WING WALLS 100-YR_25-YR_ RIP RAP 30" RCP 40LF @ 0.75% EXISTING 2" GAS LINE TO BE RELOCATED FLOW → ─ DS INV. = 829.80' US INV. = 830.10' ---APPROXIMATE LOCATION = WATERLINE OFFSET FROM OF EXISTING 6" WATER LINE RCP CULVERT = 1.5' TO BE RELOCATED _WATERLINE IN 12" PROPOSED 6" DIP — \STEEL ENCASEMENT WATER LINE 1+25 0+75 1+50 1+00 STATION

PROPOSED 30" RCP CULVERT PROFILE
HORIZ. SCALE 1" = 10'

VERT. SCALE 1" = 5'

FLOW SUMMARY TABLE TAILWATER STORM HEADWATER OUTLET DOWNSTREAM FLOW (CFS) **ELEVATION** ELEVATION (FT) | VELOCITY (FPS) | VELOCITY (FPS) **FREQUENCY** (FT) 10-YEAR 832.09 7.13 830.95 15.80 4.69 25-YEAR 18.80 832.33 7.46 4.80 831.05 7.91 4.93 100-YEAR 23.50 832.69 831.18

DRAINAGE AREA = 6 ACRES AVERAGE STREAM SLOPE = 5.0% 3500 Parkway Lane
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Georgia 30092
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EOR/AOR SEAL

GEORGISTER

No. 27428

PROFESSIONAL

M. MOR

1 20 2023

CLIENT INFORMATION

FAYETTE COUNTY

140 STONEWALL AVE W, STE 203
FAYETTEVILLE, GA. 30214

PROJECT NAME

DOWNING
COURT
CULVERT
REPLACEMENT

FAYETTE COUNTY, GA

DRAWING ISSUE

2/12/2022

00% DESIGN PLANS

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DESIGNED BY: MDW

DRAWN BY: MDW

CHECKED BY: DMM/MDM

SUBMITTED BY: DMM

DATE: SEPTEMBER 1, 2022

PROJECT # 1210495

SHEET TITLE

CULVERT PROFILE

SHEET NUMBER

CG201

ORIGINAL SHEET SIZE: 22" X 34"

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AMENDMENTS/REVISIONS TO THE ES&PC PLAN WHICH HAVE A SIGNIFICANT EFFECT ON BMPS WITH A HYDRAULIC COMPONENT MUST BE CERTIFIED BY THE DESIGN PROFESSIONAL.

WASTE MATERIALS SHALL NOT BE DISCHARGED TO WATERS OF THE STATE, EXCEPT AS AUTHORIZED BY A SECTION 404 PERMIT.

THE ESCAPE OF SEDIMENT FROM THE SITE SHALL BE PREVENTED BY THE INSTALLATION OF EROSION AND SEDIMENT CONTROL MEASURES AND PRACTICES PRIOR TO, OR CONCURRENT WITH, LAND DISTURBING ACTIVITIES.

EROSION CONTROL MEASURES WILL BE MAINTAINED AT ALL TIMES. IF FULL IMPLEMENTATION OF THE APPROVED PLAN DOES NOT PROVIDE FOR EFFECTIVE EROSION CONTROL, ADDITIONAL EROSION AND SEDIMENT CONTROL MEASURES SHALL BE IMPLEMENTED TO CONTROL OR TREAT THE SEDIMENT SOURCE.

ANY DISTURBED AREA LEFT EXPOSED FOR A PERIOD GREATER THAN 14 DAYS SHALL BE STABILIZED WITH MULCH OR TEMPORARY SEEDING.

ALL BUFFERS AND TREE SAVE AREAS SHALL BE CLEARLY IDENTIFIED WITH FLAGGING AND/OR FENCING PRIOR TO COMMENCEMENT OF ANY LAND DISTURBANCE.

SEDIMENT STORAGE MAINTENANCE INDICATORS MUST BE INSTALLED IN SEDIMENT STORAGE STRUCTURES, INDICATING THE 1/3 FULL VOLUME.

DESIGN PROFESSIONAL CERTIFICATION:

I CERTIFY UNDER PENALTY OF LAW THAT THIS PLAN WAS PREPARED AFTER A SITE VISIT TO THE LOCATIONS DESCRIBED HEREIN BY MYSELF OR MY AUTHORIZED AGENT. UNDER MY DIRECT SUPERVISION.

DATE

DAVID MORGAN, P.E.
GSWCC LEVEL II CERTIFICATION # 0000011643

GSWCC LEVEL II CERTIFICATION # 000001 EXPIRES: 06/03/2024

EROSION, SEDIMENTATION, AND POLLUTION CONTROL PLAN GENERAL NOTES (IN CONFORMANCE WITH STATE OF GEORGIA GENERAL NPDES PERMIT NO. GAR 100001.)

OWNER/ FAYETTE COUNTY ENVIRONMENTAL MANAGEMENT

PRIMARY PHIL MALLON PERMITEE: 140 STONEWA

ENGINEER:

С

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140 STONEWALL AVE. W., SUITE 203, FAYETTEVILLE, GA. 30214 PHONE (770) 305-5410

PUBLICWORKS@FAYETTECOUNTYGA.GOV

POND & COMPANY 3500 PARKWAY LANE, SUITE 500

PEACHTREE CORNERS, GEORGIA 30092

PHONE: (678) 336-7740

FAX: (678) 336-7744

CONTACT: DAVID MORGAN, PE

GA. P.E. # 27428, E&S LEVEL II CERTIFICATION # 0000011643

CONTRACTOR: TO BE DETERMINED

24-HOUR EROSION AND SEDIMENT CONTROL CONTACT: PHIL MALLON -770-313-9855

TOTAL SITE AREA: 0.15 ACRES DISTURBED AREA: 0.08 ACRES

EXISTING LAND USE: THE EXISTING LAND USE CONSISTS OF 30-INCH DIAMETER CMP CULVERT AND A

PAVED ROAD.

PROPOSED LAND USE: THE PROJECT CONSISTS OF REMOVING THE EXISTING DETERIORATED 30 INCH DIAMETER CMP CULVERT. THE CULVERT IS TO BE REPLACED WITH A 40 LINEAR

30-INCH DIAMETER RCP CULVERT.

GPS COORDINATES OF SITE: 33°28'26.56"N, 84°25'39.93"W

NAME OF RECEIVING WATERS: FLINT RIVER

AME OF RECEIVING WATERS: FLINT RIVER AREA OF ON-SITE WETLANDS: 0 AC National Flood Hazard Layer FIRMette



SEE EIS REPORT FOR DETAILED LEGEND AND INDEX MAP FOR FIRM PANEL LAYOUT With BFE or Depth Zone AE, AO, AH, VE, AR 0.2% Annual Chance Flood Hazard, Areas of 1% annual chance flood with average depth less than one foot or with drainage Future Conditions 1% Annual Area with Reduced Flood Risk due to Levee. See Notes. Zone X FLOOD HAZARD Area with Flood Risk due to Levee Zone D NO SCREEN Area of Minimal Flood Hazard Zone X Effective LOMRs GENERAL - - - Channel, Culvert, or Storm Sewer JCTURES | IIIIII Levee, Dike, or Floodwall B 20.2 Cross Sections with 1% Annual Chance 17.5 Water Surface Elevation Base Flood Elevation Line (BFI Limit of Study Jurisdiction Boundary --- Coastal Transect Baseline ---- Profile Baseline Hydrographic Feature No Digital Data Available The pin displayed on the map is an approximate point selected by the user and does not represent an authoritative property location. digital flood maps if it is not void as described below. authoritative NFHL web services provided by FEMA. This map as exported on 6/7/2022 at 5:34 PM and does not reflect changes or amendments subsequent to this date and time. The NFHL and effective information may change or his map image is void if the one or more of the following may elements do not appear: basemap imagery, flood zone labels, legend, scale bar, map creation date, community identifiers unmapped and unmodernized areas cannot be used for

elements do not appear: basemap imagery, flood zone lab legend, scale bar, map creation date, community identifier FIRM panel number, and FIRM effective date. Map images unmapped and unmodernized areas cannot be used for regulatory purposes.

DATED 09/26/2008

THERE ARE KNOWN WETLANDS LOCATED WITHIN 200 FEET OF PROJECT AREA.

STATE WATERS DO EXIST WITHIN 200 FEET OF PROJECT AREA.

EROSION CONTROL LEGEND

FEMA FLOOD MAP - 13113C0106E

Ds1

SCALE: NTS

TEMPORARY MULCHING -DETAIL A2/CE-501

Ds2

TEMPORARY SEEDING -DETAIL A1/CE-502

Ds4

DISTURBED AREA STABILIZATION W/ SOODING - DETAIL B3/CE-502

Sd1-NS

SILT FENCING - NS DETAIL C1/CE-501



STORM DRAIN OUTLET PROTECTION -DETAIL A1/CE-504



DUST CONTROL -DETAIL A1/CE-501



TREE PROTECTION
DETAIL C1/CE-504



SOIL MAP

SOILS LEGEND

SYMBOL DESCRIPTION

AmB Appling sandy loam, 2 to 6 percent slopes

CA Cartecay loam, 0 to 2 percent slopes, frequently flooded

CeB Cecil sandy loam, 2 to 6 percent slopes

CeC Cecil sandy loam, 6 to 10 percent slopes

CfC2 Cecil sandy clay loam, 6 to 10 percent slopes, eroded

PaC Pacolet sandy loam, 6 to 10 percent slopes

PaE Pacolet sandy loam, 10 to 25 percent slopes

WH Wehadkee soils, 0 to 2 percent slopes, frequently flooded

ACTIVITY SCHEDULE (FOR PERMITTING REFERENCE ONLY) TIME / 16 WEEKS ACTIVITY 3 | 4 | 5 | 6 | INSTALL SILT FENCE, CONSTRUCTION EXIT CLEARING AND GRUBBING INSTALL REMAINDER OF INITIAL PERIMTER CONTROLS INCLUDING SEDIMENT BASINS. CHECK DAMS, ROCK DAMS, DIVERSION BERMS ROCK FILTER, DOWN DRAINS, INLET SEDIMENT TRAPS, AND FILTER RINGS, DEMOLITION OF SURFACE PAVEMENT, OR ANY OTHER MISCELLANEOUS REQUIRED BMP, FENCES, EXISTING CULVERTS AND UTILITY UTILITY RELOCATION ROUGH GRADING OPERATIONS INSTALLATION OF PROPOSED CULVERTS FINAL PAVING AND GRADING PERMANENT SEEDING REMOVAL OF TEMPORARY EROSION AND SEDIMENT CONTROL MEASURES MAINTENANCE OF TEMPORARY EROSION AND SEDIMENT CONTROL MEASURES

DESIGN PROFESSIONAL:
DAVID MORGAN, P.E.
LEVEL II CERTIFICATION
No.: 0000011643
EXPIRES: 06/03/2024



Know what's below.

Call before you dig.

Dial 811

Or Call 800-282-7411

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GEORGISTER

No. 27428
PROFESSIONAL

M. MOR

1 20 2023

CLIENT INFORMATION

FAYETTE COUNTY

140 STONEWALL AVE W, STE 203
FAYETTEVILLE, GA. 30214

PROJECT NAME

DOWNING
COURT
CULVERT
REPLACEMENT

FAYETTE COUNTY, GA

DRAWING ISSUE

2/12/2022

DESIGN PLANS

DESIGNED BY: MDW
DRAWN BY: MDW
CHECKED BY: DMM/MDM
SUBMITTED BY: DMM
DATE: SEPTEMBER 1, 2022

SHEET TITLE

1210495

EROSION AND
SEDIMENT
CONTROL
NOTES

PROJECT#

SHEET NUMBER

CE001

SHEET 8 OF 16

ORIGINAL SHEET SIZE:

22" X 34"

STRUCTURAL PRACTICES:

THE STRUCTURAL PRACTICES SHOWN ON THIS PLAN HAVE BEEN DESIGNED TO REDUCE EROSION & SEDIMENTATION OF DISTURBED AREAS.

SILT FENCE (SD1-TYPE "S"), TEMPORARY SEDIMENT BASINS, AND DIVERSION DITCHES WILL BE INSTALLED PRIOR TO CLEARING AND GRADING OPERATIONS TO KEEP SEDIMENT CONTAINED WITHIN THE SITE AS NECESSARY DISTURBED AREA STABILIZATION SHALL BE STABILIZED WITH MULCH (Ds1), TEMPORARY SEEDING (Ds2), AND PERMANENT SEEDING (Ds3) AS NECESSARY. INLET SEDIMENT TRAP PROTECTION WILL BE USED TO HELP PREVENT SEDIMENT FROM ENTERING ANY EXISTING INLETS. SEDIMENT STORAGE OF 67 CY PER DISTURBED ACRE IS PROVIDED BY TEMPORARY SEDIMENT BASINS.

|CRITICAL WORK ZONE:

ALL SLOPES 3:1 OR STEEPER AND HIGHER THAN 5 FEET, AND ALL SLOPES ADJACENT TO BUFFERS SHALL RECEIVE SURFACE ROUGHENING, AND EROSION CONTROL MATTING. SILT FENCING WILL BE USED TO PREVENT SEDIMENT FROM LEAVING THE DISTURBED AREA. INLET PROTECTION WILL BE USED TO PREVENT SEDIMENT FROM ENTERING THE STORM SEWER.

CONSTRUCTION PERIOD STORM WATER POLLUTANT CONTROL

SEDIMENTATION AND FUEL SPILLS ARE POTENTIAL SOURCES OF STORM WATER POLLUTION DURING THE CONSTRUCTION PROCESS. THESE POLLUTANTS WILL BE REMOVED AND/OR REDUCED VIA THE BMP'S CONTAINED WITHIN THIS PLAN

STABILIZATION MEASURES

THE STABILIZATION MEASURES SHOWN ON THESE PLANS HAVE BEEN DESIGNED TO STABILIZE THE DISTURBED AREAS FOLLOWING THE TEMPORARY OR PERMANENT COMPLETION OF CONSTRUCTION. ALL EXPOSED AREAS SHALL BE STABILIZED WITH TEMPORARY MULCHING (DS1) IMMEDIATELY AFTER TRENCHING IF THEY ARE TO REMAIN INACTIVE FOR 14 DAYS OR MORE. ALL DISTURBED AREAS SHALL BE STABILIZED WITH TEMPORARY (DS2) OR PERMANENT (DS3) VEGETATION AS INDICATED ON THE PLAN. SLOPES GREATER 3:1 ARE TO BE STABILIZED WITH EROSION CONTROL MATTING (MB). DUST CONTROL (DU) SHALL ALSO BE PROVIDED AS NEEDED DURING GRADING ACTIVITIES. SEE EROSION, SEDIMENTATION, AND POLLUTION CONTROL (ESPCP) DETAIL SHEETS FOR MORE DETAILS REGARDING THESE STABILIZATION MEASURES.

STABILIZATION MEASURES SHALL BE INITIATED AS SOON AS PRACTICABLE IN PORTIONS OF THE SITE WHERE CONSTRUCTION ACTIVITIES HAVE TEMPORARILY OR PERMANENTLY CEASED, BUT IN NO CASE MORE THAN 14 DAYS AFTER THE CONSTRUCTION ACTIVITY IN THAT PORTION OF THE SITE HAS TEMPORARILY OR PERMANENTLY CEASED, EXCEPT:

WHERE THE INITIATION OF STABILIZATION MEASURES BY THE 14TH DAY AFTER CONSTRUCTION ACTIVITY TEMPORARILY OR PERMANENTLY CEASED IS PRECLUDED BY SNOW COVER OR OTHER ADVERSE WEATHER CONDITIONS, STABILIZATION MEASURES SHALL BE INITIATED AS SOON AS PRACTICAL

WHERE CONSTRUCTION ACTIVITY WILL RESUME ON A PORTION OF THE SITE WITHIN 21 DAYS FROM WHEN ACTIVITIES CEASED (E.G. THE TOTAL TIME PERIOD THAT CONSTRUCTION ACTIVITY IS TEMPORARILY CEASED IS LESS THAN 21 DAYS) THEN STABILIZATION MEASURES DO NOT HAVE TO BE INITIATED ON THAT PORTION OF THE SITE BY THE 14TH DAY AFTER CONSTRUCTION ACTIVITY TEMPORARILY CEASED.

KEEPING PLANS CURRENT:

THE PRIMARY, SECONDARY OR TERTIARY PERMITTEES, AS APPLICABLE, SHALL AMEND THEIR PLAN WHENEVER THERE IS A CHANGE IN DESIGN, CONSTRUCTION, OPERATION , OR MAINTENANCE, WHICH HAS A SIGNIFICANT EFFECT ON BMPS WITH A HYDRAULIC COMPONENT (I.E., THOSE BMPS WHERE THE DESIGN IS BASED UPON RAINFALL INTENSITY, DURATION AND RETURN FREQUENCY STORMS) OR IF THE PLAN PROVES TO BE INEFFECTIVE IN ELIMINATING OR SIGNIFICANTLY MINIMIZING POLLUTANTS FROM SOURCES IDENTIFIED UNDER PART IV.D.3. OF THIS PERMIT. AMENDMENTS TO THE PLAN MUST BE CERTIFIED BY A DESIGN PROFESSIONAL AS PROVIDED IN THIS PERMIT. SECONDARY PERMITTEES MUST NOTIFY THE PRIMARY PERMITTEE WITHIN 24-HOURS OF BECOMING AWARE OF ANY SUSPECTED BMP DESIGNED DEFICIENCIES WHICH ARE NOT EFFECTIVE IN CONTROLLING THE DISCHARGE OF POLLUTANTS FROM THE SECONDARY PERMITTEE'S SITE. THE PRIMARY PERMITTEE MUST EVALUATE WHETHER THESE DEFICIENCIES EXIST WITHIN 48-HOURS OF SUCH NOTICE, AND IF THESE DEFICIENCIES ARE FOUND TO EXIST MUST AMEND THE PLAN IN ACCORDANCE WITH THIS PARAGRAPH TO ADDRESS THOSE DEFICIENT BMPS WITHIN SEVEN (7) DAYS OF BEING NOTIFIED BY THE SECONDARY PERMITTEE. WHEN THE PLAN IS AMENDED, THE PRIMARY PERMITTEE MUST NOTIFY AND PROVIDE A COPY OF THE AMENDMENT TO ALL AFFECTED SECONDARY PERMITTEES WITHIN THIS SEVEN (7) DAY PERIOD. THE SECONDARY PERMITTEE(S) MUST IMPLEMENT ANY NEW PLAN REQUIREMENTS AFFECTING THEIR SITE(S) WITHIN 48-HOURS OF NOTIFICATION BY THE PRIMARY PERMITTEE. NOTWITHSTANDING THE FOREGOING, THE PRIMARY OR TERTIARY PERMITTEE REMAINS RESPONSIBLE FOR INSURING THAT THE PLAN, AS APPROPRIATE, MEETS THE REQUIREMENTS OF THIS PERMIT.

PROPER OPERATION AND MAINTENANCE:

THE PERMITTEE SHALL AT ALL TIMES PROPERLY OPERATE AND MAINTAIN ALL FACILITIES AND SYSTEMS OF TREATMENT AND CONTROL (AND RELATED APPURTENANCES) WHICH ARE INSTALLED OR USED BY THE PERMITTEE TO ACHIEVE COMPLIANCE WITH THE CONDITIONS OF THIS PERMIT AND WITH THE REQUIRED PLANS. PROPER OPERATION AND MAINTENANCE ALSO INCLUDES ADEQUATE LABORATORY CONTROLS AND APPROPRIATE QUALITY ASSURANCE PROCEDURES. PROPER OPERATION AND MAINTENANCE REQUIRES THE OPERATION OF BACKUP OR AUXILIARY FACILITIES OR SIMILAR SYSTEMS, INSTALLED BY AN PERMITTEE ONLY WHEN NECESSARY TO ACHIEVE COMPLIANCE WITH THE CONDITIONS OF THE PERMIT.

EROSION AND SEDIMENT CONTROL MEASURES WILL BE MAINTAINED AT ALL TIMES. IF FULL IMPLEMENTATION OF THE APPROVED PLAN DOES NOT PROVIDE FOR EFFECTIVE EROSION AND SEDIMENT CONTROL, ADDITIONAL EROSION AND SEDIMENT CONTROL MEASURES SHALL BE IMPLEMENTED TO CONTROL OR TREAT THE SEDIMENT SOURCE.

REFER TO THE DETAILS CONTAINED WITHIN THIS PLAN SET FOR ADDITIONAL MAINTENANCE INSTRUCTION.

NON-STORM WATER DISCHARGES:

NON-STORM WATER DISCHARGES (DISCHARGES FROM FIRE FIGHTING ACTIVITIES, FIRE HYDRANT FLUSHING, POTABLE WATER SOURCES INCLUDING WATER LINE FLUSHING, IRRIGATION DRAINAGE, AIR CONDITIONING CONDENSATE, SPRINGS, UNCONTAMINATED GROUNDWATER, AND FOUNDATION OR FOOTING DRAINS WHERE FLOWS ARE NOT CONTAMINATED WITH PROCESS MATERIALS OR POLLUTANTS) THAT ARE COMBINED WITH STORM WATER DISCHARGES ASSOCIATED WITH CONSTRUCTION ACTIVITY SHALL BE DISCHARGED TO THE PROPOSED STORM DRAINAGE SYSTEM AND ROUTED THROUGH THE EROSION AND SEDIMENTATION CONTROLS IDENTIFIED WITHIN THIS PLAN. NOTIFY THE LICENSED PROFESSIONAL WHO PREPARED THIS PLAN IF THIS IS NOT POSSIBLE.

WASTE MATERIALS AND DISPOSAL

ALL WASTE MATERIALS SHALL BE COLLECTED AND STORED IN A SECURELY LIDDED METAL DUMPSTER OR OTHER APPROPRIATE WASTE MANAGEMENT FACILITY PERMISSIBLE UNDER GAR PERMIT NO. 100001. WASTE MANAGEMENT FACILITIES SHALL MEET ALL SOLID WASTE MANAGEMENT REGULATIONS. ALL TRASH AND CONSTRUCTION DEBRIS FROM THE SITE SHALL BE DEPOSITED IN THE WASTE MANAGEMENT FACILITIES. WASTE MANAGEMENT FACILITIES SHALL BE EMPTIED A MINIMUM OF ONCE PER WEEK OR MORE OFTEN IF NECESSARY AND TRASH SHALL BE HAULED AS REQUIRED BY LOCAL REGULATIONS. NO CONSTRUCTION WASTE SHALL BE

ALL PERSONNEL SHALL BE INSTRUCTED ON PROPER PROCEDURES FOR WASTE DISPOSAL. A NOTICE STATING THESE PRACTICES SHALL BE POSTED AT THE JOB SITE AND THE CONTRACTOR SHALL BE RESPONSIBLE FOR SEEING THAT THESE PROCEDURES ARE FOLLOWED.

LOCATE WASTE COLLECTION AREAS AWAY FROM STREETS, GUTTERS, WATERCOURSES AND STORM DRAINS. WASTE COLLECTION AREAS, SUCH AS DUMPSTERS, ARE OFTEN BEST LOCATED NEAR CONSTRUCTION SITE ENTRANCES TO MINIMIZE TRAFFIC ON DISTURBED SOILS.

HAZARDOUS WASTES:

ALL HAZARDOUS WASTE MATERIALS SHALL BE DISPOSED OF IN THE MANNER AS REQUIRED BY LOCAL, STATE, AND/OR FEDERAL REGULATIONS AND BY THE MANUFACTURER OF SUCH PRODUCTS. THE JOB SITE SUPERINTENDENT, WHO WILL ALSO BE RESPONSIBLE FOR SEEING THAT THESE PRACTICES ARE FOLLOWED, SHALL INSTRUCT SITE PERSONNEL IN THESE PRACTICES. MATERIAL SAFETY DATA SHEETS (MSDS'S) FOR EACH SUBSTANCE WITH HAZARDOUS PROPERTIES THAT IS USED ON THE JOB SITE SHALL BE OBTAINED AND USED FOR THE PROPER MANAGEMENT OF POTENTIAL WASTES THAT MAY RESULT FROM THESE PRODUCTS. AN MSDS SHALL BE POSTED IN THE IMMEDIATE AREA WHERE SUCH PRODUCT IS STORED AND/OR USED AND ANOTHER COPY OF EACH MSDS SHALL BE MAINTAINED IN THE EROSION SEDIMENTATION AND POLLUTION CONTROL PLAN (ESPCP) FILE AT THE JOB SITE CONSTRUCTION TRAILER OFFICE. EACH EMPLOYEE WHO HANDLES A SUBSTANCE WITH HAZARDOUS PROPERTIES WILL BE INSTRUCTED ON THE USE OF MSDS SHEETS AND THE SPECIFIC INFORMATION IN THE APPLICABLE MSDS FOR THE PRODUCT HE/SHE IS USING, PARTICULARLY REGARDING SPILL CONTROL TECHNIQUES.

THE CONTRACTOR WILL IMPLEMENT THE SPILL PREVENTION CONTROL AND COUNTERMEASURES (SPCC) PLAN FOUND WITHIN THIS ESPCP AND WILL TRAIN ALL PERSONNEL IN THE PROPER CLEANUP AND HANDLING OF SPILLED MATERIALS. NO SPILLED HAZARDOUS MATERIALS OR HAZARDOUS WASTES SHALL BE ALLOWED TO COME IN CONTACT WITH STORM WATER DISCHARGES. IF SUCH CONTACT OCCURS. THE STORM WATER DISCHARGE SHALL BE CONTAINED ON SITE UNTIL APPROPRIATE MEASURES IN COMPLIANCE WITH STATE AND FEDERAL REGULATIONS ARE TAKEN TO DISPOSE OF SUCH CONTAMINATED STORM WATER. IT SHALL BE THE RESPONSIBILITY OF THE JOB SITE SUPERINTENDENT TO PROPERLY TRAIN ALL PERSONNEL IN THE USE OF THE SPCC PLAN.

NOTHING IN THIS PERMIT SHALL BE CONSTRUED TO PRECLUDE THE INSTITUTION OF ANY LEGAL ACTION OR RELIEVE THE PERMITTEE FROM ANY RESPONSIBILITIES, LIABILITIES, OR PENALTIES TO WHICH THE PERMITTEE IS OR MAY BE SUBJECT UNDER THE GEORGIA HAZARDOUS WASTE MANAGEMENT ACT, O.C.G.A. § 12-8-60, ET SEQ. OR UNDER CHAPTER 14 OF TITLE 12 OF THE OFFICIAL CODE OF GEORGIA ANNOTATED; NOR IS THE OPERATOR RELIEVED FROM ANY RESPONSIBILITIES, LIABILITIES OR PENALTIES TO WHICH THE PERMITTEE IS OR MAY BE SUBJECT UNDER SECTION 311 OF THE CLEAN WATER ACT OR SECTION 106 OF COMPREHENSIVE ENVIRONMENTAL RESPONSE COMPENSATION AND LIABILITY ACT.

SANITARY WASTES:

ALL PERMITTEES SHALL ENSURE THAT THIS PLAN IS IN COMPLIANCE WITH APPLICABLE STATE AND/OR LOCAL WASTE DISPOSAL, SANITARY SEWER, OR SEPTIC SYSTEM REGULATIONS.

A MINIMUM OF ONE PORTABLE SANITARY UNIT SHALL BE PROVIDED FOR EVERY TEN (10) WORKERS ON THE SITE. ALL SANITARY WASTE SHALL BE COLLECTED FROM THE PORTABLE UNITS A MINIMUM OF ONE TIME PER WEEK BY A LICENSED PORTABLE FACILITY PROVIDER IN COMPLETE COMPLIANCE WITH THE LOCAL STATE REGULATIONS.

ALL SANITARY WASTE UNITS SHALL BE LOCATED IN AN AREA WHERE THE LIKELIHOOD OF THE UNIT CONTRIBUTING TO STORM WATER DISCHARGE IS NEGLIGIBLE. ADDITIONAL CONTAINMENT OF BMP'S SHALL BE IMPLEMENTED AS NECESSARY, SUCH AS GRAVEL BAGS OR SPECIFICALLY DESIGNED PLASTIC SKID CONTAINERS AROUND THE BASE, TO PREVENT WASTE FROM CONTRIBUTING TO STORM WATER DISCHARGES. THE LOCATION OF SANITARY WASTE UNITS MUST BE IDENTIFIED ON THE EROSION CONTROL PLAN GRADING PHASE BY THE CONTRACTOR ONCE THE LOCATIONS HAVE BEEN DETERMINED.

OFFSITE VEHICLE TRACKING / DUST CONTROL

OFF-SITE VEHICLE TRACKING OF DIRT, SOILS, AND SEDIMENTS AND THE GENERATION OF DUST SHALL BE MINIMIZED OR ELIMINATED TO THE MAXIMUM EXTENT PRACTICAL. A STABILIZED CONSTRUCTION EXIT (CO) SHALL BE PROVIDED TO REDUCE VEHICLE TRACKING OF SEDIMENT. SEE ESPCP PLAN AND DETAIL SHEETS FOR THE CONSTRUCTION EXIT LOCATIONS AND DETAIL. THE PAVED STREET ADJACENT TO THE CONSTRUCTION EXIT SHALL BE INSPECTED DAILY BY A REPRESENTATIVE OF THE SITE CONTRACTOR FOR TRACKING OF MUD. DIRT. OR ROCK. DUMP TRUCKS HAULING MATERIAL FROM THE CONSTRUCTION SITE SHALL BE COVERED WITH A TARPAULIN. DUST CONTROL (DU) SHALL BE APPLIED AS NECESSARY TO PREVENT SURFACE AND AIR MOVEMENT OF DUST.

INVENTORY FOR POLLUTION PREVENTION PLAN

THE FOLLOWING MATERIALS ARE EXPECTED TO BE ONSITE DURING CONSTRUCTION: CONCRETE PRODUCTS, ASPHALT, PETROLEUM BASED FUELS AND LUBRICANTS FOR EQUIPMENT, TAR, METAL BUILDING MATERIALS, LUMBER, SHEET ROCK, FLOOR COVERINGS, ELECTRICAL WIRE AND FIXTURES, PAINTS/STAINS/FINISHING TREATMENTS, PAINT SOLVENTS, ADDITIVES FOR SOIL STABILIZATION, CLEANING SOLVENTS, PESTICIDES, FERTILIZERS. HERBICIDES. CRUSHED STONE. PLASTIC AND METAL PIPES.

SPILL PREVENTION

PRACTICES SUCH AS GOOD HOUSEKEEPING, PROPER HANDLING OF HAZARDOUS PRODUCTS AND PROPER SPILL CONTROL PRACTICES WILL BE FOLLOWED TO REDUCE THE RISK OF SPILLS AND SPILLS FROM DISCHARGING INTO STORM WATER RUNOFF.

GOOD HOUSEKEEPING

QUANTITIES OF PRODUCTS STORED ONSITE WILL BE LIMITED TO THE AMOUNT NEEDED FOR THE JOB.

- A. PRODUCTS AND MATERIALS WILL BE STORED IN A NEAT, ORDERLY MANNER IN APPROPRIATE CONTAINERS PROTECTED FROM RAINFALL, WHERE POSSIBLE.
- B. PRODUCTS WILL BE KEPT IN THEIR ORIGINAL CONTAINERS WITH MANUFACTURER LABELS LEGIBLE AND VISIBLE.
- C. PRODUCT MIXING, PRODUCT DISPOSAL, AND DISPOSAL OF PRODUCT CONTAINERS WILL BE ACCORDING TO THE MANUFACTURER'S RECOMMENDATIONS.
- D. THE CONTRACTOR WILL INSPECT SUCH MATERIALS TO ENSURE PROPER USE, STORAGE AND DISPOSAL.

EROSION, SEDIMENTATION, AND POLLUTION CONTROL PLAN GENERAL NOTES (IN CONFORMANCE WITH STATE OF GEORGIA GENERAL NPDES PERMIT NO. GAR 100001)

PRODUCT SPECIFIC PRACTICES

PETROLEUM BASED PRODUCTS - CONTAINERS FOR PRODUCTS SUCH AS FUELS, LUBRICANTS AND TARS WILL BE INSPECTED DAILY FOR LEAKS AND SPILLS. THIS INCLUDES ON-SITE VEHICLE AND MACHINERY DAILY INSPECTIONS AND REGULAR PREVENTATIVE MAINTENANCE OF SUCH EQUIPMENT. EQUIPMENT MAINTENANCE AREAS WILL BE LOCATED AWAY FROM STATE WATER, NATURAL DRAINS AND STORM WATER DRAINAGE INLETS. IN ADDITION, TEMPORARY FUELING TANKS SHALL HAVE A SECONDARY CONTAINMENT LINER TO PREVENT/MINIMIZE SITE CONTAINMENT. DISCHARGE OF OILS, FUELS AND LUBRICANTS IS PROHIBITED. PROPER DISPOSAL METHODS WILL INCLUDE COLLECTION IN A SUITABLE CONTAINER AND DISPOSAL AS REQUIRED BY LOCAL AND STATE REGULATIONS.

PAINTS/FINISHES/SOLVENTS - ALL PRODUCTS WILL BE STORED IN TIGHTLY SEALED ORIGINAL CONTAINERS WHEN NOT IN USE. EXCESS PRODUCT WILL NOT BE DISCHARGED INTO THE STORM WATER COLLECTION SYSTEM. EXCESS PRODUCT, MATERIALS USED WITH THESE PRODUCTS, AND PRODUCT CONTAINERS WILL BE DISPOSED ACCORDING TO MANUFACTURER'S SPECIFICATIONS AND RECOMMENDATIONS.

CONCRETE/MASONRY - NO CONCRETE TRUCKS WILL BE ALLOWED TO WASH OUT OR DISCHARGE SURPLUS CONCRETE OR DRUM WASH WATER ON SITE. THE CONCRETE PROVIDER HAS RESPONSIBILITY TO ENSURE APPROPRIATE TRAINING HAS BEEN PROVIDED TO THEIR TRUCK DRIVERS, AND MUST PROVIDE APPROPRIATE DETAILS AND RESOURCES TO ENABLE THEM TO COMPLETE A DELIVERY WITHOUT CAUSING POLLUTION. CHUTES BARRELS, WHEELBARROWS AND OTHER EQUIPMENT MUST BE RINSED IN THE SITE WASH-DOWN AREA. SWEEP OR SHOVEL ANY SPILLS THAT OCCUR AND ALLOW RESIDUE TO SET BEFORE REMOVING. THE HARDENED RESIDUE MAY THEN BE PLACED IN A DESIGNATED CONCRETE/MASONRY RECYCLING BIN ON SITE. DO NOT WASH CONCRETE/MASONRY INTO STORM DRAINS, OPEN DITCHES, STREETS, OR STREAMS. TRUCKS SHOULD NOT TRACK ANY CONCRETE OR MUD AND SEDIMENT OFF SITE.

FERTILIZER/HERBICIDES - THESE PRODUCTS WILL BE APPLIED AT RATES THAT DO NOT EXCEED THE MANUFACTURER'S SPECIFICATIONS, THE CROP ESTABLISHMENT GUIDELINES, OR THE SPECIFICATIONS CONTAINED WITHIN THE GSWCC MANUAL FOR EROSION AND SEDIMENT CONTROL IN GEORGIA.

SPILL PREVENTION CONTROL AND COUNTERMEASURES (SPCC) PLAN:

- A. LOCAL, STATE, AND MANUFACTURER'S RECOMMENDED METHODS FOR SPILL CLEANUP SHALL BE CLEARLY POSTED AND PROCEDURES SHALL BE MADE AVAILABLE TO SITE PERSONNEL
- MATERIAL AND EQUIPMENT NECESSARY FOR SPILL CLEANUP SHALL BE KEPT IN THE MATERIAL STORAGE AREAS. TYPICAL MATERIALS AND EQUIPMENT INCLUDES, BUT IS NOT LIMITED TO, BROOMS, DUSTPANS, MOPS, RAGS, GLOVES, GOGGLES, CAT LITTER, SAND, SAWDUST, AND PROPERLY LABELED PLASTIC AND METAL WASTE CONTAINERS.
- C. SPILL PREVENTION PRACTICES AND PROCEDURES SHALL BE REVIEWED AFTER A SPILL AND ADJUSTED AS NECESSARY TO PREVENT FUTURE SPILLS.
- D. ALL SPILLS WILL BE CLEANED IMMEDIATELY UPON DISCOVERY. ALL SPILLS SHALL BE REPORTED AS REQUIRED BY LOCAL, STATE AND FEDERAL REGULATIONS.
- E. THE DISCHARGE OF HAZARDOUS SUBSTANCES OR OIL IN THE STORM WATER DISCHARGE(S) FROM A SITE SHALL BE PREVENTED.
- F. WHERE A RELEASE CONTAINING A HAZARDOUS SUBSTANCE IN AN AMOUNT EQUAL TO OR IN EXCESS OF A REPORTING QUANTITY ESTABLISHED UNDER EITHER GEORGIA'S OIL OR HAZARDOUS MATERIAL SPILLS OR RELEASES ACT (O.C.G.A. SEC. 12-14-2, ET SEQ.), 40 CFR 117, OR 40 CFR 302 OCCURS DURING A 24-HOUR PERIOD, THE PERMITTEE IS REQUIRED TO NOTIFY EPD AT (404) 656-4863 OR (800) 241-4113 AND THE NATIONAL RESPONSE CENTER (NRC) AT (800) 424-8802 IN ACCORDANCE WITH THE REQUIREMENTS OF GEORGIA'S OIL OR HAZARDOUS MATERIAL SPILLS OR RELEASES ACT (O.C.G.A. SEC. 12-14-2, ET SEQ.), 40 CFR 117, AND 40 CFR 302 AS SOON AS HE HAS KNOWLEDGE OF THE DISCHARGE.
- G. FOR SPILLS THAT IMPACT SURFACE WATER (LEAVE A SHEEN ON SURFACE WATER) OR SPILLS OF AN UNKNOWN AMOUNT. THE NATIONAL RESPONSE CENTER (NRC) SHALL BE CONTACTED WITHIN 24 HOURS AT (800) 424-8802.
- H. FOR SPILLS GREATER THAN 25 GALLONS AND NO SURFACE WATER IMPACTS, THE GEORGIA EPD SHALL BE CONTACTED WITHIN 24 HOURS AT (404) 656-4863 OR (800) 241-4113.
- FOR SPILLS LESS THAN 25 GALLONS AND NO SURFACE WATER IMPACTS, THE SPILL SHALL BE CLEANED AND LOCAL AGENCIES SHALL BE CONTACTED AS REQUIRED.
- GENERAL NPDES PERMIT NO. GAR 100002 DOES NOT AUTHORIZE THE DISCHARGE OF HAZARDOUS SUBSTANCES OR OIL RESULTING FROM AN ON-SITE SPILL

THE CONTRACTOR SHALL NOTIFY THE LICENSED PROFESSIONAL WHO PREPARED THIS PLAN IF MORE THAN 1,320 GALLONS OF PETROLEUM IS STORED ONSITE (THIS INCLUDES CAPACITIES OF EQUIPMENT) OR IF ANY ONE PIECE OF EQUIPMENT HAS A CAPACITY GREATER THAN 660 GALLONS. THE CONTRACTOR WILL NEED A SPILL PREVENTION CONTAINMENT AND COUNTERMEASURES PLAN PREPARED BY A LICENSED PROFESSIONAL

> DESIGN PROFESSIONAL DAVID MORGAN, P.E. LEVEL II CERTIFICATION No.: 0000011643 EXPIRES: 06/03/2024



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CLIENT INFORMATION

FAYETTE COUNTY 140 STONEWALL AVE W, STE 203 FAYETTEVILLE, GA. 30214

PROJECT NAME

DOWNING COURT CULVERT REPLACEMENT

FAYETTE COUNTY, GA

DRAWING ISSUE

DESIGNED BY: MDW DRAWN BY DMM/MDM CHECKED BY: SUBMITTED BY: DATE: SEPTEMBER 1, 2022 PROJECT# 1210495

SHEET TITLE

EROSION AND SEDIMENT CONTROL **NOTES**

SHEET NUMBER

CE002

SHEET 9 OF 16 ORIGINAL SHEET SIZE:

22" X 34"

CE-003 Y of the year in which the land-disturbing activity was permitted. (The completed Checklist must be submitted with the ES&PC Plan or the Plan will not be reviewed) CE-001 Y 2 Level II certification number issued by the Commission, signature and seal of the certified design professional. (Signature, seal and level II number must be on each sheet pertaining to ES&PC Plan or the Plan will not be reviewed) N/A N/A 3 The name and phone number of the 24-hour contact responsible for erosion, sedimentation and pollution controls. CE-001 4 Provide the name, address, email address, and phone number of primary permittee. CE-001 5 Note total and disturbed acreages of the project or phase under construction. CE-001 6 Provide the GPS locations of the beginning and end of the Infrastructure project. Give the Latitude and Longitude in

CE-001 8 Descriptions of the nature of construction activity and existing site conditions. CE-001 Υ 9 Provide vicinity map showing site's relation to surrounding areas. Include designation of specific phase, if necessary. CE-001 10 Identify the project receiving waters and describe all sensitive adjacent areas including streams, lakes, residential areas, wetlands, marshlands, etc. which may be affected. CE-001 Y 11 Design professional's certification statement and signature that the site was visited prior to development of the ES&PC Plan as stated on Part IV page 21 of the permit

7 Initial date of the Plan and the dates of any revisions made to the Plan including the entity who requested the revisions.

12 Design professional's certification statement and signature that the permittee's ES&PC Plan provides for an appropriate and comprehensive system of BMPs and sampling to meet permit requirements as stated on Part IV page 20 of the permit. * N/A | N/A | 13 Design professional certification statement and signature that the permittee's ES&PC Plan provides for representative sampling as stated on Part IV.D.6.c.(3) page 37 of the permit as applicable. * 14 Clearly note the statement that "The design professional who prepared the ES&PC Plan is to inspect the installation of the initial sediment storage requirements, perimeter control BMPs, and sediment basins within 7 days after installation." in accordance with Part IV.A.5 page 26 of the permit. * CE-001 Y 15 Clearly note the statement that "Non-exempt activities shall not be conducted within the 25 or 50-foot undisturbed stream buffers as measured from the point of wrested vegetation or within 25-feet of the coastal marshland buffer as measured

16 Provide a description of any buffer encroachments and indicate whether a buffer variance is required. Υ N/A 17 Clearly note the statement that "Amendments/revisions to the ES&PC Plan which have a significant effect on BMPs with a hydraulic component must be certified by the design professional." * 18 Clearly note the statement that "Waste materials shall not be discharged to waters of the State, except as authorized by a

from the Jurisdictional Determination Line without first acquiring the necessary variances and permits."

		sediment control measures and practices prior to land disturbing activities."	
OF 224	.,		
CE-001	Y	20 Clearly note statement that "Erosion control measures will be maintained at all times. If full implementation of the approved Plan does not provide for effective erosion control, additional erosion and sediment control measures shall be implemented	_
		to control or treat the sediment source."	
CE-001	Υ	21 Clearly note the statement "Any disturbed area left exposed for a period greater than 14 days shall be stabilized with mulch	
CL-001	'	or temporary seeding."	
N/A	N/A	22 Any construction activity which discharges storm water into an Impaired Stream Segment, or within 1 linear mile upstream	
,	,	of and within the same watershed as, any portion of a Biota Impaired Stream Segment must comply with Part III. C. of the	
		permit. Include the completed Appendix 1 listing all the BMPs that will be used for those areas of the site which discharge	
		to the Impaired Stream Segment. *	
N/A	N/A	23 If a TMDL Implementation Plan for sediment has been finalized for the Impaired Stream Segment (identified in item 22	
		above) at least six months prior to submittal of NOI, the ES&PC Plan must address any site-specific conditions or	
		requirements included in the TMDL Implementation Plan. *	
N/A	N/A	24 BMPs for concrete washdown of tools, concrete mixer chutes, hoppers and the rear of the vehicles. Washout of the drum	
		at the construction site is prohibited. *	
CE-002	Υ	25 Provide BMPs for the remediation of all petroleum spills and leaks.	
N/A	N/A	26 Description of the measures that will be installed during the construction process to control pollutants in storm water that	
		will occur after construction operations have been completed. *	
N/A	N/A	27 Description of practices to provide cover for building materials and building products on site. *	
N/A	N/A	28 Description of the practices that will be used to reduce the pollutants in storm water discharges. *	
CE-001	Υ	29 Description and chart or timeline of the intended sequence of major activities which disturb soils for the major portions of	
		the site (i.e., initial perimeter and sediment storage BMPs, clearing and grubbing activities, excavation activities, utility	
		activities, temporary and final stabilization).	
N/A	N/A	30 Provide complete requirements of Inspections and record keeping by the primary permittee. *	
N/A	N/A	31 Provide complete requirements of Sampling Frequency and Reporting of sampling results. *	
N/A	N/A	32 Provide complete details for Retention of Records as per Part IV.F. of the permit. *	
N/A	N/A	33 Description of analytical methods to be used to collect and analyze the samples from each location. *	
N/A	N/A	34 Appendix B rationale for NTU values at all outfall sampling points where applicable. *	
N/A	N/A	35 Delineate all sampling locations, perennial and intermittent streams and other water bodies into which storm water is	
		discharged also provide a summary chart of the justification and analysis for the representative sampling as applicable. *	
N/A	N/A	36 A description of appropriate controls and measures that will be implemented at the construction site including: (1) initial	
		sediment storage requirements and perimeter control BMPs, (2) intermediate grading and drainage BMPs, and (3) final	
		BMPs. For construction sites where there will be no mass grading and the initial perimeter control BMPs,	
		intermediate grading and drainage BMPs, and final BMPs are the same, the Plan may combine all of the BMPs into a single	
		phase. *	
CE Plan	Υ	37 Graphic scale and North arrow.	

38 Existing and proposed contour lines with contour lines drawn at an interval in accordance with the following:

Existing Contours USGS 1": 2000' Topographical Sheets

Proposed Contours 1": 400' Centerline Profile

CE-001 Y 19 Clearly note statement that "The escape of sediment from the site shall be prevented by the installation of erosion and

		Effective January 1, 2022
		but within 200 ft of a perennial stream, the * checklist items would be N/A.
		* If using this checklist for a project that is less than 1 acre and not part of a common development
		will take place and for the appropriate geographic region of Georgia.
CE-502	ı Y	seeding, fertilizer, lime and mulching rates. Vegetative plan shall be site specific for appropriate time of year that seeding
CE-502	Y	52 Provide vegetative plan, noting all temporary and permanent vegetative practices. Include species, planting dates and
CE plan	Y	the Manual for Erosion and Sediment Control in Georgia.
CE plan		51 Provide detailed drawings for all structural practices. Specifications must, at a minimum, meet the guidelines set forth in
CE Plan	Υ	Sediment Control in Georgia. Use uniform coding symbols from the Manual, Chapter 6, with legend.
or Die :-	V	50 Location of Best Management Practices that are consistent with and no less stringent than the Manual for Erosion and
		the surface are not feasible, a written justification explaining this decision must be included in the Plan.
		when using equivalent controls. When discharging from sediment basins and impoundments, permittees are required to utilize outlet structures that withdraw water from the surface, unless infeasible. If outlet structures that withdraw water from
		included for structural BMPs and all calculations used by the design professional to obtain the required sediment storage
		justification as to why 67 cubic yards of storage is not attainable must also be given. Worksheets from the Manual must be
		must be included in the Plan for each common drainage location in which a sediment basin is not provided. A written
		achieved. A written justification explaining the decision to use equivalent controls when a sediment basin is not attainable
CE-301		volume must be in place prior to and during all land disturbance activities until final stabilization of the site has been
CE-201		retrofitted detention pond, and/or excavated inlet sediment traps for each common drainage location. Sediment storage
CE-101	Υ	49 Provide a minimum of 67 cubic yards of sediment storage per acre drained using a temporary sediment basin,
CE Plan	Υ	48 The limits of disturbance for each phase of construction.
CE-001	Y	47 Soil series for the project site and their delineation.
		Identify/Delineate all storm water discharge points.
N/A	N/A	46 Storm-drain pipe and weir velocities with appropriate outlet protection to accommodate discharges without erosion.
		completed.
CE-Plan	Y	45 An estimate of the runoff coefficient or peak discharge flow of the site prior to and after construction activities are
N/A	N/A	44 Delineate on-site drainage and off-site watersheds using USGS 1" :2000' topographical sheets.
CE Plan	Y	43 Delineation and acreage of contributing drainage basins on the project site.
CE Plan	Υ	42 Delineation of on-site wetlands and all State waters located on and within 200 feet of the project site.
se i idil	'	required by the Local Issuing Authority. Clearly note and delineate all areas of impact.
CE Plan	Υ	41 Delineation of the applicable 25-foot or 50-foot undisturbed buffers adjacent to State waters and any additional buffers
-, , .	, , ,	Erosion & Sediment Control in Georgia 2016 Edition. *
N/A	N/A	40 Use of alternative BMP for application to the Equivalent BMP List. Please refer to Appendix A-2 of the Manual for
		Commission). Please refer to the Alternative BMP Guidance Document found at www.gaswcc.georgia.gov.
		as certified by a Design Professional (unless disapproved by GAEPD or the Georgia Soil and Water Conservation

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CLIENT INFORMATION

FAYETTE COUNTY 140 STONEWALL AVE W, STE 203 FAYETTEVILLE, GA. 30214

PROJECT NAME

DOWNING COURT **CULVERT** REPLACEMENT

FAYETTE COUNTY, GA

DRAWING ISSUE

DESIGNED BY: DATE: SEPTEMBER 1, 2022 PROJECT#

SHEET TITLE

EROSION AND SEDIMENT CONTROL NOTES

SHEET NUMBER


CE003

22" X 34"

В

С

JANUARY 1, 2023

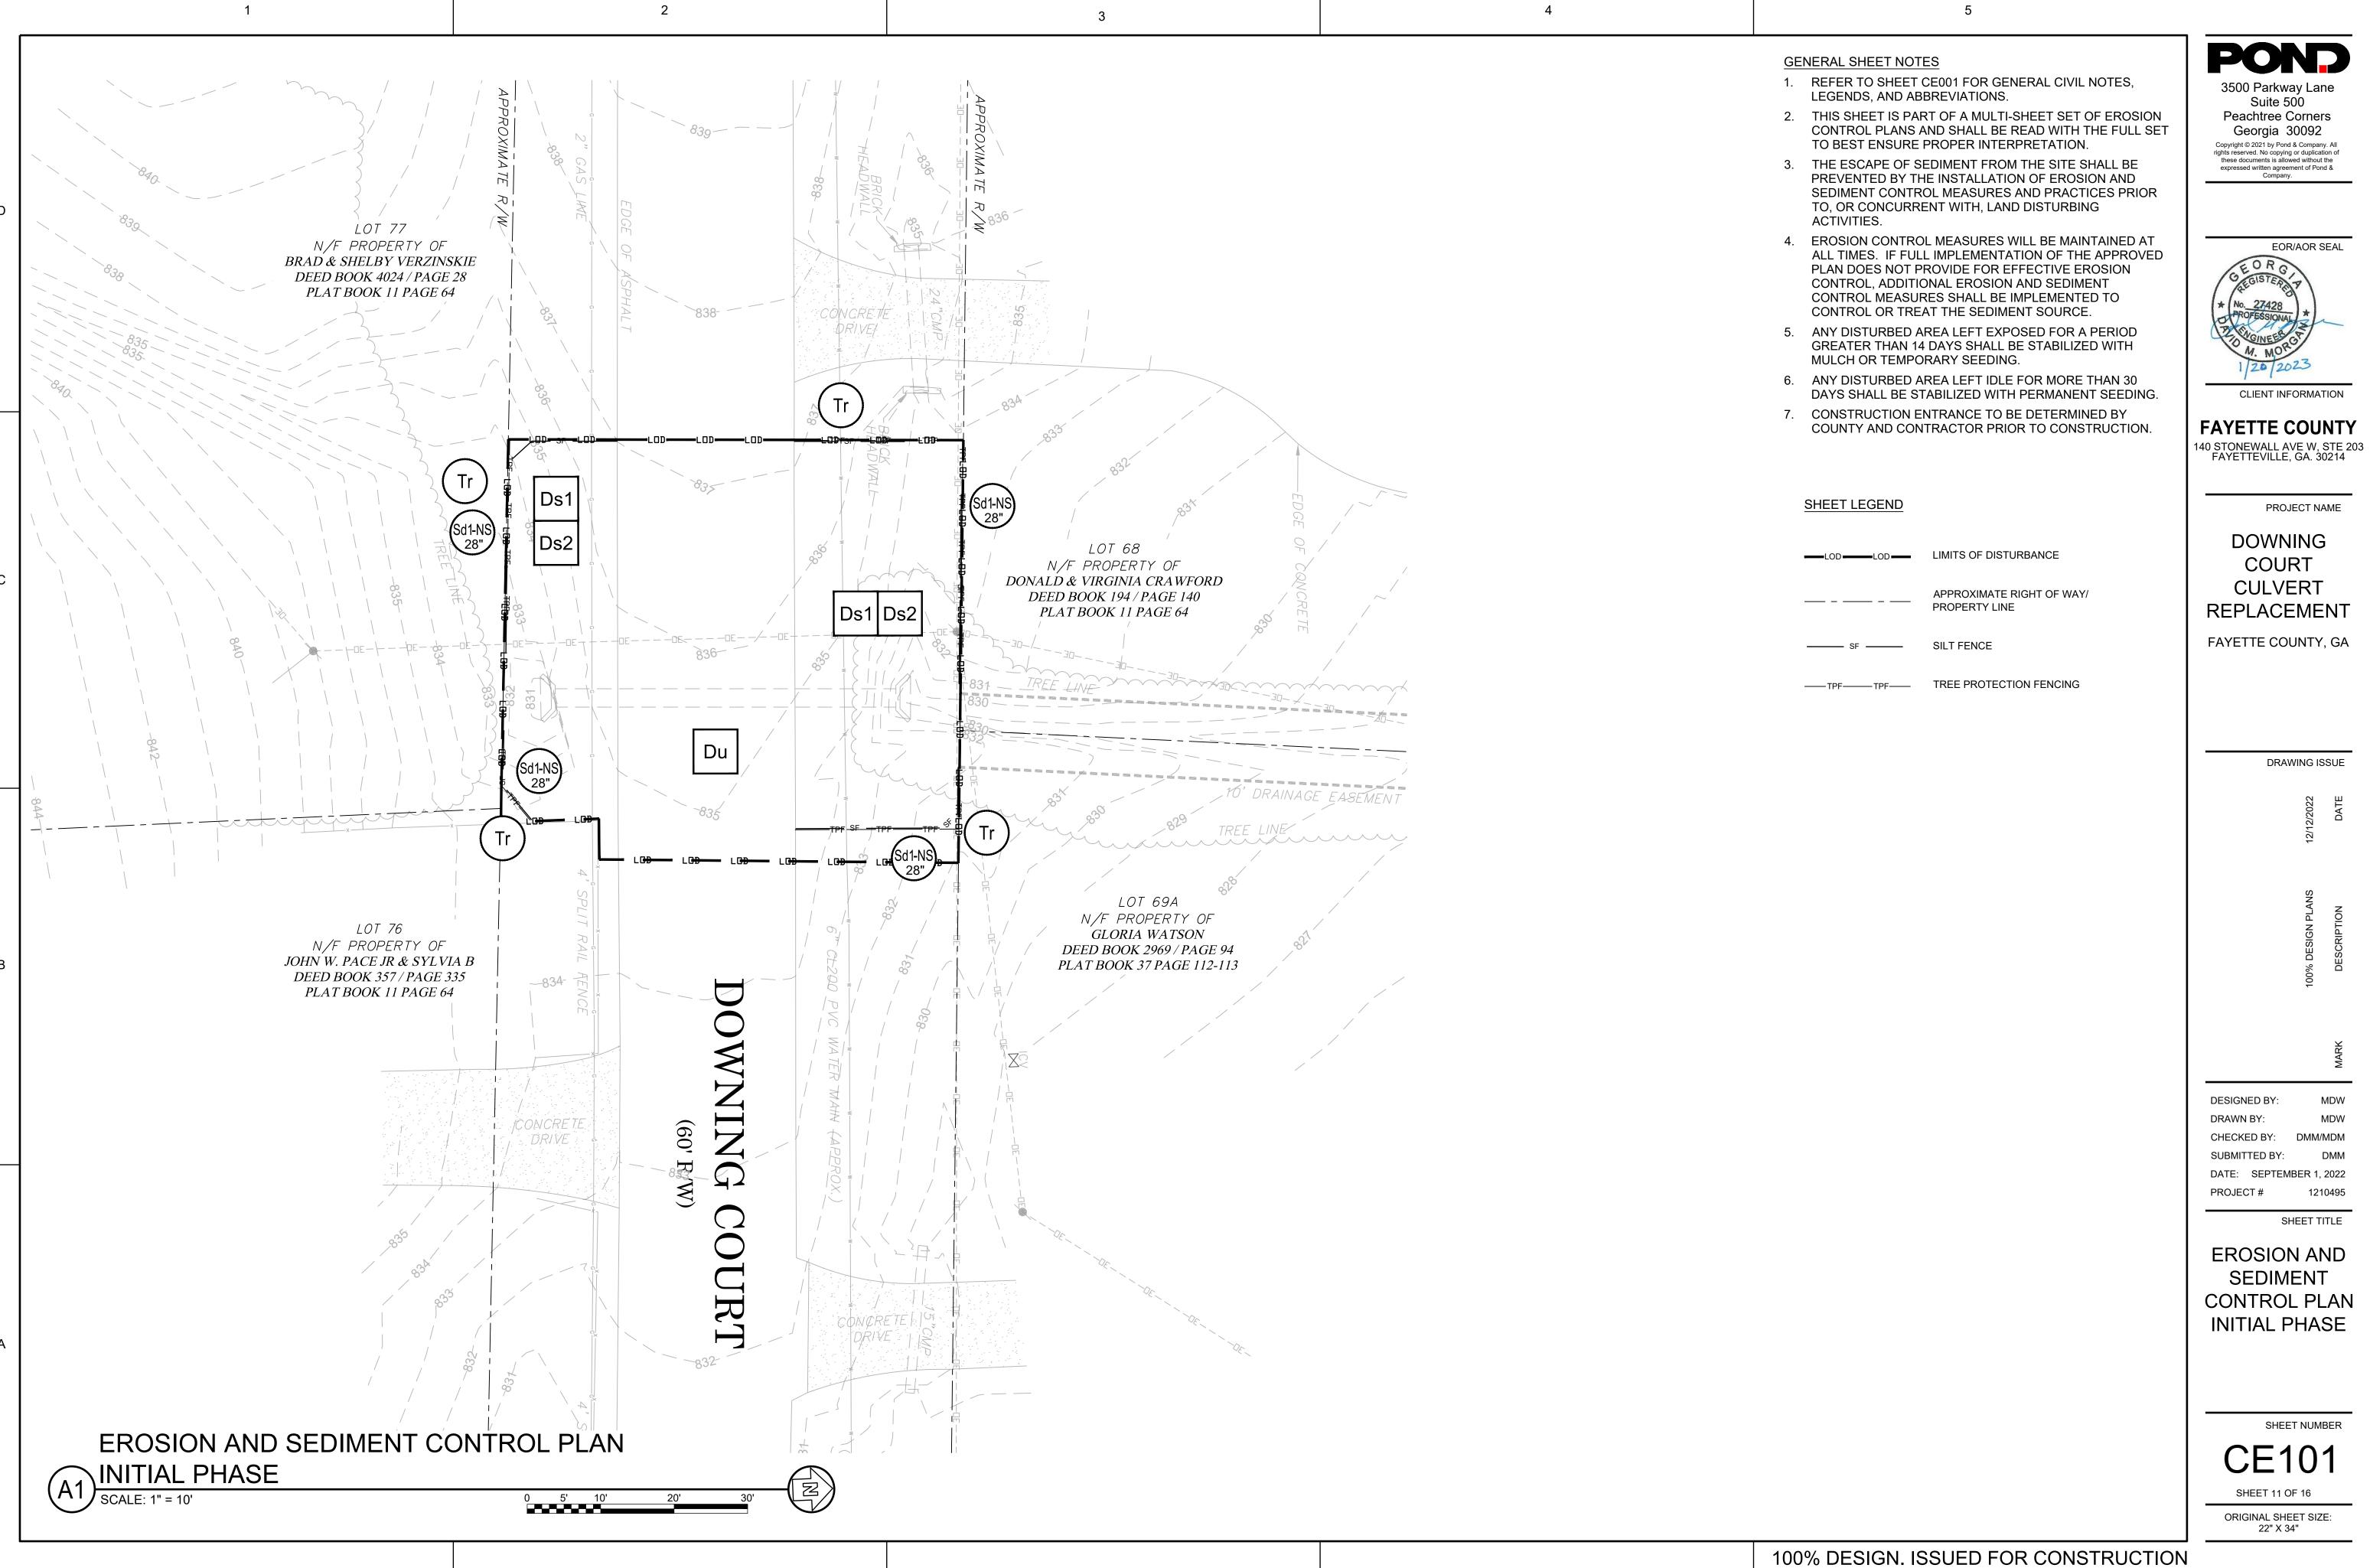

3500 Parkway Lane Suite 500

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FAYETTE COUNTY

PROJECT NAME

DOWNING COURT **CULVERT** REPLACEMENT

FAYETTE COUNTY, GA

DRAWING ISSUE


DESIGNED BY:

SHEET TITLE

EROSION AND SEDIMENT CONTROL PLAN **INITIAL PHASE**

SHEET NUMBER

CE101

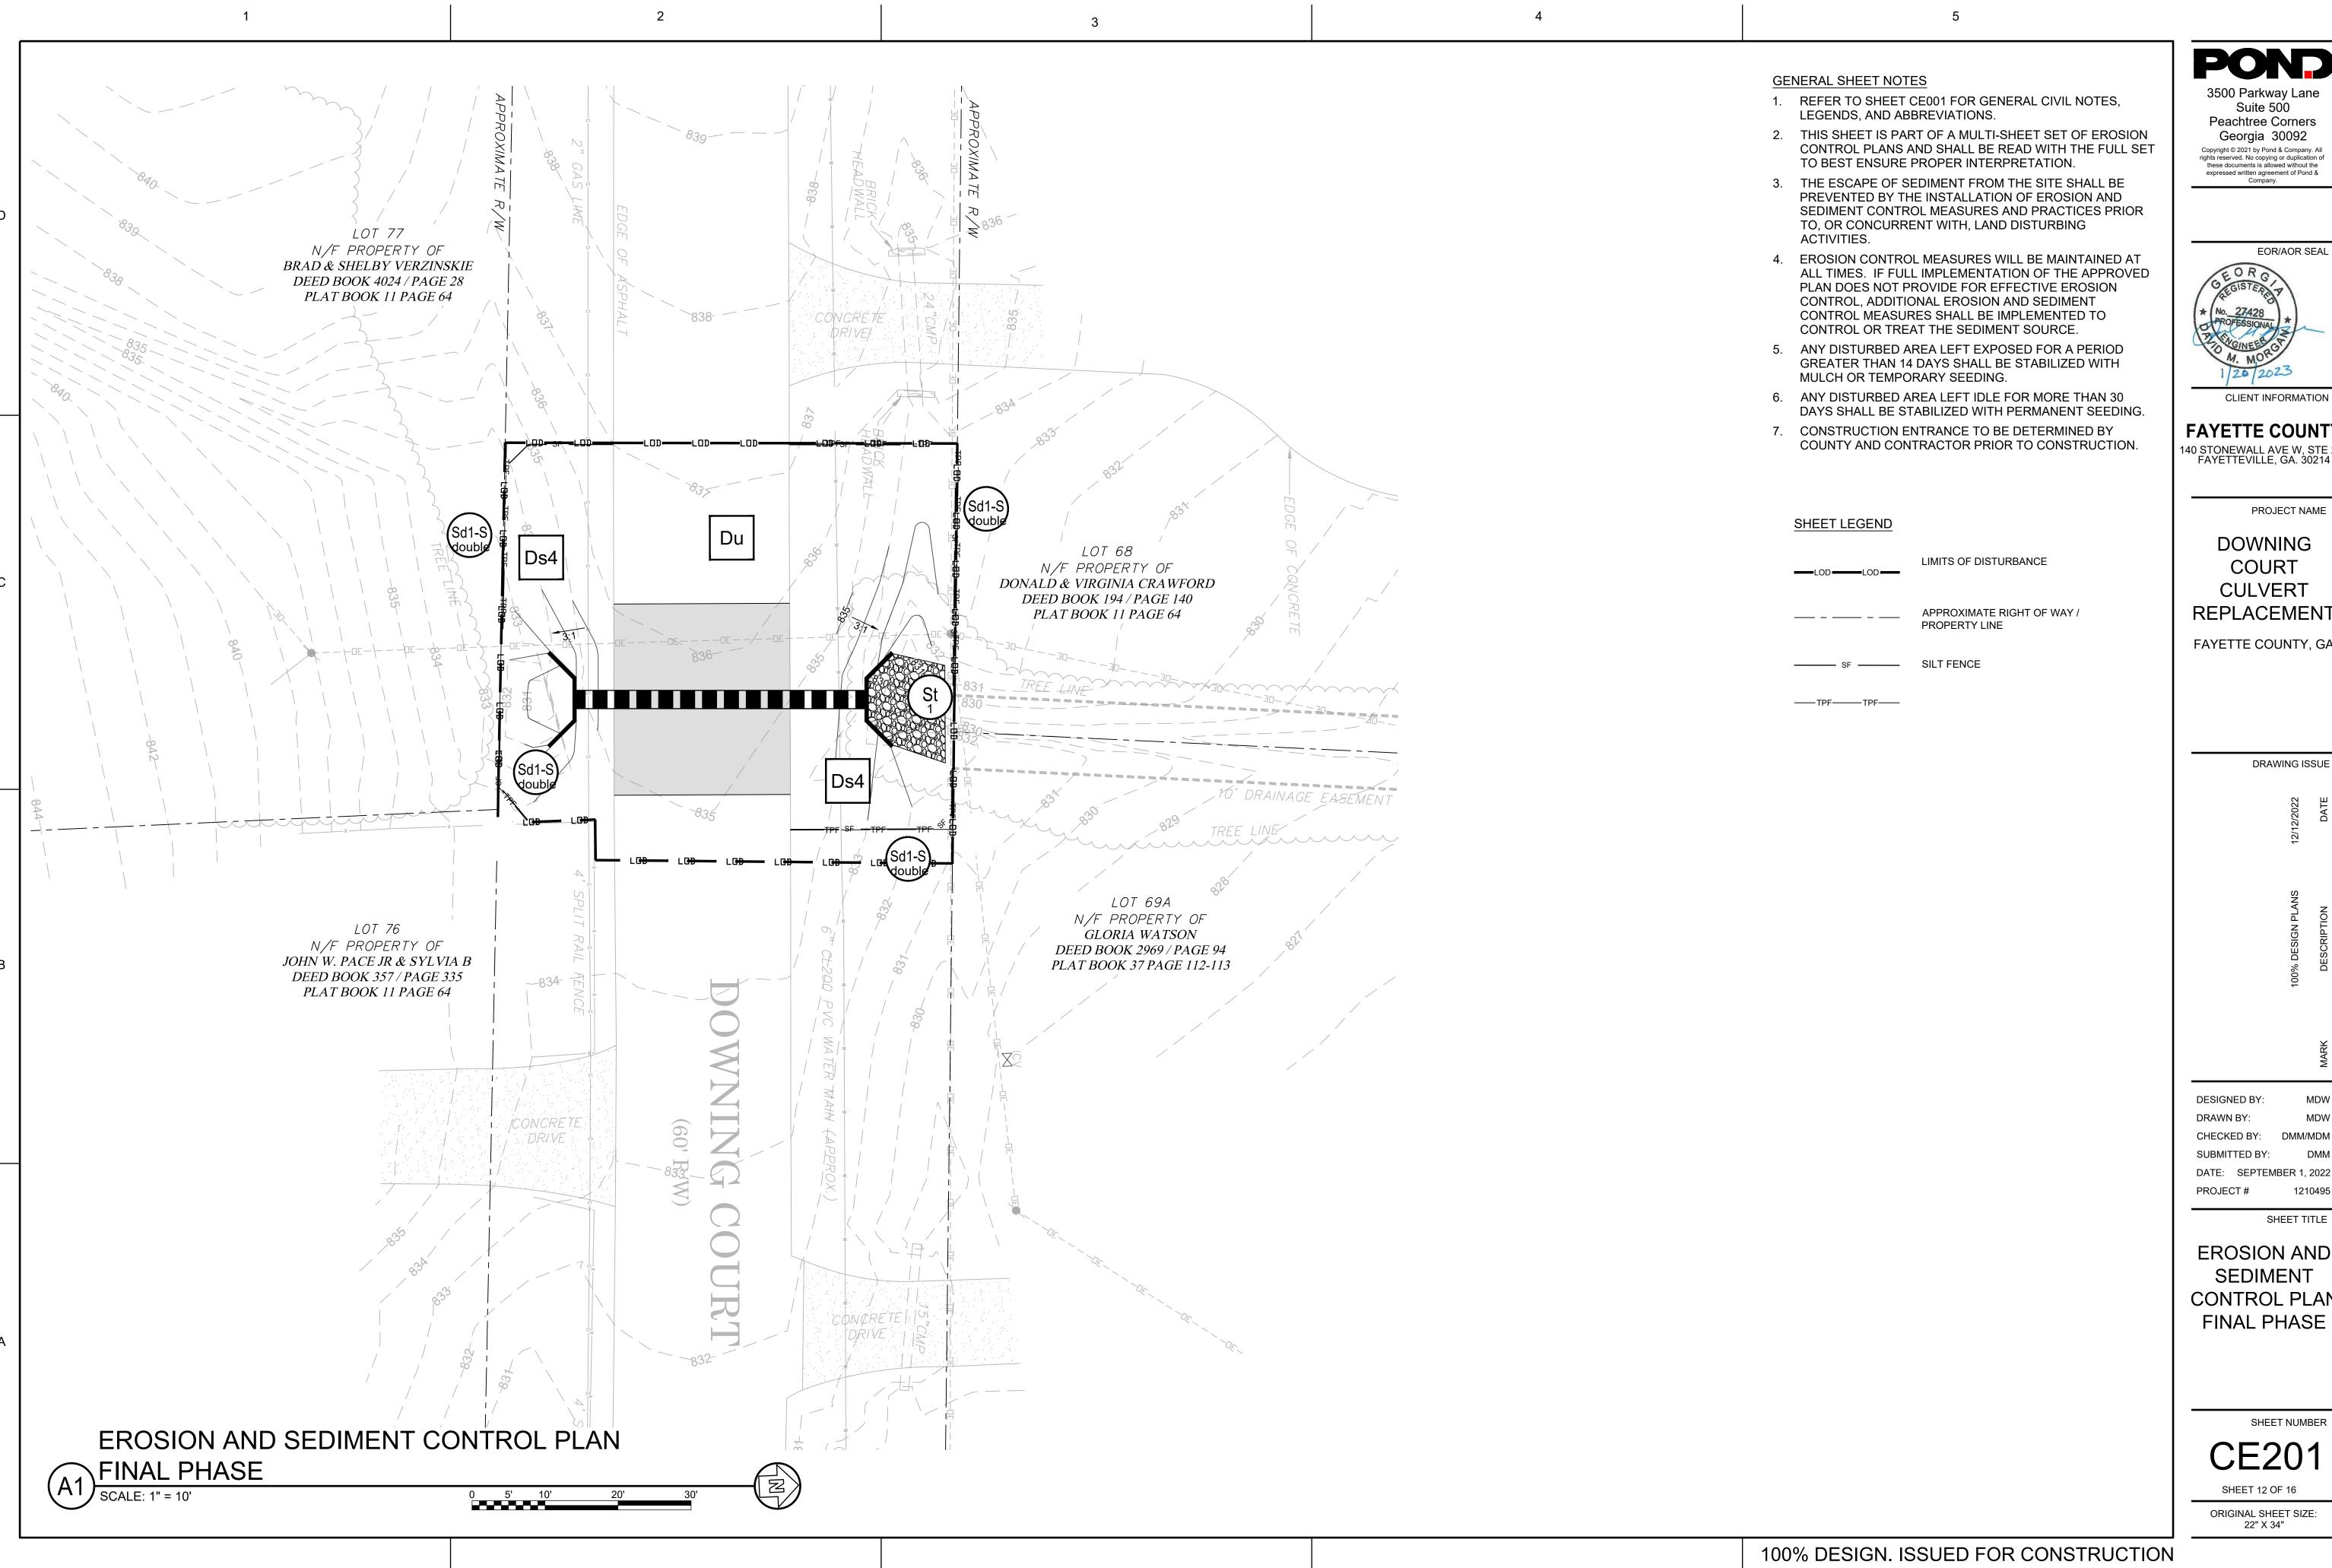

FAYETTE COUNTY 140 STONEWALL AVE W, STE 203 FAYETTEVILLE, GA. 30214

Suite 500

EOR/AOR SEAL

PROJECT NAME

DOWNING COURT **CULVERT** REPLACEMENT

FAYETTE COUNTY, GA

DRAWING ISSUE

DESIGNED BY:

SHEET TITLE

EROSION AND SEDIMENT CONTROL PLAN FINAL PHASE

SHEET NUMBER

CE201

ORIGINAL SHEET SIZE:

22" X 34"

CLIENT INFORMATION

FAYETTE COUNTY

140 STONEWALL AVE W, STE 203 FAYETTEVILLE, GA. 30214

PROJECT NAME

DOWNING COURT **CULVERT** REPLACEMENT

FAYETTE COUNTY, GA

DRAWING ISSUE

DESIGNED BY: DRAWN BY: CHECKED BY: SUBMITTED BY: DATE: SEPTEMBER 1, 2022

SHEET TITLE


EROSION AND SEDIMENT CONTROL **DETAILS**

PROJECT#

SHEET NUMBER

SHEET 13 OF 16 ORIGINAL SHEET SIZE: 22" X 34"

SILT FENCE - TYPE A and B

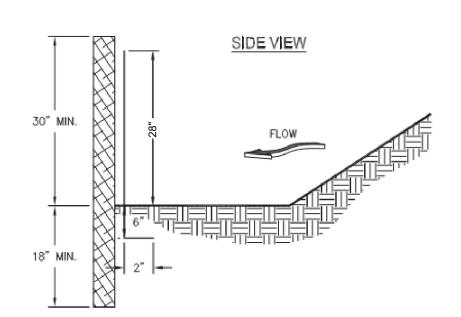

FRONT VIEW — 6' мах. о.с. — -TRENCH_

NOTES:

1. USE STEEL OR WOOD POSTS OR AS SPECIFIED BY THE EROSION, SEDIMENTATION, AND POLLUTION CONTROL PLAN.

2. HEIGHT (*) IS TO BE SHOWN ON THE EROSION, SEDIMENTATION, AND POLLUTION

TYPE 'NS' SILT FENCE

METHODS AND MATERIALS

A. TEMPORARY METHODS

MULCHES SEE MULCHING. SYNTHETIC RESINS MAY BE USED INSTEAD OF ASPHALT TO BIND MULCH MATERIAL.

 $\frac{\text{SPRAY-ON ADHESIVES}}{\text{THESE ARE USED ON MINERALS SOILS. KEEP TRAFFIC OFF THESE AREAS.}}$

<u>SPRINKLING</u>
THE SITE IS SPRINKLED WITH WATER UNTIL THE SURFACE IS WET. REPEAT AS NEEDED. THIS METHOD IS ESPECIALLY EFFECTIVE ON HAUL ROADS AND OTHER TRAFFIC ROUTES.


SOLID BOARD FENCES, BURLAP FENCES, CRATE WALLS, BALES OF HAY AND SIMILAR MATERIAL CAN BE USED TO CONTROL AIR CURRENTS AND SOIL BLOWING. BARRIERS PLACED AT RIGHT ANGLES TO PREVAILING CURRENTS AT INTERVALS OF ABOUT 15 TIMES THEIR HEIGHT ARE EFFECTIVE IN CONTROLLING WIND EROSION.

B. PERMANENT METHODS

PERMANENT VEGETATION
SEE STANDARD FOR PERMANENT SEEDING, AND PERMANENT STABILIZATION WITH SOD. EXISTING TREES AND LARGE SHRUBS MAY AFFORD VALUABLE PROTECTION IF LEFT IN PLACE.

 $\frac{\text{TOPSOILING}}{\text{THIS ENTAILS COVERING THE SURFACE WITH LESS EROSIVE SOIL MATERIAL.} \ \ \text{SEE TOPSOILING}.$

STONE COVER SURFACE WITH CRUSHED STONE OR COARSE GRAVEL.

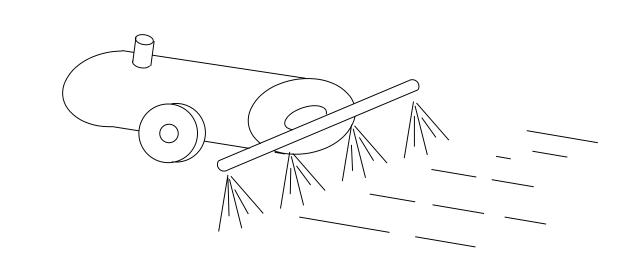

MULCHING MATERIAL

1. DRY STRAW OR HAY SHALL BE APPLIED AT A DEPTH OF 2 TO 4 INCHES PROVIDING COMPLETE SOIL

2. WOOD WASTE (CHIPS, SAWDUST, OR BARK) SHALL BE APPLIED AT A DEPTH OF 2 TO 3 INCHES. ORGANIC MATERIAL FROM THE CLEARING STAGE OF DEVELOPMENT SHOULD REMAIN ON SITE, BE CHIPPED, AND APPLIED AS MULCH.

3. CUTBACK ASPHALT 9SLOW CURING) SHALL BE APPLIED AT 1200 GALLONS PER ACRE (OR 1/4 GALLON PER SQ.

4. POLYETHYLENE FILM SHALL BE SECURED OVER BANKS OR STOCKPILED SOIL MATERIAL FOR TEMPORARY

APPLYING MULCH

1. DRY STRAW OR HAY MULCH AND WOOD CHIPS SHALL BE APPLIED UNIFORMLY BY HAND OR BY MECHANICAL EQUIPMENT.

2. IF THE AREA WILL EVENTUALLY BE COVERED WITH PERENNIAL VEGETATION, 20-30 POUNDS OF NITROGEN PER ACRE IN ADDITION TO THE NORMAL AMOUNT SHALL BE APPLIED TO OFFSET THE UPTAKE OF NITROGEN CAUSED BY DECOMPOSITION OF THE ORGANIC MULCHES.

3. CUTBACK ASPHALT SHALL BE APPLIED UNIFORMLY. CARE SHOULD BE TAKEN IN AREAS OF PEDESTRIAN TRAFFIC DUE TO PROBLEMS OF "TRACKING IN" OR DAMAGE TO SHOES, CLOTHING, ETC.

4. APPLY POLYETHYLENE FILM ON EXPOSED AREAS.

ANCHORING MULCH

1. STRAW OR HAY MULCH CAN BE PRESSED INTO THE SOIL WITH A DISK HARROW WITH THE DISK SET STRAIGHT OR WITH A SPECIAL "PACKER DISK." DISKS MAY BE USED SMOOTH OR SERRATED AND SHOULD BE 20 INCHES APART. THE EDGES OF THE DISK SHOULD BE DULL ENOUGH NOT TO CUT THE MULCH BUT TO PRESS IT INTO THE SOIL LEAVING MUCH OF IT IN AN ERECT POSITION. STRAW OF HAY MULCH SHALL BE ANCHORED IMMEDIATELY AFTER APPLICATION.

STRAW OR HAY MULCH SPREAD WITH SPECIAL BLOWER-TYPE EQUIPMENT MAY BE ANCHORED WITH EMULSIFIED ASPHALT (GRADE AE-5 OR SS-1). THE ASPHALT EMULSION SHALL BE SPRAYED ONTO THE MULCH AS IT IS EJECTED FROM THE MACHINE. USE 100 GALLONS OF EMULSIFIED ASPHALT AND 100 GALLONS OF WATER PER TON OF MULCH. TACKIFERS AND BINDERS CAN BE SUBSTITUTED FOR EMULSIFIED ASPHALT. PLEASE REFER TO SPECIFICATION Tb -TACKIFERS AND BINDERS. PLASTIC MESH OR NETTING WITH MESH NO LARGER THAN ONE INCH BY ONE INCH SHALL BE INSTALLED ACCORDING TO MANUFACTURER'S SPECIFICATIONS.

2. NETTING OF THE APPROPRIATE SIZE SHALL BE USED TO ANCHOR WOOD WASTE. OPENING OF THE NETTING SHALL NOT BE LARGER THAN THE AVERAGE SIZE OF THE WOOD WASTE CHIPS.

3. POLYETHYLENE FILM SHALL BE ANCHOR TRENCHED AT THE TOP AS WELL AS INCREMENTALLY AS NECESSARY.

Polyethylene film

Straw or hay Wood waste, chips, sawdust, bark

Cutback asphalt

TABLE 1. Mulching Application Requirements

netting, etc.	recommendations	
INSTALLATION NOTES:		
INSTALL ALL OTHER REQU GRADE SITE, IF POSSIBLE FOR APPLYING AND AND	, TO PERMIT THE USE OF E	EQUIPMENT

1200 gal./acre, 1/4 gal./sq.

yd./ or see manufacturer's

Secure with soil, anchors,

ecommendations

See manufacturer's

2" to 4"

2" to 3"

4. APPLY STRAW OR HAY UNIFORMLY, AS SHOWN IN TABLE 1, BY HAND OR MECHANICAL EQUIPMENT, AND ANCHOR BY PRESSING INTO SOIL OR USING NETTING.

3. LOOSEN COMPACTED SOIL, IF POSSIBLE, TO A DEPTH OF 3

5. MULCH ON SLOPES GREATER THAN 3% SHOULD BE ANCHORED WITH EMULSIFIED ASPHALT (GRADE AE-5 OR SS-1) OR OTHER SUITABLE TACKIFIER. 6. WOOD WASTE ON SLOPES FLATTER THAN 3:1 DO NOT NEED

7. MULCH SHALL BE APPLIED TO ALL DISTURBED AREAS LEFT INACTIVE FOR FOURTEEN DAYS.

MAINTENANCE NOTES:

1. ADD MULCH AS NEEDED TO MAINTAIN THE SUGGESTED DEPTH. 2. IF ORGANIC MULCH IS TO BE LEFT AND INCORPORATED INTO THE SOIL, APPLY 20-30 POUNDS OF NITROGEN IN ADDITION TO THE FERTILIZER REQUIRED FOR VEGETATION.

DISTURBED AREA STABILIZATION

Ds1

(WITH MULCHING ONLY)

100% DESIGN. ISSUED FOR CONSTRUCTION

DESIGN PROFESSIONAL:

DAVID MORGAN, P.E.

LEVEL II CERTIFICATION

No.: 0000011643

EXPIRES: 06/03/2024

Know what's below.

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Dial 811

Or Call 800-282-7411

Α

D

С

DUST CONTROL

LIME AND FERTILIZER: AGRICULTURAL LIME IS REQUIRED UNLESS SOIL TESTS INDICATE OTHEWRWISE. APPLY AGRICULTURAL LIME AT A RATE OF ONE TON PER ACRE. GRADED AREAS REQUIRE LIME APPLICATION. SOILS CAN BE TESTED TO SEE IF FERTILIZER IS NEEDED. ON REASONABLY FERTILE SOILS OR SOIL MATERIAL, FERTILIZER IS NOT REQUIRED. FOR SOILS WITH VERY LOW FERTILITY, 500 TO 700 POUNDS OF 10-10-10 FERTILIZER OF THE EQUIVALENT PER ACRE (12-16 LBS/1000 SQ. FT.) SHALL BE APPLIED. FERTILIZER SHOULD BE APPLIED BEFORE LAND PREPARATION AND INCORPORATED WITH A DISK, RIPPER OR CHISEL.

SEEDING: REFER TO TEMPORARY SEEDING CHART THIS PAGE.

APPLY SEED UNIFORMLY BY HAND, CYCLONE SEEDER, DRILL, CULTIPACKER-SEEDER, OR HYDRAULIC SEEDER (SLURRY INCLUDING SEED AND FERTILIZER). DRILL OR CULTIPACKER SEEDERS SHOULD NORMALLY PLACE SEED ONE-QUARTER TO ONE-HALF INCH DEEP. APPROXIMATE DEPTH OF PLANTING IS TEN TIMES THE SEED DIAMETER. SOIL SHOULD BE RAKED LIGHTLY TO COVER SEED WITH SOIL IF SEEDING BY HAND.

Planting Dates

<u>Species</u>	Broadcast <u>Rates – PLS</u> Per <u>Acre</u>	Broadcast <u>Rates - PLS</u> Per 1000 <u>sq. ft.</u>	(d	Sol ate err ate	es, nis: es.)	line do sib	es ette le	ind ed bu	dice line It r	es nai	o ind rgir	dic nal	ate	ed
BARLEY			J	F	M	Α	Μ	J	J	Α	S	0	N	D
(Hordeum vulgare)										_				
alone	3 bu. (144 lbs.)	3.3 lb.												
in mixtures	½ bu. (24 lbs.)	0.6 lb.	L	F	М	Δ	М			Δ	S	0	N	D
LESPEDEZA,			ľ		141		141						<u> </u> '	
ANNUAL (lezpedeza striata)	40 lbs.	0.9 lb.		-										
alone	10 lbs.	0.2 lb.												
in mixtures		5.2 .5.	L	_	М	٨	М			_	S		N	Г
LOVEGRASS, WEEPING (Eragrostis curvula)					IVI		IVI	J			<u>.</u>	U	LN	
alone	4 lbs.	0.1 lb.												
in mixtures	2 lbs.	0.05 lb.	L.	_										
MILLET, BROWNTOP			J	r	М	A	М	J	J	A	S	0	L _N	ט
(Pancium fasciculatum)	40.15	0.0 #												
alone	40 lbs.	0.9 lb.												
in mixtures	10 lbs.	0.2 lb.	J	F	М	Α	М	J	J	Α	S	0	N	D
MILLET, PEARL (Pennesetum glaucum)														
	50 lbs.	1.1 lb.												
olone OATS			J	F	M	Α	М	J	J	Α	S	0	ĮN.	D
(Avena sativa)											_			
alone	4 bu. (128 lbs.)	2.9 lb.												
in mixtures	1 bu. (32 lbs.)	0.7 lb.	J	F	М	Α	М	J	J	Α	S	0	N	D
RYE														
(Secale cereale)	3 bu. (168 lbs.)	3.9 lb.								-				
alone	½ bu. (28 lbs.)	0.6 lb.												
in mixtures RYEGRASS, ANNUAL	72 bu. (20 ibs.)		J	F	М	Α	М	J	J	Α	S	0	N	D
(Lolium temulentum)						-								_
alone	40 lbs.	0.9 lb.	J	F	М	Α	М	J	J	Α	S	0	N	D
SUDANGRASS (Sorghum sudanese)					,									
alone	60 lbs.	1.4 lb.	J	F	М	Α	М	J	J	Α	S	0	N	D
WHEAT (Triticum aestivum)														
alone	3 bu. (180 lbs.)	4.1 lb.												
in mixtures	½ bu. (30 lbs.)	0.7 lb.												

TABLE 2. FERTILIZER REQUIREMENTS FOR TEMPORARY VEGETATION

Types of Species	Planting Year	Fertilizer (N-P-K)	Rate (Ibs./acre	N Top Dressing Rate (lbs./acre)
	First	6-12-12	1500	50-100
Cool season grasses	Second	6-12-12	1000	-
	Maintenance	10-10-10	400	30
	First	6-12-12	1500	0-50
Cool season grasses and legumes	Second	0-10-10	1000	-
	Maintenance	0-10-10	400	-
Temporary cover crops seeded alone	First	10-10-10	500	30
	First	6-12-12	1500	50-100
Warm season grasses	Second	6-12-12	800	50-100
	Maintenance	10-10-10	400	30

INSTALLATION NOTES:

- 1. INSTALL ALL E&SC MEASURES PRIOR TO APPLYING TEMPORARY VEGETATION.
- 2. GRADING OR SHAPING ARE NOT REQUIRED IF SLOPES CAN BE PLANTED WITH A HYDROSEEDER OR BY HAND-SEEDING.
- 3. SEEDBED PREPARATION IS NOT REQUIRED IF SOIL IS LOOSE AND NOT SEALED BY RAIN. 4. WHEN THE SOIL IS SEALED OR CRUSTED, IT SHOULD BE PITTED, TRENCHED OR SCARIFIED TO PROVIDE A PLACE FOR SEED
- TO LODGE AND GERMINATE.
- 5. AGRICULTURAL LIME IS NOT REQUIRED. 6. FERTILIZE LOW FERTILITY SOILS PRIOR TO OR DURING PLANTING AT THE RATE OF 500-700 LBS./ACRE OF 10-10-10 FERTILIZER OR EQUIVALENT (12-16 LBS./1000 SQ. FT.)
- 7. IT IS IMPERATIVE THAT YOU CHECK THE TAG ON THE BAG OF SEED TO VERIFY THE TYPE AND GERMINATION OF THE SEED TO
- 8. APPLY SEED BY HAND, CYCLONE SEEDER, DRILL OR HYDRO-SEEDER. SEED PLANTED WITH A DRILL SHOULD BE PLANTED
- ¼" ―½" DEEP. 9. APPLY IN ACCORDANCE WITH SPECIFICATIONS ON THE E&SC PLAN. IF INFORMATION IS NOT AVAILABLE, SELECT A TEMPORARY
- COVER FROM TABLE 1. 10. TEMPORARY COVER SHALL BE APPLIED TO ALL DISTURBED AREAS LEFT IDLE FOR 14 DAYS. (IF AN AREA IS LEFT IDLE FOR
- 6 MONTHS, PERMANENT COVER SHALL BE APPLIED.)

MAINTENANCE NOTE:

RE-SEED AREAS WHERE AN ADEQUATE STAND OF TEMPORARY VEGETATION FAILS TO EMERGE OR WHERE A POOR STAND EXISTS.

TABLE 1. SOME TEMPORARY PLANT SPECIES, SEEDING RATES AND PLANTING DATES

Species	Rates per 1,000 sq. ft.	Rates per Acre	Region M—L (Mountain, Blue Ridge, Ridges and Valley)	Region P (Southern Piedmont	Region C (Southern Coastal Plain, Sand Hills, Black Lands and Atlantic Coastal Flatwoods)
Barley alone	3.3 lbs.	3 bu.			
Barley, in mixtures	0.6 lbs.	0.5 bu.	9 Sept. – 31 Oct.	15 Sept. – 15 Nov.	1 Oct. – 31 Dec.
Lespedeza, Annual	0.9 lbs.	40 lbs.	1 11- 71 11-	1 M. 71 M.	1 F.h. 20 F.h
Lespedeza, in mixtures	0.2 lbs.	10 lbs.	1 Mar. — 31 Mar.	1 Mar 31 Mar.	1 Feb. — 28 Feb.
Lovegrass, weeping	0.1 lbs.	4 lbs.			
Lovegrass, in mixtures	0.05 lbs.	2 lbs.	1 Apr. – 31 May	1 Apr. – 31 May	1 Mar. – 31 May
Millet, browntop	0.9 lbs.	40 lbs.			
Millet, in mixtures	0.2 lbs.	10 lbs.	15 Apr. – 15 Jun.	15 Apr. – 30 Jun.	15 Apr. – 30 Jun.
Millet, pearl	1.1 lbs.	50 lbs.	15 May - 15 Jul.	1 May — 31 Jul.	15 Apr. – 15 Aug.
Oats, alone	2.99 lbs.	4 bu.	45.0 . 45.0	45.0 . 45.1	
Oats, in mixtures	0.7 lbs.	1 bu.	15 Sept. – 15 Nov.	15 Sept. – 15 Nov.	15 Sept. – 15 Nov.
Rye (grain), alone	3.9 lbs.	3 bu.			
Rye, in mixtures	0.6 lbs.	0.5 bu.	15 Aug. – 31 Oct.	15 Sept. – 30 Nov.	1 Oct. – 31 Dec.
Ryegrass	0.9 lbs.	40 lbs.	15 Aug. – 15 Nov.	1 Sept. – 15 Dec.	15 Sept 31 Dec.
Sudangrass	1.4 lbs.	60 lbs.	1 May - 31 Jul.	1 May - 31 Jul.	1 Apr. – 31 Jul.
Triticale, alone	3.3 lbs.	3 bu.			
Triticale, in mixtures	0.6 lbs.	0.5 bu.	_	_	15 Oct. – 30 Nov.
Wheat, alone	4.1 lbs.	3 bu.			
Wheat, in mixtures	0.7 lbs.	0.5 bu.	15 Sept. – 30 Nov.	1 Oct 15 Dec.	15 Oct 31 Dec.

- 1. UNUSUAL SITE CONDITIONS MAY REQUIRE HEAVIEW SEEDING RATES.
- 2. SEEDING DATES MAY NEED TO BE ALTERED TO FIT TEMPERATURE VARIATIONS AND LOCAL CONDITIONS.
- 3. FOR MAJOR LAND RESOURCE AREAS (MLRAS), SEE "TACKIFIERS AND BINDERS" OF THE MANUAL FOR EROSION AND SEDIMENT CONTROL IN GEORGIA, LATEST EDITION.
- 3. SEEDING RATES ARE BASED ON PURE LIVE SEED (PLS).

SEEDING SCHEDULE TEMPORARY COVER

DEFINITION

A PERMANENT VEGETATIVE COVER USING SODS ON HIGHLY ERODIBLE OR CRITICALLY ERODED LANDS.

THIS APPLICATION IS APPROPRIATE FOR AREAS WHICH REQUIRE IMMEDIATE VEGETATIVE COVERS, DROP INLETS, GRASS SWALES, AND WATERWAYS WITH INTERMITTENT FLOW.

PLANNING CONSIDERATIONS

CAN BE ESTABLISHED NEARLY YEAR-ROUND.

SODDING CAN INITIALLY BE MORE COSTLY THAN SEEDING, BUT THE ADVANTAGES JUSTIFY THE INCREASED INITIAL COSTS.

- IMMEDIATE EROSION CONTROL, GREEN SURFACE, AND QUICK USE. REDUCED FAILURE AS COMPARED TO SEED AS WELL AS THE LACK OF WEEDS
- SODDING IS PREFERABLE TO SEED IN WATERWAYS AND SWALES BECAUSE OF THE IMMEDIATE PROTECTION OF THE CHANNEL AFTER APPLICATION. SODDING MUST BE STAKED IN CONCENTRATED FLOW AREAS (SEE FIGURE 6-6.1) CONSIDER USING SOD FRAMED AROUND DROP INLETS TO REDUCE SEDIMENTS AND MAINTAINING THE GRADE.

CONSTRUCTION SPECIFICATIONS INSTALLATION SOIL PREPARATION

BRING SOIL SURFACE TO FINAL GRADE. CLEAR SURFACE OF TRASH, WOODY DEBRIS, STONES AND CLODS LARGER THAN 1". APPLY SOD TO SOIL SURFACES ONLY AND NOT FROZEN SURFACES, OR GRAVEL TYPE SOILS.TOPSOIL PROPERLY APPLIED WILL HELP GUARANTEE A STAND. DON'T USE TOPSOIL RECENTLY TREATED WITH HERBICIDES OR SOIL STERILANTS. MIX FERTILIZER INTO SOIL SURFACE. FERTILIZE BASED ON SOIL TESTS OR TABLE 6-6.1.

LAY SOD WITH TIGHT JOINTS AND IN STRAIGHT LINES. DON'T OVERLAP JOINTS. STAGGER JOINTS AND DO NOT STRETCH SOD (SEE FIGURE 6-6.2) ON SLOPES STEEPER THAN 3:1, SOD SHOULD BE ANCHORED WITH PINS OR OTHER APPROVED METHODS, INSTALLED SOD SHOULD BE ROLLED OR TAMPED TO PROVIDE GOOD CONTACT BETWEEN SOD AND SOIL. IRRIGATE SOD AND SOIL TO A DEPTH OF 4" IMMEDIATELY AFTER INSTALLATION. SOD SHOULD NOT BE CUT OR SPREAD IN EXTREMELY WET OR DRY WEATHER. IRRIGATION SHOULD BE USED TO SUPPLEMENT RAINFALL FOR A MINIMUM OF 2-3 WEEKS.


MATERIALS

SOD SELECTED SHOULD BE CERTIFIED. SOD GROWN IN THE GENERAL AREA OF THE PROJECT IS

- 1. SOD SHOULD BE MACHINE CUT AND CONTAIN 3/4" (+ OR 1/4") OF SOIL, NOT INCLUDING
- SHOOTS OR THATCH. 2. SOD SHOULD BE CUT TO THE DESIRED SIZE WITHIN + OR -5% TORN OR UNEVEN PADS
- SHOULD BE REJECTED. SOD SHOULD BE CUT AND INSTALLED WITHIN 36 HOURS OF DIGGING.
- 4. AVOID PLANTING WHEN SUBJECT TO FROST HEAVE OR HOT WEATHER IF IRRIGATION IS NOT
- 5. THE SOD TYPE SHOULD BE SHOWN ON THE PLANS OR INSTALLED ACCORDING TO TABLE 6-6.2. SEE FIGURE 6-4.1 FOR YOUR RESOURCE AREA. MAINTENANCE

RE-SOD AREAS WHERE AN ADEQUATE STAND OF SOD IS NOT OBTAINED. NEW SOD SHOULD BE MOWED SPARINGLY. GRASS HEIGHT SHOULD NOT BE CUT LESS THAN 2"-3" OR AS SPECIFIED (SEE FIGURE 6-6.2). APPLY ONE TON OF AGRICULTURAL LIME AS INDICATED BY SOIL TEST OR EVERY 4-6 YEARS. FERTILIZE GRASSES IN ACCORDANCE WITH SOIL TESTS OR TABLE 6-6.3

	FERTILIZE	R REQUIREMENTS	FOR SOD	
TYPES OF SPECIES	PLANTING YEAR	FERTILIZER (N-P-K)	RATE (lbs./acre)	NITROGEN TOP DRESSING RATE (lbs./acre)
COOL	FIRST	6-12-12	1500	50-100
SEASON	SECOND	6-12-12	1000	
GRASSES	MAINTENANCE	10-10-10	400	30
WARM	FIRST	6-12-12	1500	50-100
SEASON	SECOND	6-12-12	800	50-100
GRASSES	MAINTENANCE	10-10-10	400	30

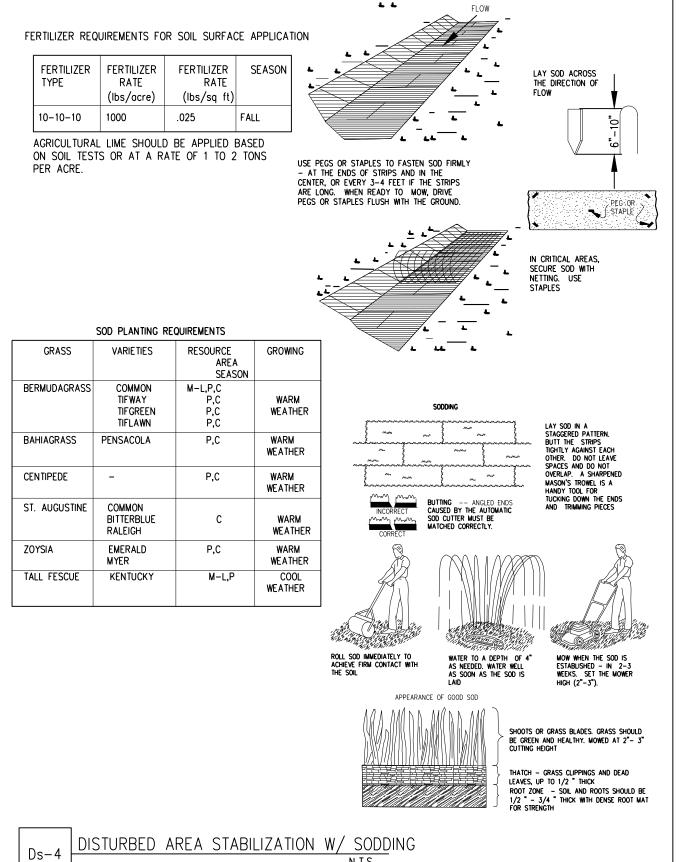

DISTURBED AREA STABILIZATION W/ SODDING
NO SCALE

Ds4

DESIGNED BY:

DRAWN BY: CHECKED BY: SUBMITTED BY: DATE: SEPTEMBER 1, 2022 PROJECT#

Peachtree Corners

Georgia 30092

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EOR/AOR SEAL

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FAYETTEVILLE, GA. 30214

DOWNING

COURT

CULVERT

REPLACEMENT

FAYETTE COUNTY, GA

DRAWING ISSUE

PROJECT NAME

SHEET TITLE

EROSION AND SEDIMENT CONTROL **DETAILS**

SHEET NUMBER

CE502 Know what's **below**. before you dig.

SHEET 14 OF 16 ORIGINAL SHEET SIZE:

22" X 34"


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DESIGN PROFESSIONAL: DAVID MORGAN, P.E. LEVEL II CERTIFICATION No.: 0000011643

EXPIRES: 06/03/2024

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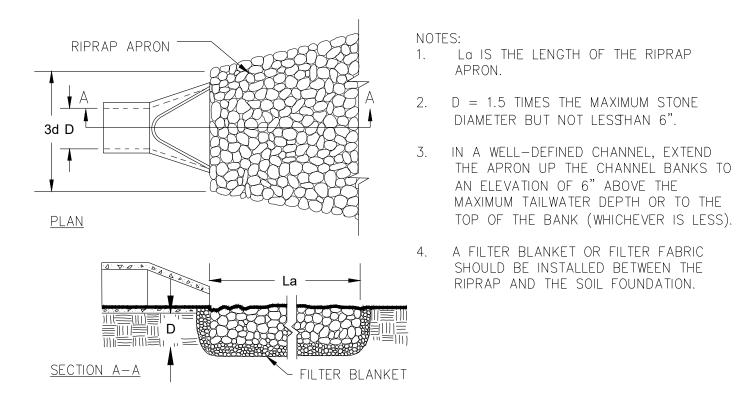
PIPE OUTLET TO FLAT AREA -- NO WELL DEFINED CHANNEL

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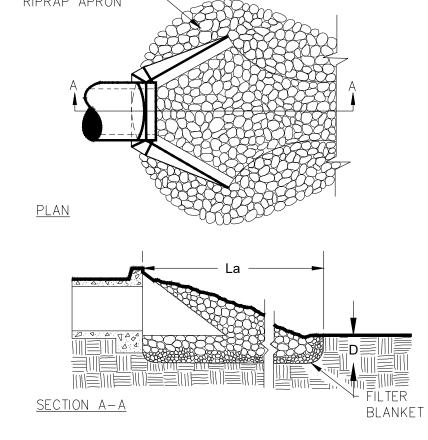
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PIPE OUTLET TO WELL DEFINED CHANNEL

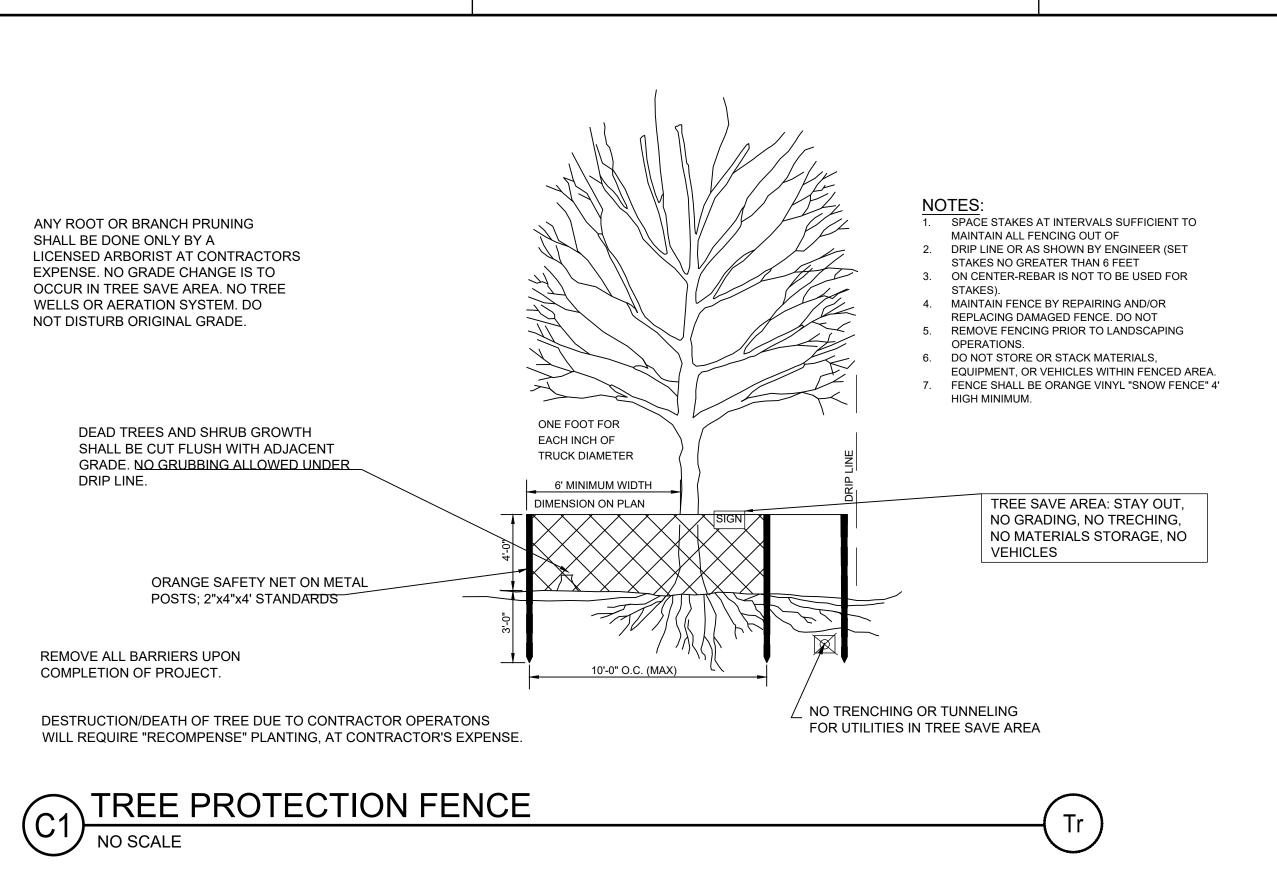

STORM DRAIN OUTLET PROTECTION

Suite 500

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PROJECT NAME

DOWNING COURT **CULVERT** REPLACEMENT

FAYETTE COUNTY, GA

DRAWING ISSUE


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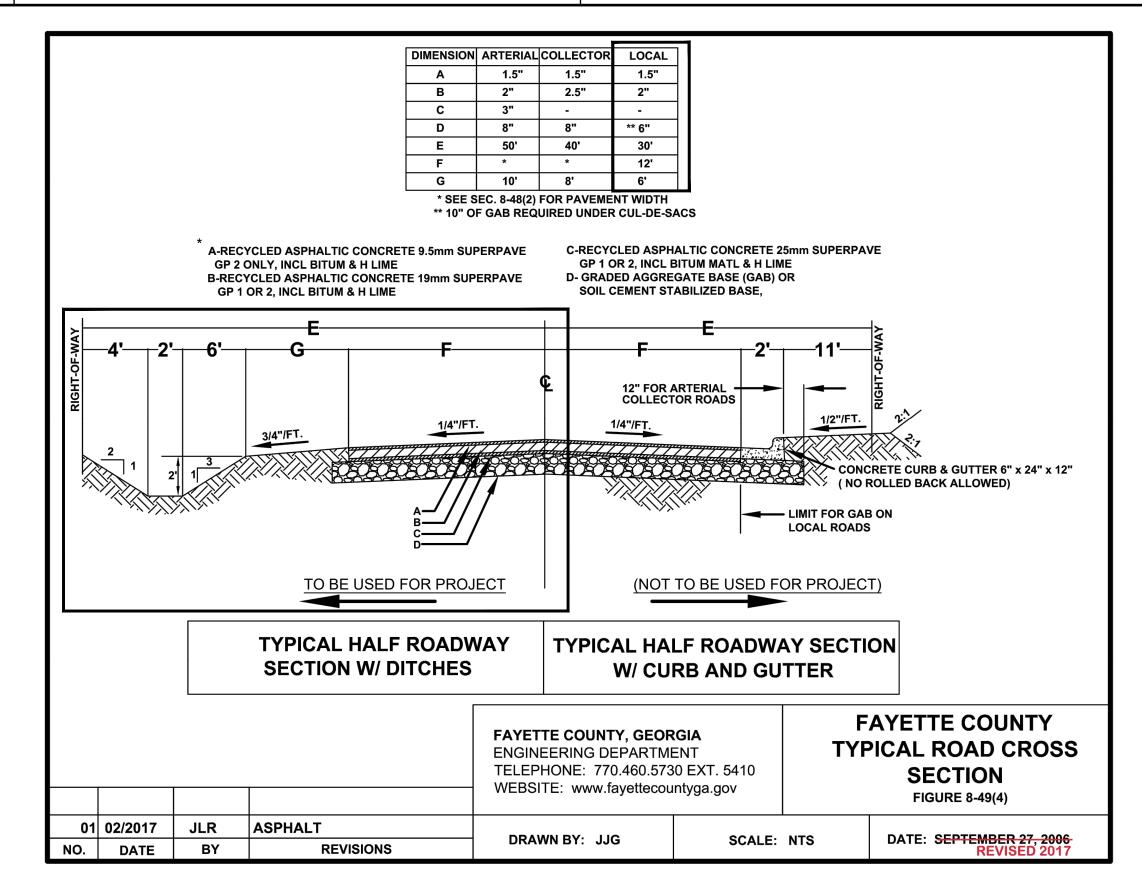
SHEET TITLE

EROSION AND SEDIMENT CONTROL **DETAILS**


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CE503




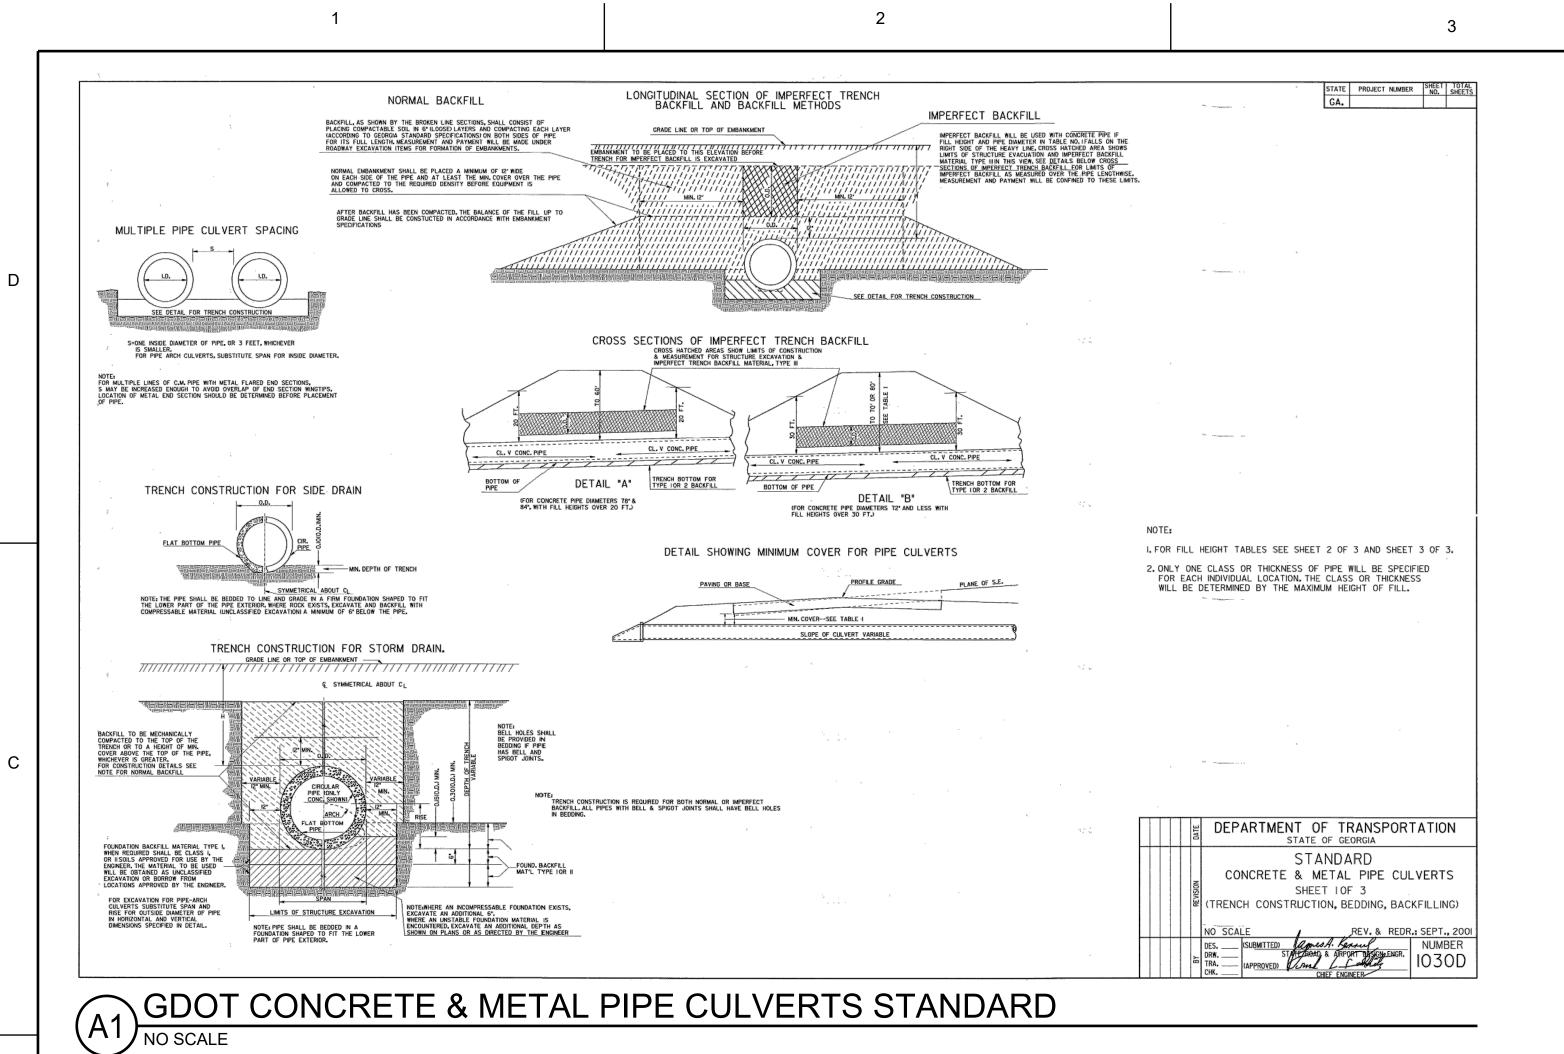

FAYETTE COUNTY TYPICAL ROAD CROSS SECTION
NO SCALE

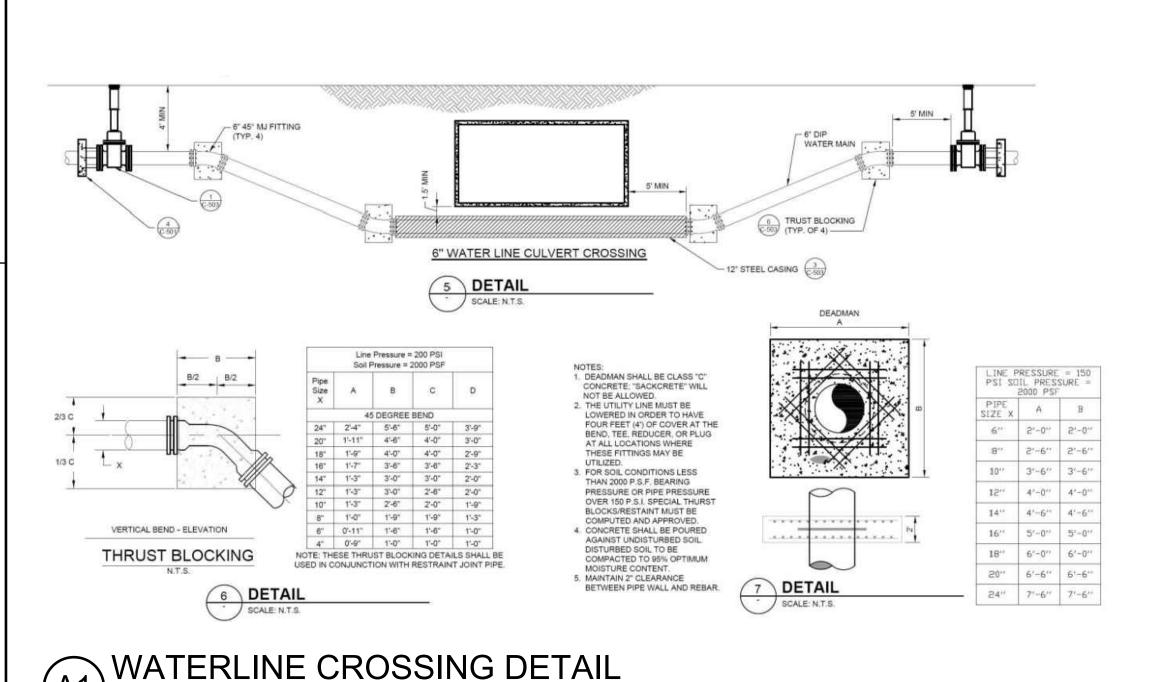

B1 FAYETTE COUNTY WATER DETAILS
NO SCALE

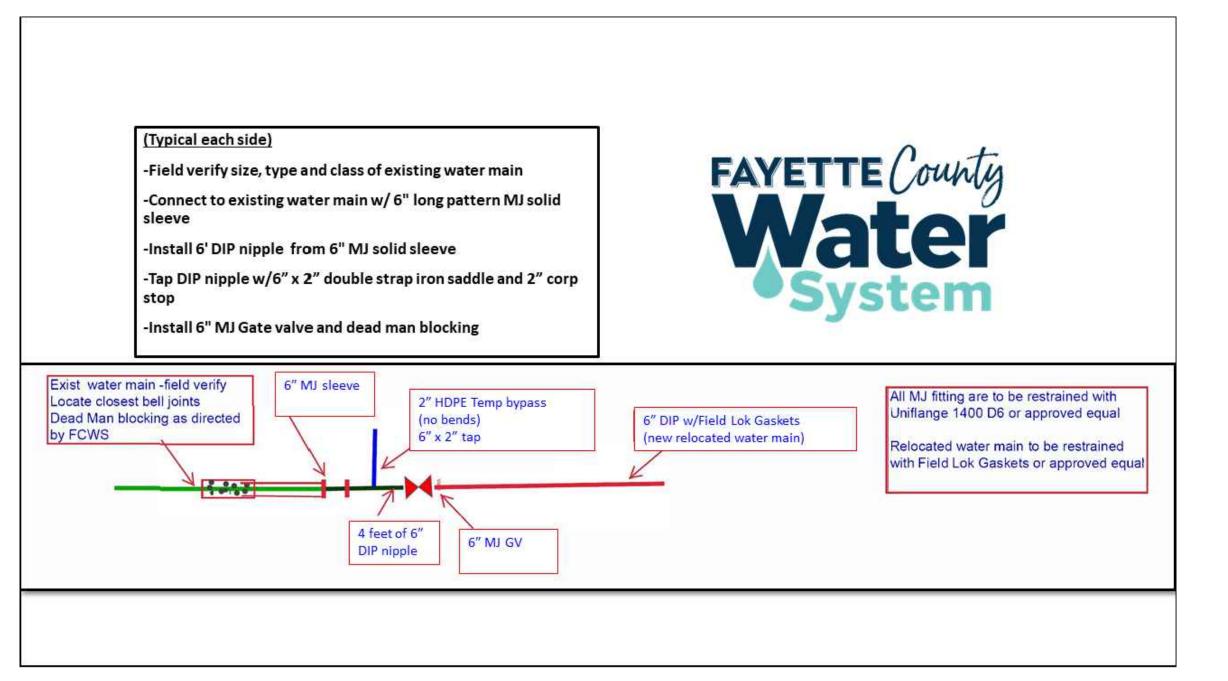

DMM/MDM

1210495

SHEET TITLE

Peachtree Corners

Georgia 30092

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DOWNING

COURT

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REPLACEMENT

FAYETTE COUNTY, GA

DRAWING ISSUE

C-501

SHEET 16 OF 16

DESIGNED BY:

CHECKED BY:

SUBMITTED BY:

PROJECT#

DATE: SEPTEMBER 1, 2022

CONSTRUCTION

DETAILS

DRAWN BY:

ORIGINAL SHEET SIZE: 22" X 34"

100% DESIGN. ISSUED FOR CONSTRUCTION

LE PATH: X:\FY21\1210495\04.CAD_BIM\04.02.CAD\C-501 PLOTTED BY: MURRAY, DANELLE DATE: 12/12/22

Α

В