

PLUMBING FIXTURE COUNT CALCULATION

IPC 2018 - BUSINESS OCCUPANCY - TOTAL OCCUPANT LOAD 73

MEN WC:
 $37 \text{ OCC.} / 25 = 1.48 = 2 \text{ WC REQUIRED} / 2 \text{ WC PROVIDED}$

WOMEN WC:
 $37 \text{ OCC.} / 25 = 1.48 = 2 \text{ WC REQUIRED} / 2 \text{ WC PROVIDED}$

MEN SINKS:
 $37 \text{ OCC.} / 40 = 0.925 = 1 \text{ SINK REQUIRED} / 2 \text{ SINKS PROVIDED}$

WOMEN SINKS:
 $37 \text{ OCC.} / 40 = 0.925 = 1 \text{ SINK REQUIRED} / 2 \text{ SINKS PROVIDED}$

HIGH AND LOW DRINKING FOUNTAIN : 1 REQUIRED / 1 PROVIDED

PROJECT PROPERTIES

PLAN REVIEW		BUILDING PROPERTIES	
1. OCCUPANCY CLASSIFICATION: (IBC) (NFPA 101)		NEW BUSINESS OCCUPANCY NEW BUSINESS OCCUPANCY	
2. CONSTRUCTION TYPE: (IBC) (NFPA 101)	A=PROTECTED B=UNPROTECTED	TYPE V-B TYPE V (000)	
3. AREA & HEIGHT LIMITATIONS: (IBC TABLE 503)		EXISTING 1 STORY BUILDING TOTAL TENANT AREA = +/- 5,416 S.F. MEASURED TO EXTERIOR FACE OF EXTERIOR WALL AND TO CENTER OF DEMISING WALL GROSS FLOOR AREA FOR OCCUPANT LOAD CALCULATION = +/- 5,180 SF	
4. OCCUPANT LOAD: (NFPA TABLE 7.3.1.2)		73 OCCUPANTS	
5. FIRE SUPPRESSION / ALARM: SUPPRESSION:		NOT SPRINKLERED FIRE ALARM NOT REQUIRED PER NFPA 101 SECTION 38.3.4.1	
6. FIRE PROTECTION REQUIREMENTS: (IBC TABLE 601)			
STRUCTURAL FRAME: COLUMNS & GIRDERS, BEAMS, TRUSSES 0 HOUR			
BEARING WALLS: EXTERIOR 0 HOUR INTERIOR 0 HOUR			
NONBEARING WALLS & PARTITIONS: EXTERIOR (SEE IBC TABLE 602) INTERIOR 0 HOUR			
FLOOR CONSTRUCTION: INCLUDING SUPPORTING BEAMS & JOISTS 0 HOUR			
ROOF CONSTRUCTION: INCLUDING SUPPORTING BEAMS & JOISTS 0 HOUR			
(IBC TABLE 602)			
FIRE-RESISTANT RATING FOR EXTERIOR WALLS: X < 5 N/A 5 ≤ X < 10 N/A 10 ≤ X < 30 N/A X ≥ 30 0 HOUR			
VERTICAL SHAFTS: (IBC 713 & NFPA 7.1.3.2, 8.6.5) N/A			
INCIDENTAL USE: (IBC TABLE 509) N/A			
TENANT SEPARATION: (IBC TABLE 508.4) EXISTING			
7. EXIT CAPACITY: (NFPA TABLE 7.3.3.1)		73 OCC./FLR. x 0.2 PER OCCUPANT = 14.6' REOD'-318" PROVIDED 3 X 68" CLEAR AT MAIN ENTRY PROVIDED 1 X 34" CLEAR AT MAIN ENTRY PROVIDED 1 X 34" CLEAR AT MAIN ENTRY PROVIDED 1 X 48" CLEAR AT MAIN ENTRY PROVIDED TOTAL 318" PROVIDED	
8. COMMON PATH, DEAD-END, & TRAVEL DISTANCE LIMITS: (NFPA TABLE 7.3.8)			
EXTERIOR COMMON PATH LIMIT:		75 FT. (NOT SPRINKLERED)	0 FT < 75 FT.
DEAD-END LIMIT:		20 FT. (NOT SPRINKLERED)	19'-10" FT < 20 FT
TRAVEL DISTANCE LIMIT:		200 FT. (NOT SPRINKLERED)	PATH-A +/-79'-2" < 200 FT. TO EXTERIOR OF BUILDING PATH-B +/-58'-6" < 200 FT. TO EXTERIOR OF BUILDING

GRAPHIC LEGEND

WALLS	DOORS
EXISTING WALL	8' CLR
PROPOSED 3-5/8" OT 6" MTL. STUD NON-RATED INTERIOR WALL	12" CLR
FIRE PROTECTION	** MINIMUM CLEARANCES REQUIRED ALONG ACCESSIBLE ROUTE
FEC: FIRE EXTINGUISHER CABINET INSTALLED AND MAINTAINED PER NFPA 10, MAX TRAVEL 75'	U.N.O
FIRE EXTINGUISHER CABINET SHALL NOT PROJECT MORE THAN 4" FROM THE WALL. (PROVIDE FIRE RATED CABINET IN FIRE RATED WALLS)	
WALL MOUNTED EXIT SIGN WITH EMERGENCY LIGHTING AND BATTERY BACKUP	
DIRECTIONAL CEILING MOUNTED EXIT SIGN	
SEE MEP DRAWINGS FOR EMERGENCY LIGHTING, STROBES, PULL DOWNS, POWER AND FIRE PROTECTION LAYOUT AND SYSTEMS	

FIRE PROTECTION NOTES

- SEE SHEETS F-101 FOR FIRE PROTECTION DETAILS.
- FIRE EXTINGUISHERS SHALL BE SELECTED, INSTALLED AND MAINTAINED IN ACCORDANCE WITH IBC SECTION 906.2 AND NFPA 10 FOR CLASS "A" FIRE HAZARD.
- ALL FIRE WALLS SHALL BE PERMANENTLY IDENTIFIED WITH STENCILING ABOVE ALL ACOUSTICAL CEILINGS WITH A MIN. 2" HEIGHT LETTERING AT A MAX. 12" O.C. W/ MIN. 1" PER WALL OR BARRIER. THE HOURLY RATING SHALL BE ON ALL RATED BARRIERS OR WALLS.

OCCUPANT LOAD CALCULATION

BUILDING GROSS FLOOR = +/-5,180 SF
 (DEFINITION PER 3.3.22.2.1 PER LIFE SAFETY NFPA 101 EDITION 2018)

ASSEMBLY USE OCCUPANCY FACTOR 15	ELECTION ROOM #101 (+/-321.4 SF (ELECTION BOOTHS)) PUBLIC OBSERVATION #103 +/-37.8 SF PUBLIC OBSERVATION #108 +/-52.4 SF LOBBY #125 +/-252.0 SF	TOTAL +/-663.6 SF / 15 = 45 OCCUPANTS
STORAGE OCCUPANCY FACTOR 150	STAGGING ROOM #117 +/-572.2 SF STORAGE #126 +/-107.3 SF	TOTAL +/-679.5 SF / 500 = 2 OCCUPANTS
BUSINESS OCCUPANCY FACTOR 150	TOTAL +/-5,180 SF - 663.6 SF - 679.5 SF = +/-3,836.9 SF / 150 = 26 OCCUPANTS	

TOTAL OCCUPANT LOAD 73

JEFFERSON

JEFFERSON BROWNE GRESHAM ARCHITECTS, INC.
 150 HIDDENSTONE ROAD, SUITE 1000
 PEACHTREE CITY, GEORGIA 30099
 770-432-9545
 JEFFERSONBROWNEARCHITECTS.COM

PRINT RECORD

#	DESCRIPTION	DATE	BY

FAYETTE COUNTY ELECTIONS OFFICE REMODEL

175 JOHNSON AVENUE
 FAYETTEVILLE, 30214 GEORGIA
 PROJECT #3142

STATE OF GEORGIA REGISTERED ARCHITECT

PAUL LEE GRESHAM
 REGISTERED NO. 03891

FINAL DRAWING FOR REVIEW PURPOSES ONLY
 Release Date: May 25, 2021

SEAL

LIFE SAFETY PLAN

DRAWING TITLE

© COPYRIGHT 2021 JEFFERSON BROWNE GRESHAM ARCHITECTS, INC. THIS DOCUMENT AS AN INSTRUMENT OF SERVICE REMAINS THE PROPERTY OF JEFFERSON BROWNE GRESHAM ARCHITECTS, AND NO PART THEREOF MAY BE REPRODUCED IN ANY FORM WITHOUT WRITTEN PERMISSION FROM JEFFERSON BROWNE GRESHAM ARCHITECTS.

Drawn By: SKLO
 Checked By: RIG
 PROJECT # 91-3142

A-005

BULLET PROOF TRANSATION WINDOW DETAILS

APPROVAL REQUIRED	PLEASE VERIFY	DRAWING NOTES
<input type="checkbox"/> APPROVED AS DRAWN	1. PLEASE SELECT ALUMINUM ANODIZE COLOR: <input type="checkbox"/> CLEAR <input checked="" type="checkbox"/> DARK BRONZE	1. THIS WILL BE FABRICATED & SHIPPED TO THE EXACT DIMENSION SHOWN.
<input type="checkbox"/> APPROVED AS NOTED	2. PLEASE SELECT GLAZING RATING: <input type="checkbox"/> U.L. LEVEL 1 <input type="checkbox"/> U.L. LEVEL 2 <input checked="" type="checkbox"/> U.L. LEVEL 3	2. ALL DIMENSIONS MUST BE APPROVED, SIGNED, DATED, OR OTHERWISE NOTED ON THIS DRAWING BEFORE FABRICATION CAN BEGIN.
<input type="checkbox"/> REJECTED	3. CONTACT T.S.S. FOR LEVEL 4, 5 & 7-8 OPTIONS (LEVEL 3 MEETS LEVEL 6 REQUIREMENTS)	3. FINISHED OPENING SIZE: 36 1/4" x 36 1/4"
SIGNATURE: _____	4. PLEASE SELECT GLAZING MATERIAL TYPE: <input type="checkbox"/> UNCOATED ACRYLIC (LVL 1 & 2 ONLY) <input type="checkbox"/> ABRASION RESISTANT ACRYLIC (LVL 1, 2, & 3) <input type="checkbox"/> LAMINATED POLYCARB. / ACRYLIC (LVL 1, 2, & 3) <input checked="" type="checkbox"/> GLASS CLAD POLYCARBONATE (LVL 1, 2, & 3)	4. VOICE PORT WILL BE CENTERED IN UNIT, UNLESS OTHERWISE SPECIFIED (TYP. 60" A.F.F.).
DATE: _____	5. PLEASE SELECT COUNTER TOP MATERIAL: <input checked="" type="checkbox"/> BLACK PLASTIC LAMINATE <input type="checkbox"/> 18 GA. S/S - #4 FIN.	5. ALUMINUM COLOR MUST BE SPECIFIED FOR THE ENGINEERING TO BEGIN.
IN THE EVENT OF CONFLICTS OR DISCREPANCIES AMONG THE CONTRACT DOCUMENTS, INTERPRETATIONS WILL GIVE PRIORITY TO THE TOTAL SECURITY SOLUTIONS APPROVAL DRAWINGS OVER THE PROPOSAL OR ANY OTHER DOCUMENT PROVIDED OR INCLUDED IN THE AGREEMENT.		


() UNIT(S) REQUIRED

BULLET PROOF OBSERVATION WINDOW DETAILS

REDUCER REQUIRED FOR THINNER GLAZING BUILD-UP

TSS-BL1.75 U.L. 752 LEVEL 1-3 & 6 FRAMING

EXTERIOR STOREFRONT ELEVATIONS

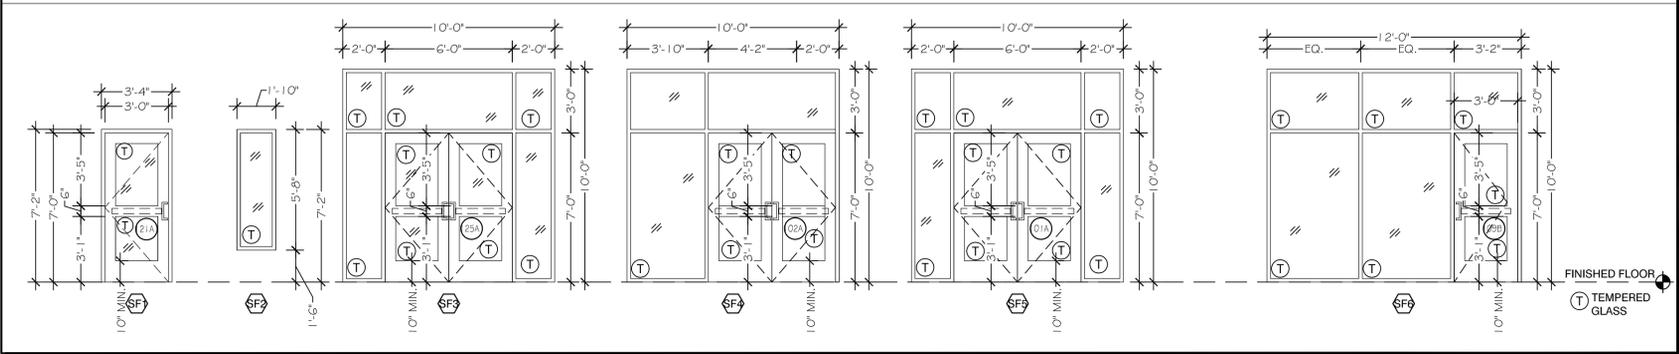

GENERAL GLAZING NOTES

- 1) USE INSULATION TO FILL ALL VOIDS @ WINDOW PERIMETERS.
- 2) PROVIDE FLASHING, BACKER ROD, SEALANT, AND WEEP WICKS AS REQ'D.
- 3) SHIM AND PLUMB UNITS AS REQUIRED.
- 4) PROVIDE STOREFRONT ENTRY AND WINDOWS SHOP DRAWINGS FOR ARCHITECT'S REVIEW AND APPROVAL.
- 5) SAFETY GLAZING IBC 2406.4.3 THRU 2406.4.7; GLAZING ADJACENT TO STAIRWAYS, LANDINGS AND RAMPS WITHIN 36 INCHES HORIZONTALLY OF A WALKING SURFACE; WHERE THE EXPOSED SURFACE OF THE GLASS IS LESS THAN 60 INCHES ABOVE THE PLANE OF THE ADJACENT WALKING SURFACE.
6. ALL WINDOW AND DOORS SHALL BE INSTALLED IN STRICT ACCORDANCE WITH SELECTED MANUFACTURER'S SPECIFICATIONS AND RECOMMENDATIONS.
7. G.C. TO VERIFY A WATERTIGHT CONDITION IS PRESENT THROUGHOUT FACILITY.
8. ALL HM & STOREFRONT FRAMES TO BE 2\"

STOREFRONT SPECIFICATION:

FRAMES: OLDCASTLE, 3000 SERIES, 2X 4 1/2\"/>

BULLET PROOF FRAMES SPECIFICATION:

BASE OF DESIGN OR APPROVE EQUAL:
TRANSATION WINDOW BP-1:
TSS HOLE AND TRANSATION WINDOW BY
TOTAL SECURITY SOLUTIONS, PH: 517-223-7807, FOWLERVILLE, MI
LEVEL 3, GLASS CLAD POLYCARBONATE, DARK BRONZE FINISH FRAME
OBSERVATION WINDOW BP-2:
WINDOW BY
TOTAL SECURITY SOLUTIONS, PH: 517-223-7807, FOWLERVILLE, MI
LEVEL 3, 1\"


EXTERIOR STOREFRONT SCHEDULE

ID #	SIZE		DOOR	INSULATING GLAZING	FRAME			SEE SHEET A-603 FOR DETAILS			REMARKS
	WIDTH	HEIGHT			FINISH	RATING	HEAD	JAMB	SILL		
SF1	3'-4"	7'-2"	YES	YES	BY MNF.	NO	H1	J1	S1		
SF2	1'-10"	5'-8"	NO	YES	BY MNF.	NO	H1	J1	S3		
SF3	10'-0"	10'-0"	NO	YES	BY MNF.	NO	H1	J1	S1,S2		
SF4	10'-0"	10'-0"	NO	YES	BY MNF.	NO	H1	J1	S1,S2		
SF5	10'-0"	10'-0"	NO	YES	BY MNF.	NO	H1	J1	S1,S2		
SF6	10'-0"	10'-0"	NO	YES	BY MNF.	NO	H1	J1	S1,S2		


HARDWARE SPECIFICATION:

GENERAL CONTRACTOR SHALL SUBMIT HARDWARE SUBMITTAL FOR ARCHITECT'S AND OWNER'S REVIEW AND APPROVAL. DO NOT PROCEED WITH ORDERING / PURCHASING WITHOUT ARCHITECT'S AND OWNER APPROVAL.

BULLET PROOF FRAMES ELEVATIONS

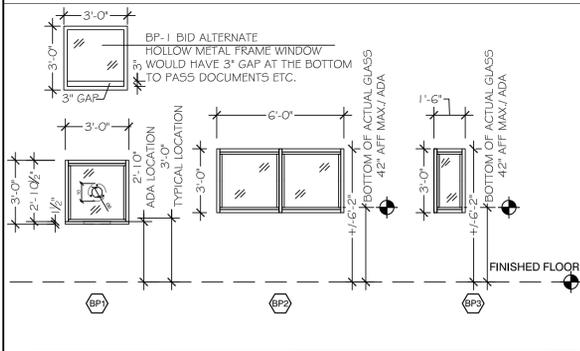

INTERIOR HOLLOW METAL FRAMES ELEVATIONS

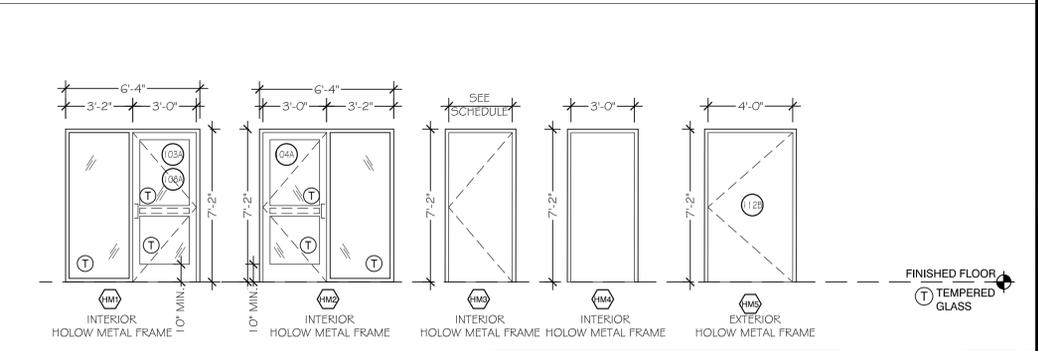

INTERIOR BULLET PROOF FRAMES SCHEDULE

ID #	SIZE		DOOR	INSULATING GLAZING	FRAME			REMARKS
	WIDTH	HEIGHT			FINISH	RATING	SEE SHEET A-603 FOR DETAILS	
BP1	3'-0"	3'-0"	NO	YES	DARK BRONZE	YES	BY MNF. BY MNF. BY MNF.	TRANSATION WINDOW
BP2	6'-0"	3'-0"	NO	YES	DARK BRONZE	YES	BY MNF. BY MNF. BY MNF.	OBSERVATION WINDOW
BP3	1'-6"	3'-0"	NO	YES	DARK BRONZE	YES	BY MNF. BY MNF. BY MNF.	OBSERVATION WINDOW

BID NOTE:
G.C. PROVIDE A BID ALTERNATE FOR BULLET PROOF WINDOWS TO BE STANDARD HOLLOW METAL FRAME WITH 1/4\"

HOLLOW METAL FRAMES SCHEDULE

ID #	SIZE		DOOR	INSULATING GLAZING	FRAME			SEE SHEET A-603 FOR DETAILS			REMARKS
	WIDTH	HEIGHT			FINISH	RATING	HEAD	JAMB	SILL		
HM1	6'-2"	7'-2"	YES	YES	BY MNF.	NO	H3,H4	J3,J4	S1,S5		
HM2	6'-2"	7'-2"	YES	YES	BY MNF.	NO	H3,H4	J3,J4	S1,S5		
HM3	3'-4"	7'-2"	YES	YES	BY MNF.	NO	H3	J3	S4		
HM4	3'-4"	7'-2"	YES	YES	BY MNF.	NO	H5	J5	-		
HM5	4'-4"	7'-4"	YES	YES	BY MNF.	NO	H5	J5	S1		

JEFFERSON

JEFFERSON BROWNE GRESHAM ARCHITECTS, INC.
150 HEDDLETON ROAD, SUITE 1000
PEACHTREE CITY, GEORGIA 30069
770-432-9545
JEFFERSONBROWNEARCHITECTS.COM

PRINT RECORD

#	DESCRIPTION	SHEET NO.	TOTAL SHEETS

FAYETTE COUNTY ELECTIONS OFFICE
REMODEL
175 JOHNSON AVENUE
FAYETTEVILLE, 30214 GEORGIA
PROJECT #3142



FINAL DRAWING
FOR REVIEW PURPOSES ONLY
Release Date: May 25, 2021

GLAZING SCHEDULE AND ELEVATIONS

DRAWING TITLE
A-602
91-3142

PRINT RECORD

#	DESCRIPTION	SHEET NO.	TOTAL SHEETS

FAYETTE COUNTY ELECTIONS OFFICE
REMODEL
175 JOHNSON AVENUE
FAYETTEVILLE, 30214 GEORGIA
PROJECT #3142

PROJECT



FINAL DRAWING
FOR REVIEW PURPOSES ONLY
Release Date: May 25, 2021

SEAL

INTERIOR
ELEVATIONS
AND
DETAILS

DRAWING TITLE

© COPYRIGHT 2021
JEFFERSON BROWNE GRESHAM ARCHITECTS, INC.
THIS DOCUMENT AS AN INSTRUMENT OF SERVICE REMAINS THE PROPERTY OF JEFFERSON BROWNE GRESHAM ARCHITECTS, INC. AND NO PART THEREOF MAY BE REPRODUCED IN ANY FORM WITHOUT WRITTEN PERMISSION FROM JEFFERSON BROWNE GRESHAM ARCHITECTS.


Drawn By:

Checked By:


PROJECT #

921-3142


A-701

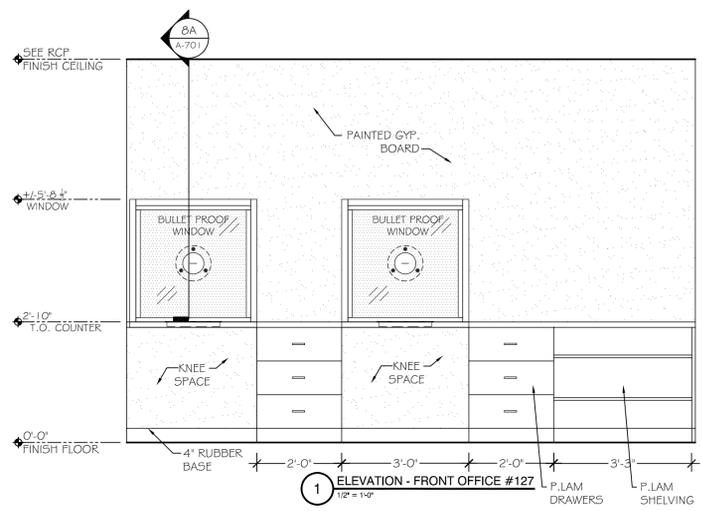


1 ELEVATION - FRONT OFFICE #127
1/2" = 1'-0"

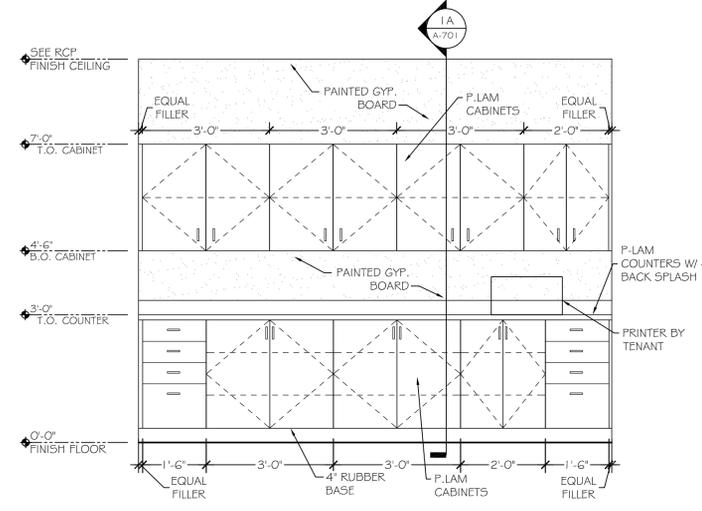

2 ELEVATION - FRONT OFFICE #127
1/2" = 1'-0"

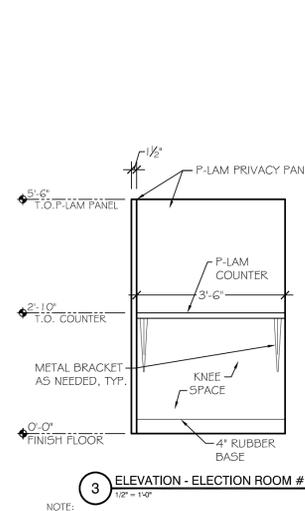


3 ELEVATION - ELECTION ROOM #101
1/2" = 1'-0"

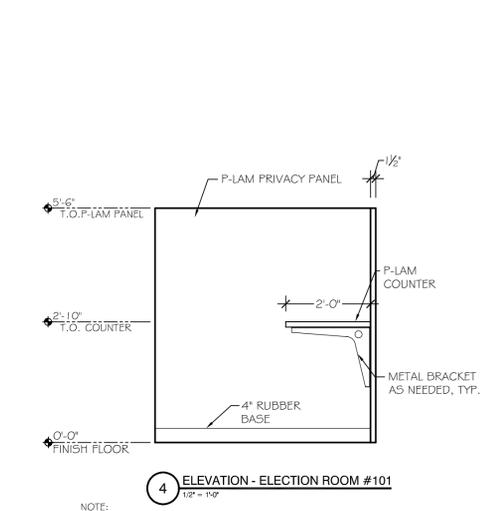


4 ELEVATION - ELECTION ROOM #101
1/2" = 1'-0"

NOTE: PRIVACY PANELS-G.C. PROVIDE SHOP DRAWINGS FOR ARCHITECT'S REVIEW AND APPROVAL. PROVIDE BID ALTERNATE #2,000 ALLOWANCE PER VOTING BOOTH FOR STANDARD OFFICE TYPE CUBICLE SYSTEM.


NOTE: PRIVACY PANELS-G.C. PROVIDE SHOP DRAWINGS FOR ARCHITECT'S REVIEW AND APPROVAL. PROVIDE BID ALTERNATE #2,000 ALLOWANCE PER VOTING BOOTH FOR STANDARD OFFICE TYPE CUBICLE SYSTEM.

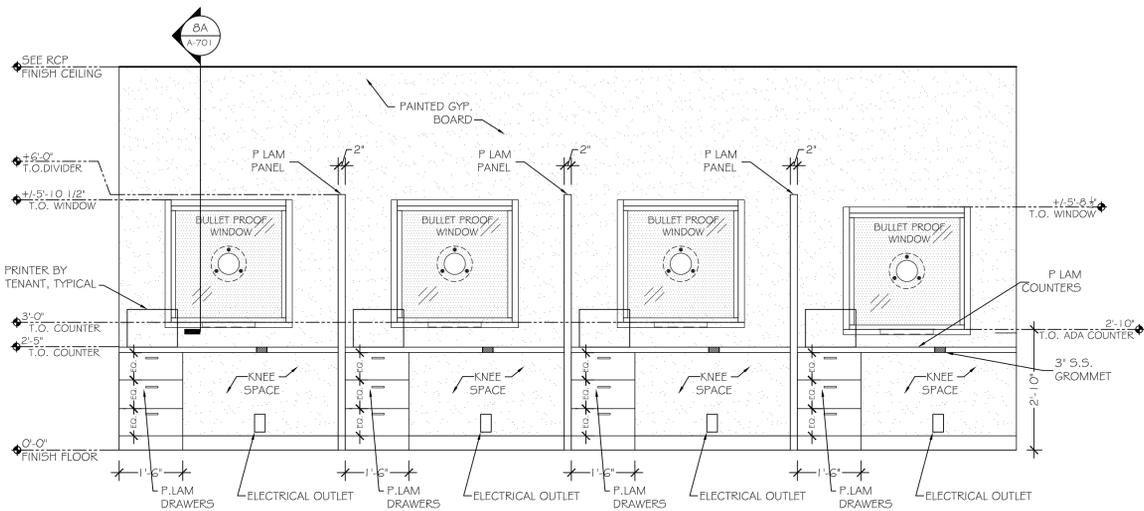


5 ELEVATION - FRONT OFFICE #105
1/2" = 1'-0"

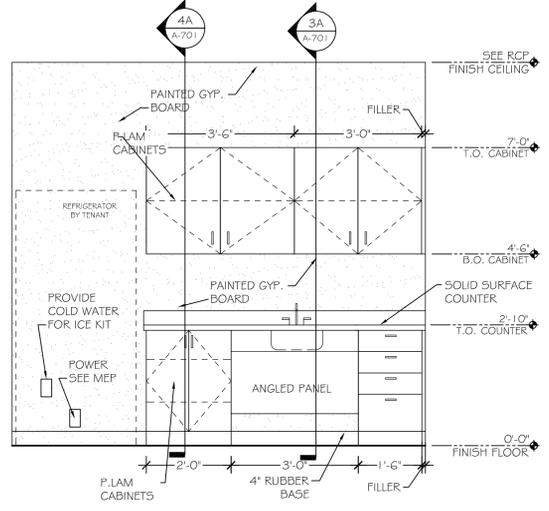


6 ELEVATION - CORRIDOR #116
1/2" = 1'-0"

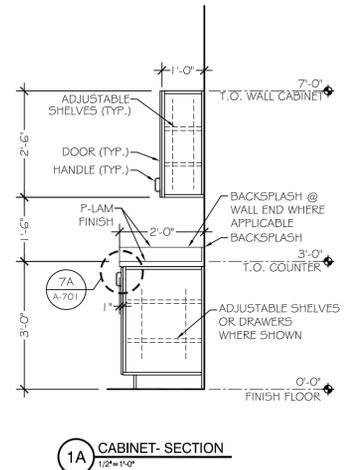


1A CABINET-SECTION
1/2" = 1'-0"

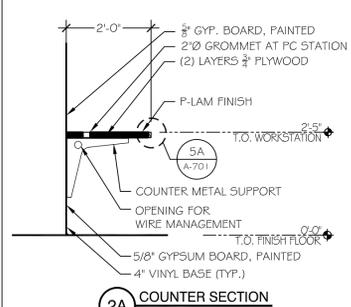


2A COUNTER SECTION
1/2" = 1'-0"

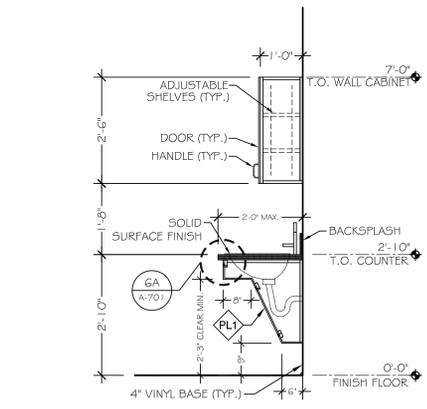


3A ADA SINK SECTION
1/2" = 1'-0"

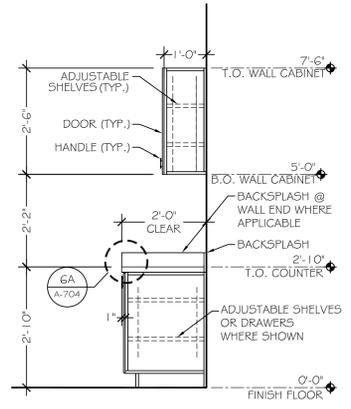


4A CABINET-SECTION
1/2" = 1'-0"

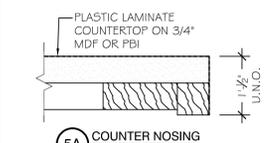


5A COUNTER NOSING
NTS

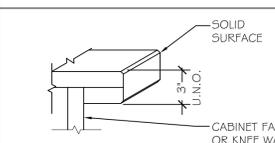

6A DOUBLE THICKNESS NOSING
NTS

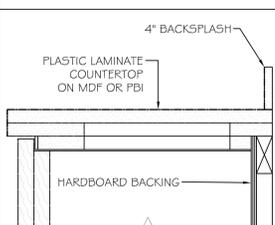

7A COUNTER TOP/BASE CABINET
NTS

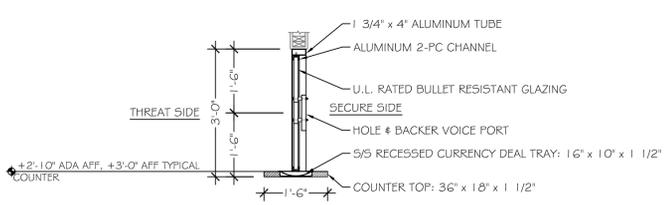

8A TYPICAL SECTION- BULLET PROOF WINDOW
1/2" = 1'-0"

NOTES:

- CABINETS SHOWN ARE SCHEMATIC ONLY, CONTRACTOR SHALL PROVIDE SHOP DRAWINGS PRIOR TO CONSTRUCTION FOR TENANT'S, ARCHITECT'S REVIEW AND APPROVAL.
- CONTRACTOR SHALL PROVIDE WOOD BACKING FOR ALL CABINETS, GRAB BARS, TV'S AND WALL MOUNTED RACKS/ HOOKS, ETC. PER APPLICABLE CODES.
- FOR ELECTRICAL OUTLETS AND DATA SEE ELECTRICAL DRAWINGS.
- ALL CABINETRY SHALL BE PROVIDED WITH ADJUSTABLE SHELVING. (TYP.)
- ALL CABINETRY SHALL BE 5-PLY INTERIOR GRADE FLUSH OVERLAY TYPE (TYP.) CONTRACTOR SHALL SUBMIT SUBSTITUTION FOR ARCHITECT'S APPROVAL.
- G.C. SHALL FIELD VERIFY ALL BUILT DIMENSIONS PRIOR TO FABRICATION OR INSTALLATION
- G.C. TO COORDINATE WITH INTERIOR DESIGN DRAWINGS IF PROVIDED. ALL FINAL CABINETRY DESIGN SHALL BE APPROVED BY OWNER.

#	DESCRIPTION	DATE	BY


FAYETTE COUNTY ELECTIONS OFFICE
REMODEL
175 JOHNSON AVENUE
FAYETTEVILLE, 30214 GEORGIA
PROJECT #3142




FINAL DRAWING
FOR REVIEW PURPOSES ONLY
Release Date: May 25, 2021

EXTERIOR ELEVATIONS - PRICING ONLY
BID ALTERNATE

© COPYRIGHT 2021 JEFFERSON BROWNE GRESHAM ARCHITECTS, INC. THIS DOCUMENT AS AN INSTRUMENT OF SERVICE REMAINS THE PROPERTY OF JEFFERSON BROWNE GRESHAM ARCHITECTS AND NO PART THEREOF MAY BE REPRODUCED IN ANY FORM WITHOUT WRITTEN PERMISSION FROM JEFFERSON BROWNE GRESHAM ARCHITECTS.
Drawn By: SKED
Checked By: RIG
PROJECT # 21-3142

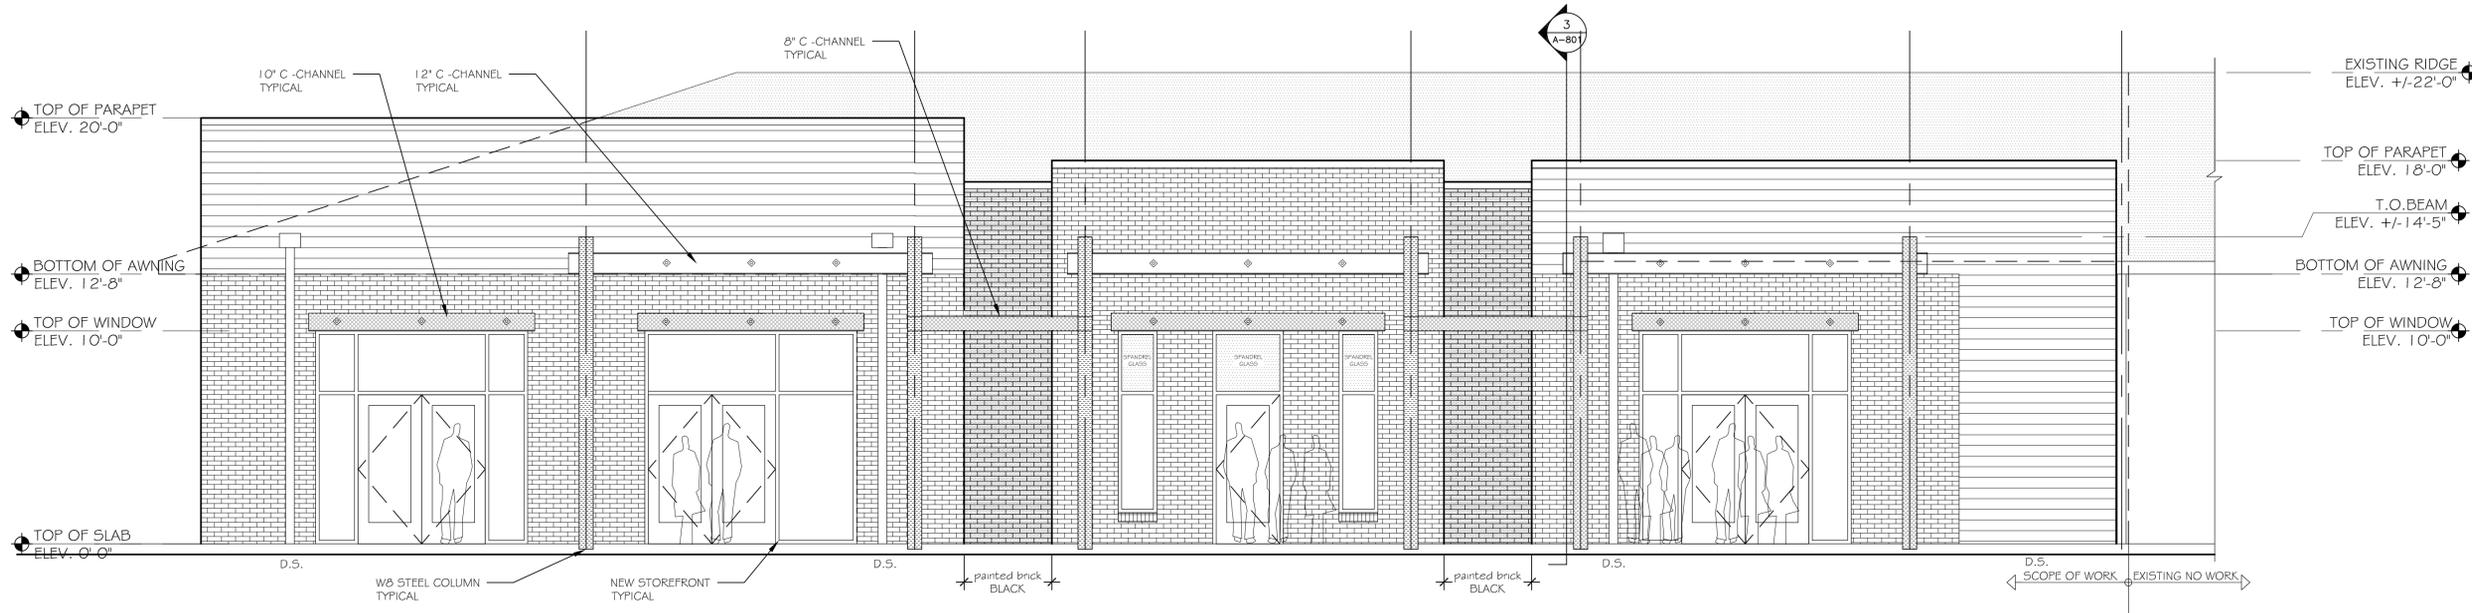

1 PROPOSED WEST ELEVATION - BID ALTERNATE
1/4" = 1'-0"

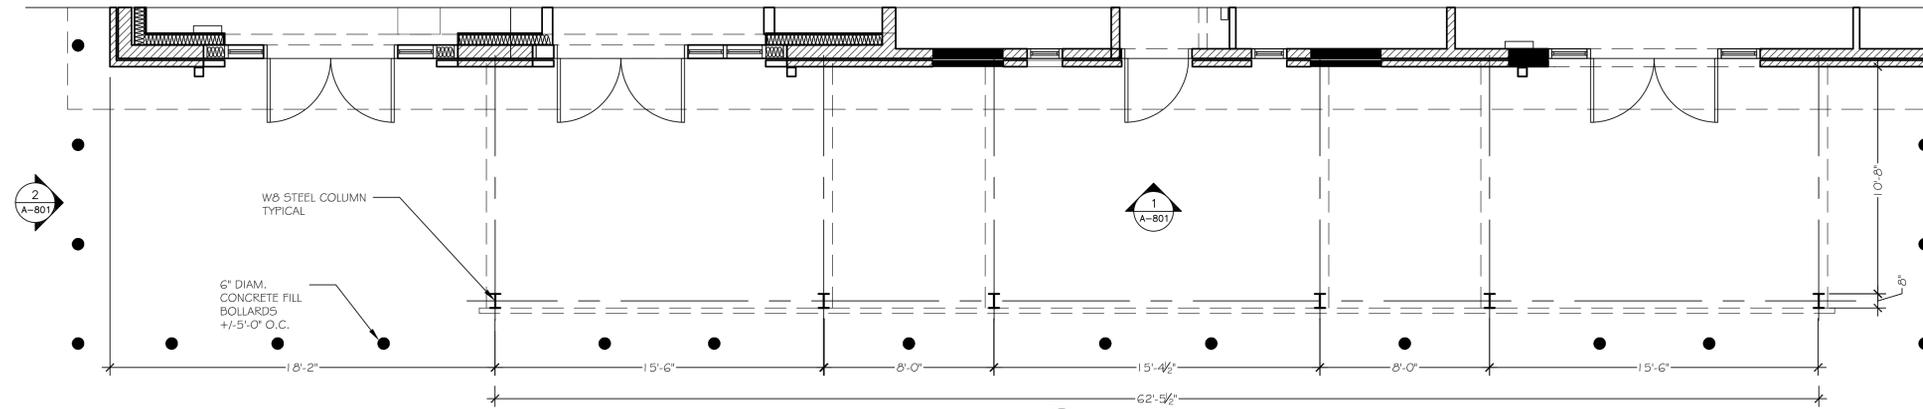


4 PARTIAL FLOOR PLAN
1/4" = 1'-0"


EXTERIOR FINISH LEGEND

- ALL STOREFRONT - DARK BRONZE FINISH
- PARAPET COPINGS - DARK BRONZE FINISH
- PRE-FINISHED DOWNSPOUTS, COLLECTOR HEADS, SCUPPERS - DARK BRONZE FINISH
- ALL NEW COLUMNS AND BEAMS TO BE PAINTED DARK BRONZE

- NEW BRICK TO MATCH EXISTING
- NEW AND EXISTING BRICK TO BE PAINTED BLACK
- CORRUGATED METAL PANEL
FINAL SPEC TO BE DETERMINED

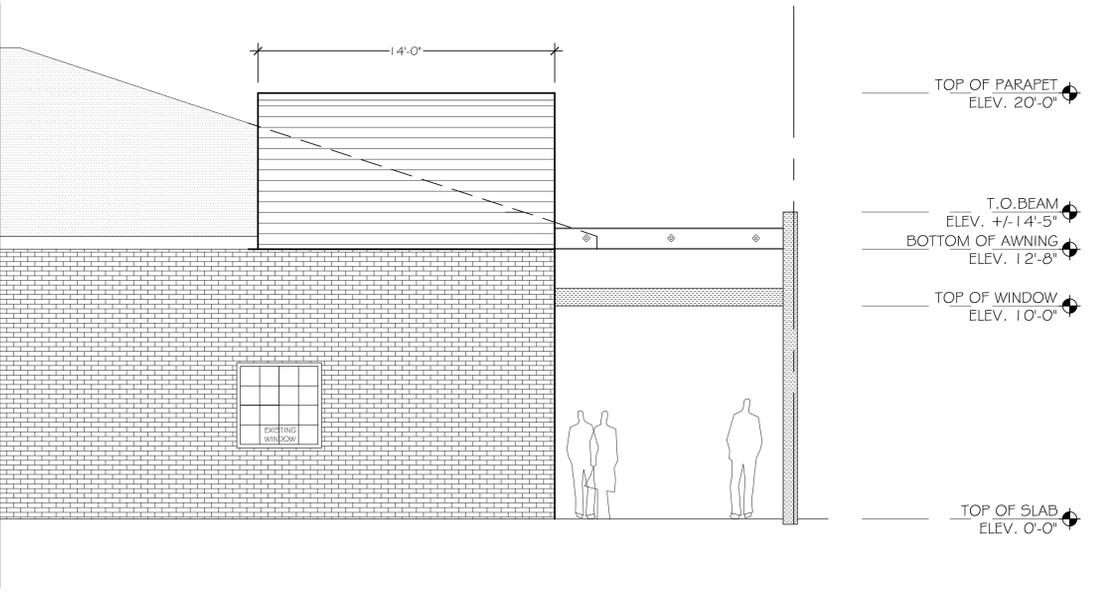

2 CORNER WEST ELEVATION - BID ALTERNATE
1/4" = 1'-0"

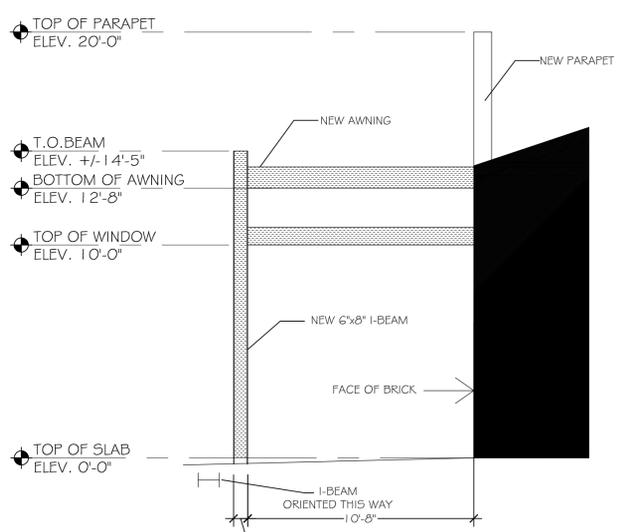

3 SCHEMATIC SECTION - BID ALTERNATE
1/4" = 1'-0"

BID COORDINATION NOTE
THIS BID ALTERNATE SCOPE IS FOR PRICING ONLY, NOT FOR CONSTRUCTION. ARCHITECTURAL SCOPE IS DEFINED ON THIS SHEET AND ON A-801A, A-801B, AND A-801C. FINAL STRUCTURAL ENGINEERING AND SPECIFICATIONS TO BE PROVIDED BY GC AS A DEFERRED SUBMITTAL IF THE ALTERNATE BUDGET PRICE IS ACCEPTED.



3D RENDERINGS FOR GENERAL REFERENCE ONLY. REFER TO THE CONSTRUCTION DOCUMENTS FOR SPECIFIC DIRECTION.

JEFFERSON_

JEFFERSON BROWNE GRESHAM ARCHITECTS, INC.
 130 HIDEOUT ROAD, SUITE 1000
 PEACHTREE CITY, GEORGIA 30099
 770-632-9545
 JEFFERSONBROWNEARCHITECTS.COM

PRINT RECORD

#	DESCRIPTION	DATE SHEET WAS REVISED

FAYETTE COUNTY ELECTIONS OFFICE
 REMODEL
 175 JOHNSON AVENUE
 FAYETTEVILLE, 30214 GEORGIA
 PROJECT #3142



FINAL DRAWING
 FOR REVIEW PURPOSES ONLY
 Release Date: May 25, 2021

3D RENDERING
 PRICING ONLY
 ALTERNATE BID

DRAWING TITLE
 © COPYRIGHT 2021
 JEFFERSON BROWNE GRESHAM ARCHITECTS, INC.
 THIS DOCUMENT AS AN INSTRUMENT OF SERVICE REMAINS THE PROPERTY OF JEFFERSON BROWNE GRESHAM ARCHITECTS AND NO PART THEREOF MAY BE REPRODUCED IN ANY FORM WITHOUT WRITTEN PERMISSION FROM JEFFERSON BROWNE GRESHAM ARCHITECTS.
 Drawn By: SKED
 Checked By: PLS
 PROJECT # 21-3142
 A-801B

